


Scenic Regional Library Wight City Branch 60 Wildcat Drive Wight City, MD63390

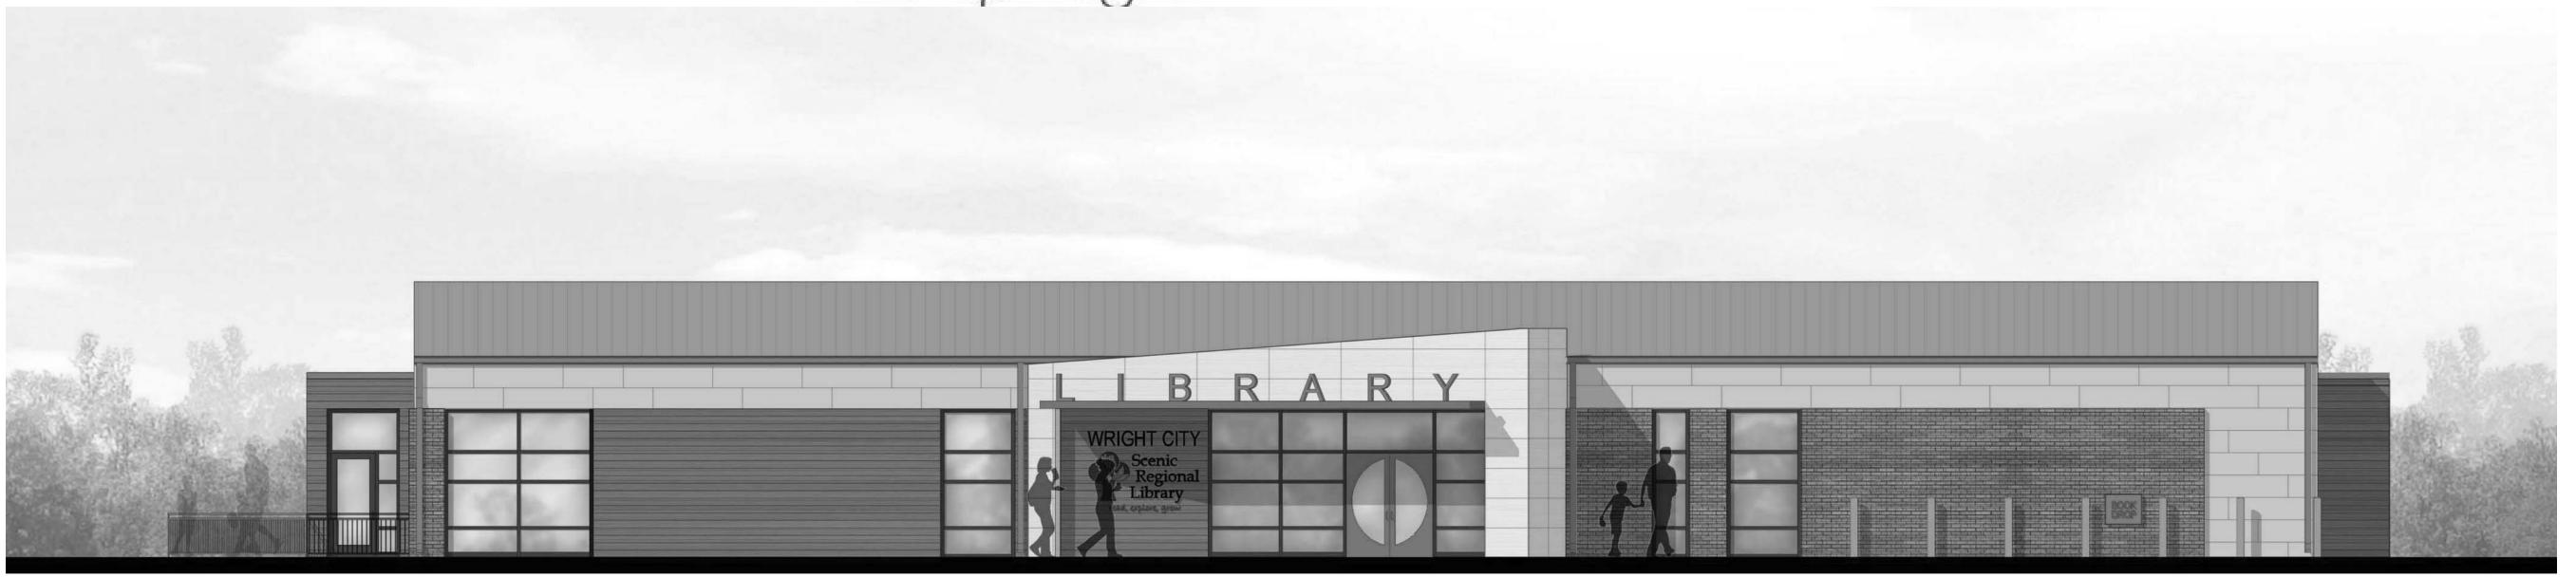

EAST ELEVATION (WILDCAT DR. ENTRY)

RATINGS

COLUMN

CORRIDOR

DOOR

FLOOR

STORAGE

RATING: 0 HOUR

OMNUTE

OMNUTE

0 HOUR

0 HOUR

DRAWING INDEX

CIVIL TITLE SHEET TOPOGRAPHIC SURVEY **DEMOLITION PLAN** C2 SITE PLAN C3 GRADING PLAN C4 UTILITY PLAN

D2 DETAIL SHEET L-1.0 LANDSCAPE SITE PLAN

D1 DETAIL SHEET

A-001 SYMBOLS AND ABBREVIATIONS A-002 LIFE SAFETY PLAN

A-101 ARCHITECTURAL SITE PLAN

A-102 ENLARGED ROOF PLANS AND ROOF DETAILS

A-103 SITE DETAILS

A-201 FLOOR PLAN - FIRST FLOOR A-301 ENLARGED FLOOR PLANS

A-302 ENLARGED FLOOR PLANS

A-401 RCP - FIRST FLOOR

A-402 ENLARGED CEILING PLANS

A-501 FINISH PLAN / LEGEND A-601 ELEVATIONS - EXTERIOR

A-602 ELEVATIONS - INTERIOR A-603 ELEVATIONS - INTERIOR

A-604 ELEVATIONS - INTERIOR

A-605 ELEVATIONS - INTERIOR A-701 BUILDING SECTIONS & BIRDS EYE SECTION VIEW

A-702 WALL SECTIONS

A-703 WALL SECTIONS

A-704 WALL SECTIONS

A-801 DETAILS - PLAN A-802 DETAILS - PLAN

A-803 DETAILS - BUILDING

A-804 DETAILS - BUILDING

A-805 DETAILS - BUILDING A-806 DETAILS

DRAWING INDEX

A-808 DETAILS

A-809 DETAILS - MILLWORK

A-810 DETAILS - MILLWORK

A-901 DOOR SCHEDULE / DOOR, FRAME AND WINDOW TYPES A-902 FRAME DETAILS

A-903 PARTITION TYPES

F-101 FURNITURE PLAN - FIRST FLOOR S-100 GENERAL NOTES

S-101 GENERAL NOTES

S-102 TYPICAL DETAILS

S-103 TYPICAL DETAILS

S-104 TYPICAL DETAILS

S-201 FOUNDATION PLAN S-202 ROOF FRAMING PLAN

S-300 FOUNDATION SECTIONS

S-400 FRAMING SECTIONS

S-500 BRACE FRAME ELEVATIONS

S-600 COLUMN SCHEDULE & DETAILS

M-001 LEGEND, SYMBOLS, NOTES & ABBREVIATIONS - MECH.

M-201 FLOOR PLAN - MECHANICAL

M-801 DETAILS - MECHANICAL M-901 SCHEDULE & SECTIONS - MECHANICAL

P-001 LEGEND, SYMBOLS, NOTES & ABBREVIATIONS - PLUMB.

P-200 FLOOR PLAN - FOUNDATION - PLUMBING P-201 FLOOR PLAN - PLUMBING

P-801 DETAILS - PLUMBING

E-001 LEGEND, SYMBOLS, NOTES & ABBREVIATIONS - ELEC.

E-100 SITE PLAN - ELECTRICAL EL-201 FLOOR PLAN & LIGHT FIXTURE SCHEDULE - ELECTRICAL

EP-301 FLOOR PLAN, ONE LINE & SCHEDULE - ELECTRICAL POWER

E-401 FLOOR PLAN - ELECTRICAL DATA

E-801 DETAILS - ELECTRICAL E-901 SCHEDULES - ELECTRICAL

CODE INFORMATION

<u>AUTHORITIES HAMING JURISDICTION:</u> CITY OF WRIGHT CITY, MO (WARREN COUNTY) WRIGHT CITY FIRE PROTECTION DISTRICT

BUILDING CODE: INTERNATIONAL BUILDING CODE (IBC) 2009 EDITION

ACCESSIBILITY: AVERICANS WITH DISABILITIES ACT

ICC/ANSI A117.1, REFERENCED BY BUILDING CODE

MECHANICAL: INTERNATIONAL MECHANICAL CODE (IMC) 2009 EDITION

PROPERTY MAINTENANCE: INTERNATIONAL PROPERTY MAINTENANCE CODE (IPVC) 2009 EDITION.

INTERNATIONAL FIRE CODE (IFC) 2009 EDITION

INTERNATIONAL PLUMBING CODE (IPC) 2009 EDITION

NATIONAL ELECTRICAL CODE, 2008 EDITION, WITH CITY ADDITIONS.

BULLDING INFORMATION

<u>USE GROUPS</u>

ASSEMBLY, LIBRARY MODERATE HAZARD STORAGE (ACCESSORY USE, SEE LIFE SAFETY PLAN, SHEET A-002)

NON-SPRINKLERED, NOT PROTECTED

SEISMC CATEGORY:

FIRE PREVENTION:

ELECTRICAL:

<u>PLUMBING:</u>

REFER TO CISCA GUIDELINES FOR REQUIREMENTS

FLOOR

ACTUAL GSF DESIGN OCCUPANCY:

FIRST FLOOR

195 OCCUPANTS

ALLOWABLE HEIGHT AND AREA: USE GROUP A-3 IS MOST RESTRICTIVE USE. ALLOWABLE HEIGHT AND AREA, IBC TABLE 503 - 2 STORIES AND 9,500 SF.

MCINTY MAP





LOCATOR MAP





ARCHITECT-OF-RECORD

JEWA 3005 LOCUST ST. ST. LOUIS, MD 63103 T (314) 531-7400 CONTACT: SCOTT CLARK E-MAIL: SOLARK@JEMASTL.COV

DESIGNARCHITECT

SAPP DESIGNASSOCIATES ARCHITECTS 3750 SOUTH FREMONT SPRINGFIELD, MO 65804 T (417) 877-9600 F (417) 877-9696 CONTACT: JAVES STUFFLEBEAV E: STUFFLEBEAM@SDAARCHTECTS.COV

GML ENGINEER

COCHRAN ENGINEERING 530A EAST INDEPENDENCE DRIVE UNION, MO 63084 T (636) 584-0540 F (636) 584-0512 CONTACT: DAVE VAN LEER E-MAIL: DVANLEER@COOHRAN.COV

STRUCTURAL ENGINEER

ALPERAUDI, INC. 1804 BORWAN CIRCLE DRIVE ST. LOUIS, MD 63146 T (314) 432-8600 CONTACT: STEVE EHRETT E-MAIL: STEVE.EHRETT@ALPERAUDI.COV

MECHANICAL, ELECTRICAL, PLUMBING ENGINEER

BRIC PARTNERSHIP, LLC 138 WEST ADAVIS KIRKWOOD, MO 63122 T (314) 725-5889 CONTACT: BRUCE COLEMAN E: BCOLEMAN@BRICPARTNERSHIP.COV





ARCHITECT-OF-RECORD ST. LOUS, MO63103 T (314) 531-7400 CONTACT: SCOTT CLARK E-MAIL: SOLARK@JEMASTL.COM

SAPP DESIGNASSOCIATES APOHITECTS 3750 SOUTH FREMONT SPRINGFIELD, MO 65804 T (417) 877-9600 CONTACT: JAMES STUFFLEBEAM E: STUFFLEBEAM@SDAARCHTECTS.COM

CCCCHRAN 530A E INDEPENDENCE DRIVE UNON, MO 63084 CONTACT: DAVE VAN LEER F (636) 584-0512 E-MAIL: DVANLEER@0000-RAN.COM

STRUCTURAL ALPERAUDI, INC. 1804 BORMAN GROLE DRIVE ST. LOUS, MO63146 T (314) 432-8600 F (314) 807-2774 CONTACT: STEVE EL RETT E-MAIL: STEVE. EI-PRETT@ALPERAUDI.COM

MECHANICAL ELECTRICAL PLUMBING BRICPARTINERSHIP, LLC 343 S. KIRKWOOD ROAD, SUITE 204 KIRKWOOD, MO63122 T (314) 725-5889 CONTACT: BRUCE COLEMAN E: BCOLEMAN@BRICPARTINERSHP.COM

ARCHITECT OF RECORD:

JOHN EDWARD MUELLER MO ARCHITECTURAL LICENSE A2010039554 MO CERTIFICATE OF AUTHORITY A2014008380

No.	Date	Description
	04/14/17	ISSUED FOR BID

DRAWNBY: SC/SH

PROJECT NUMBER: 16-1161.03

SHEET TITLE: **COVER SHEET**

OCHRAN

CONTACT INFORMATION OWNER OWNER: SCENIC REGIONAL LIBRARY REPRESENTATIVE: STEVEN CAMPBELL (DIRECTOR) ADDRESS: 304 HAWTHORNE DR. UNION, MO PHONE: (636) 583-0652 WATER/SEWER OWNER: CITY OF WRIGHT CITY REPRESENTATIVE: LARRY JANESH ADDRESS: 203 VETERANS MEMORIAL PKWY, WRIGHT CITY, MO PHONE: (636) 236-1687 **ELECTRIC** OWNER: CUIVRE RIVER ELECTRIC CO-OP REPRESENTATIVE: DAN SCHNEIDER ADDRESS: 8757 HWY N, LAKE ST. LOUIS, MO PHONE: (636) 695-4741 GAS OWNER: AMEREN REPRESENTATIVE: AMY TWELLMANN ADDRESS: 200 N. CALLAHAN RD. WENTZVILLE, MO PHONE: (636) 639-8305 **TELEPHONE OWNER: CHARTER COMMUNICATIONS** REPRESENTATIVE: LISA WARD ADDRESS: -PHONE: (314) 386-1634 SPECIAL NOTES: FOR QUESTIONS OR CLARIFICATION PLEASE CONTACT DAVID VAN LEER AT COCHRAN. PHONE #636-584-0540 VICINITY MAP NO SCALE

SITE IMPROVEMENT PLANS FOR SCENIC REGIONAL LIBRARY IN THE CITY OF WRIGHT CITY, MISSOURI 60 WILDCAT DRIVE

PROJECT NO. 16-6414



OTHERS RESPONSIBILITY-

-CONNECT TO EXISTING UNDERGROUND TELEPHONE.

UTILITY RESPONSIBILITY MATRIX FOR THIS PROJECT

WATER METER APPURTENANCES. PLACES SERVICE LINE FROM EXISTING WATER

CONTRACTOR RESPONSIBILITY-

-PLACE CONDUIT AND MULE TAPE FRO EXISTING TO TRANSFORMER. -PREPARES TRANSFORMER PAD.

PLACE CONDUIT AND WIRE FROM TRANSFORMER TO BUILDING.

PLACE BOLLARD PROTECTION WHERE REQUIRED

-install all gas lines on Building side of gas meter and connect to meter.

THIS MATRIX HAS BEEN PROVIDED FOR INFORMATIONAL PURPOSES. THE CONTRACTOR SHALL PROVIDE ANY AND ALL APPURTENANCES, TRENCHING AND BACKFILL, AND OTHER INCIDENTALS TO MEET OR EXCEED THE SPECIFICATIONS OF THE ITEMS LISTED.

MAIN TO BUILDING.

AGENCIES CONTACTS

CITY OF WRIGHT CITY 203 VETERANS MEMORIAL PKWY, WRIGHT CITY, MO

CONTACT: LARRY JANESH

PHONE: (636) 236-1687

CHARTER COMMUNICATIONS

CONTACT: LISA WARD PHONE: (314) 386-1634

CUIVRE RIVER ELECTRIC 8757 HWY N, LAKE ST. LOUIS, MO

CONTACT: DAN SCHNEIDER

PHONE: (636) 695-4741


200 N. CALLAHAN RD. WENTZVILLE, MO CONTACT: AMY TWELLMANN PHONE: (636) 639-8305

- CIVIL ENGINEERING
- LAND SURVEYING
- ARCHITECTURE
- SITE DEVELOPMENT
- MASTER PLANNING
- GENERAL CONSULTING

530A E. INDEPENDENCE DRIVE, UNION, MISSOURI 63084
TELEPHONE (636) 584-0540
FAX (636) 584-0512
E-MAIL mail@cochraneng.com

APRIL, 2017


SHEET INDEX	SHEET
TOPOGRAPHIC SURVEY DEMOLITION PLAN	T1 C1
SITE PLAN	C2
GRADING PLAN JTILITY PLAN	C3 C4
DETAIL SHEET DETAIL SHEET	D1 D2

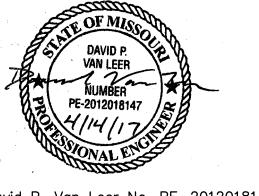



David P. Van Leer No. PE-2012018147 Registered Professional Engineer State of Missouri for Cochran

Two working days prior to the start of any excavation on this site, contractor shall call 1—800—DIG—RITE for utility location information.

All OSHA rules & regulations established for the type of construction required by these plans shall be strictly followed (ie. Trenching, Blasting, etc.)

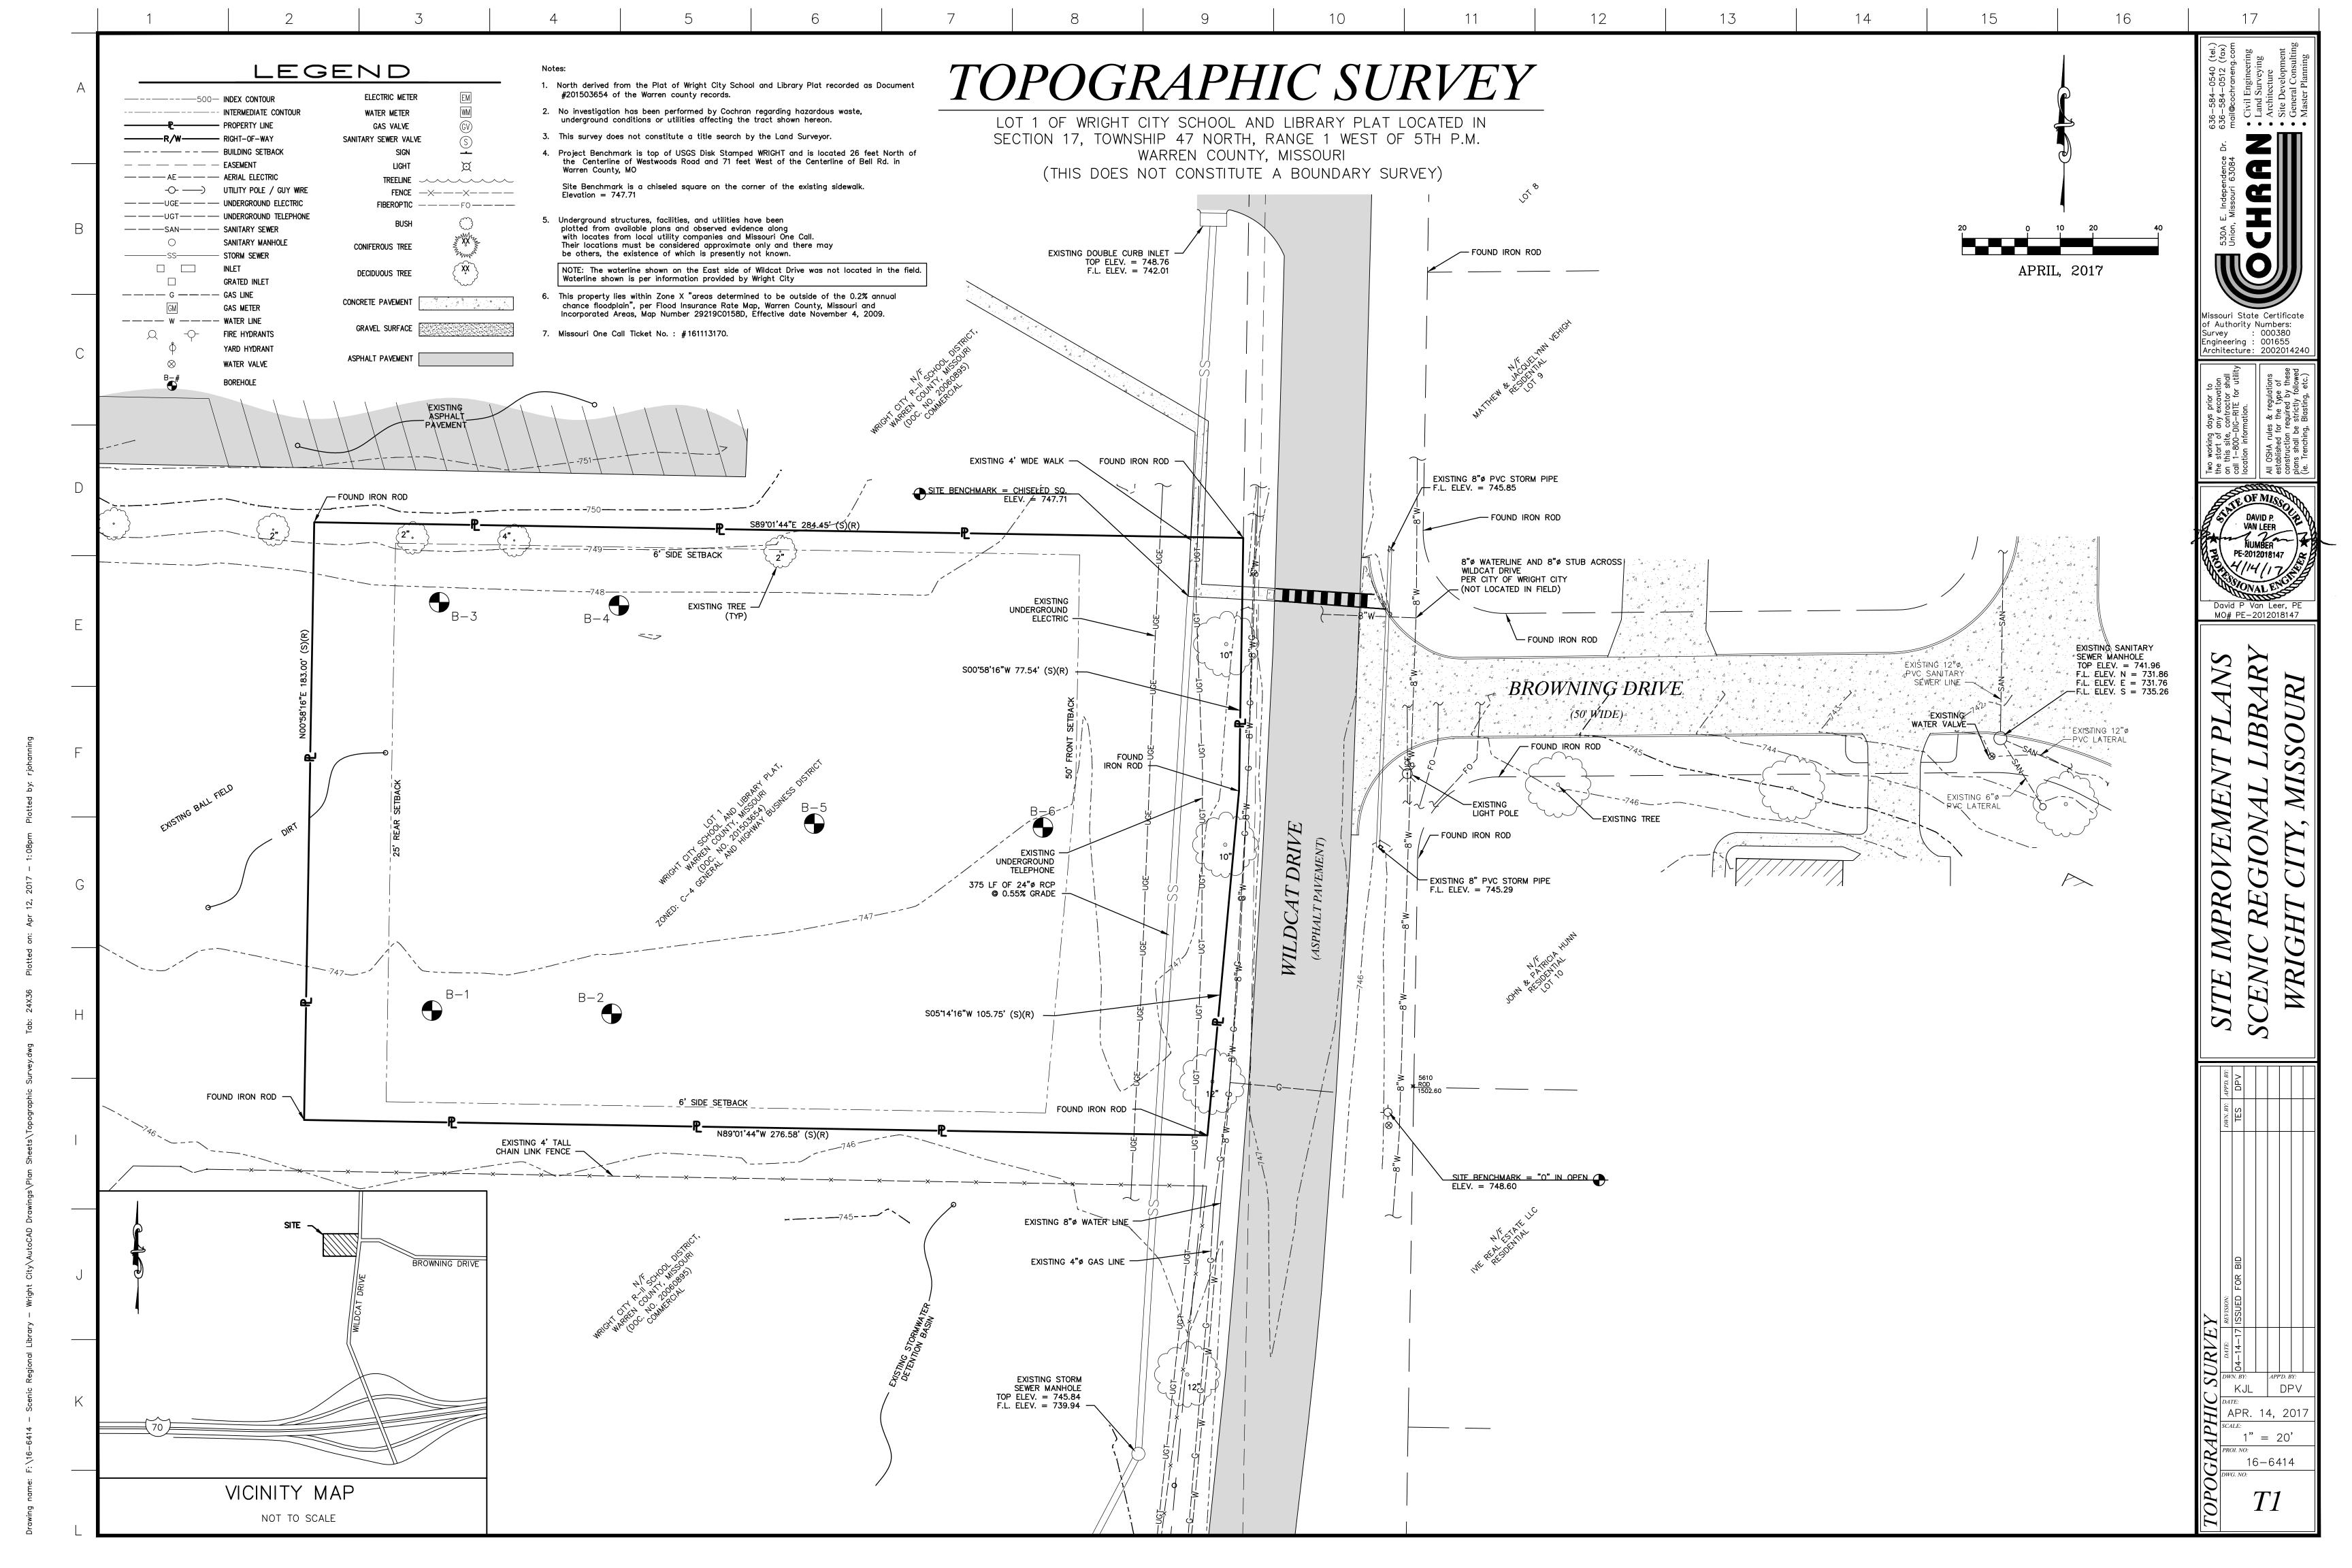

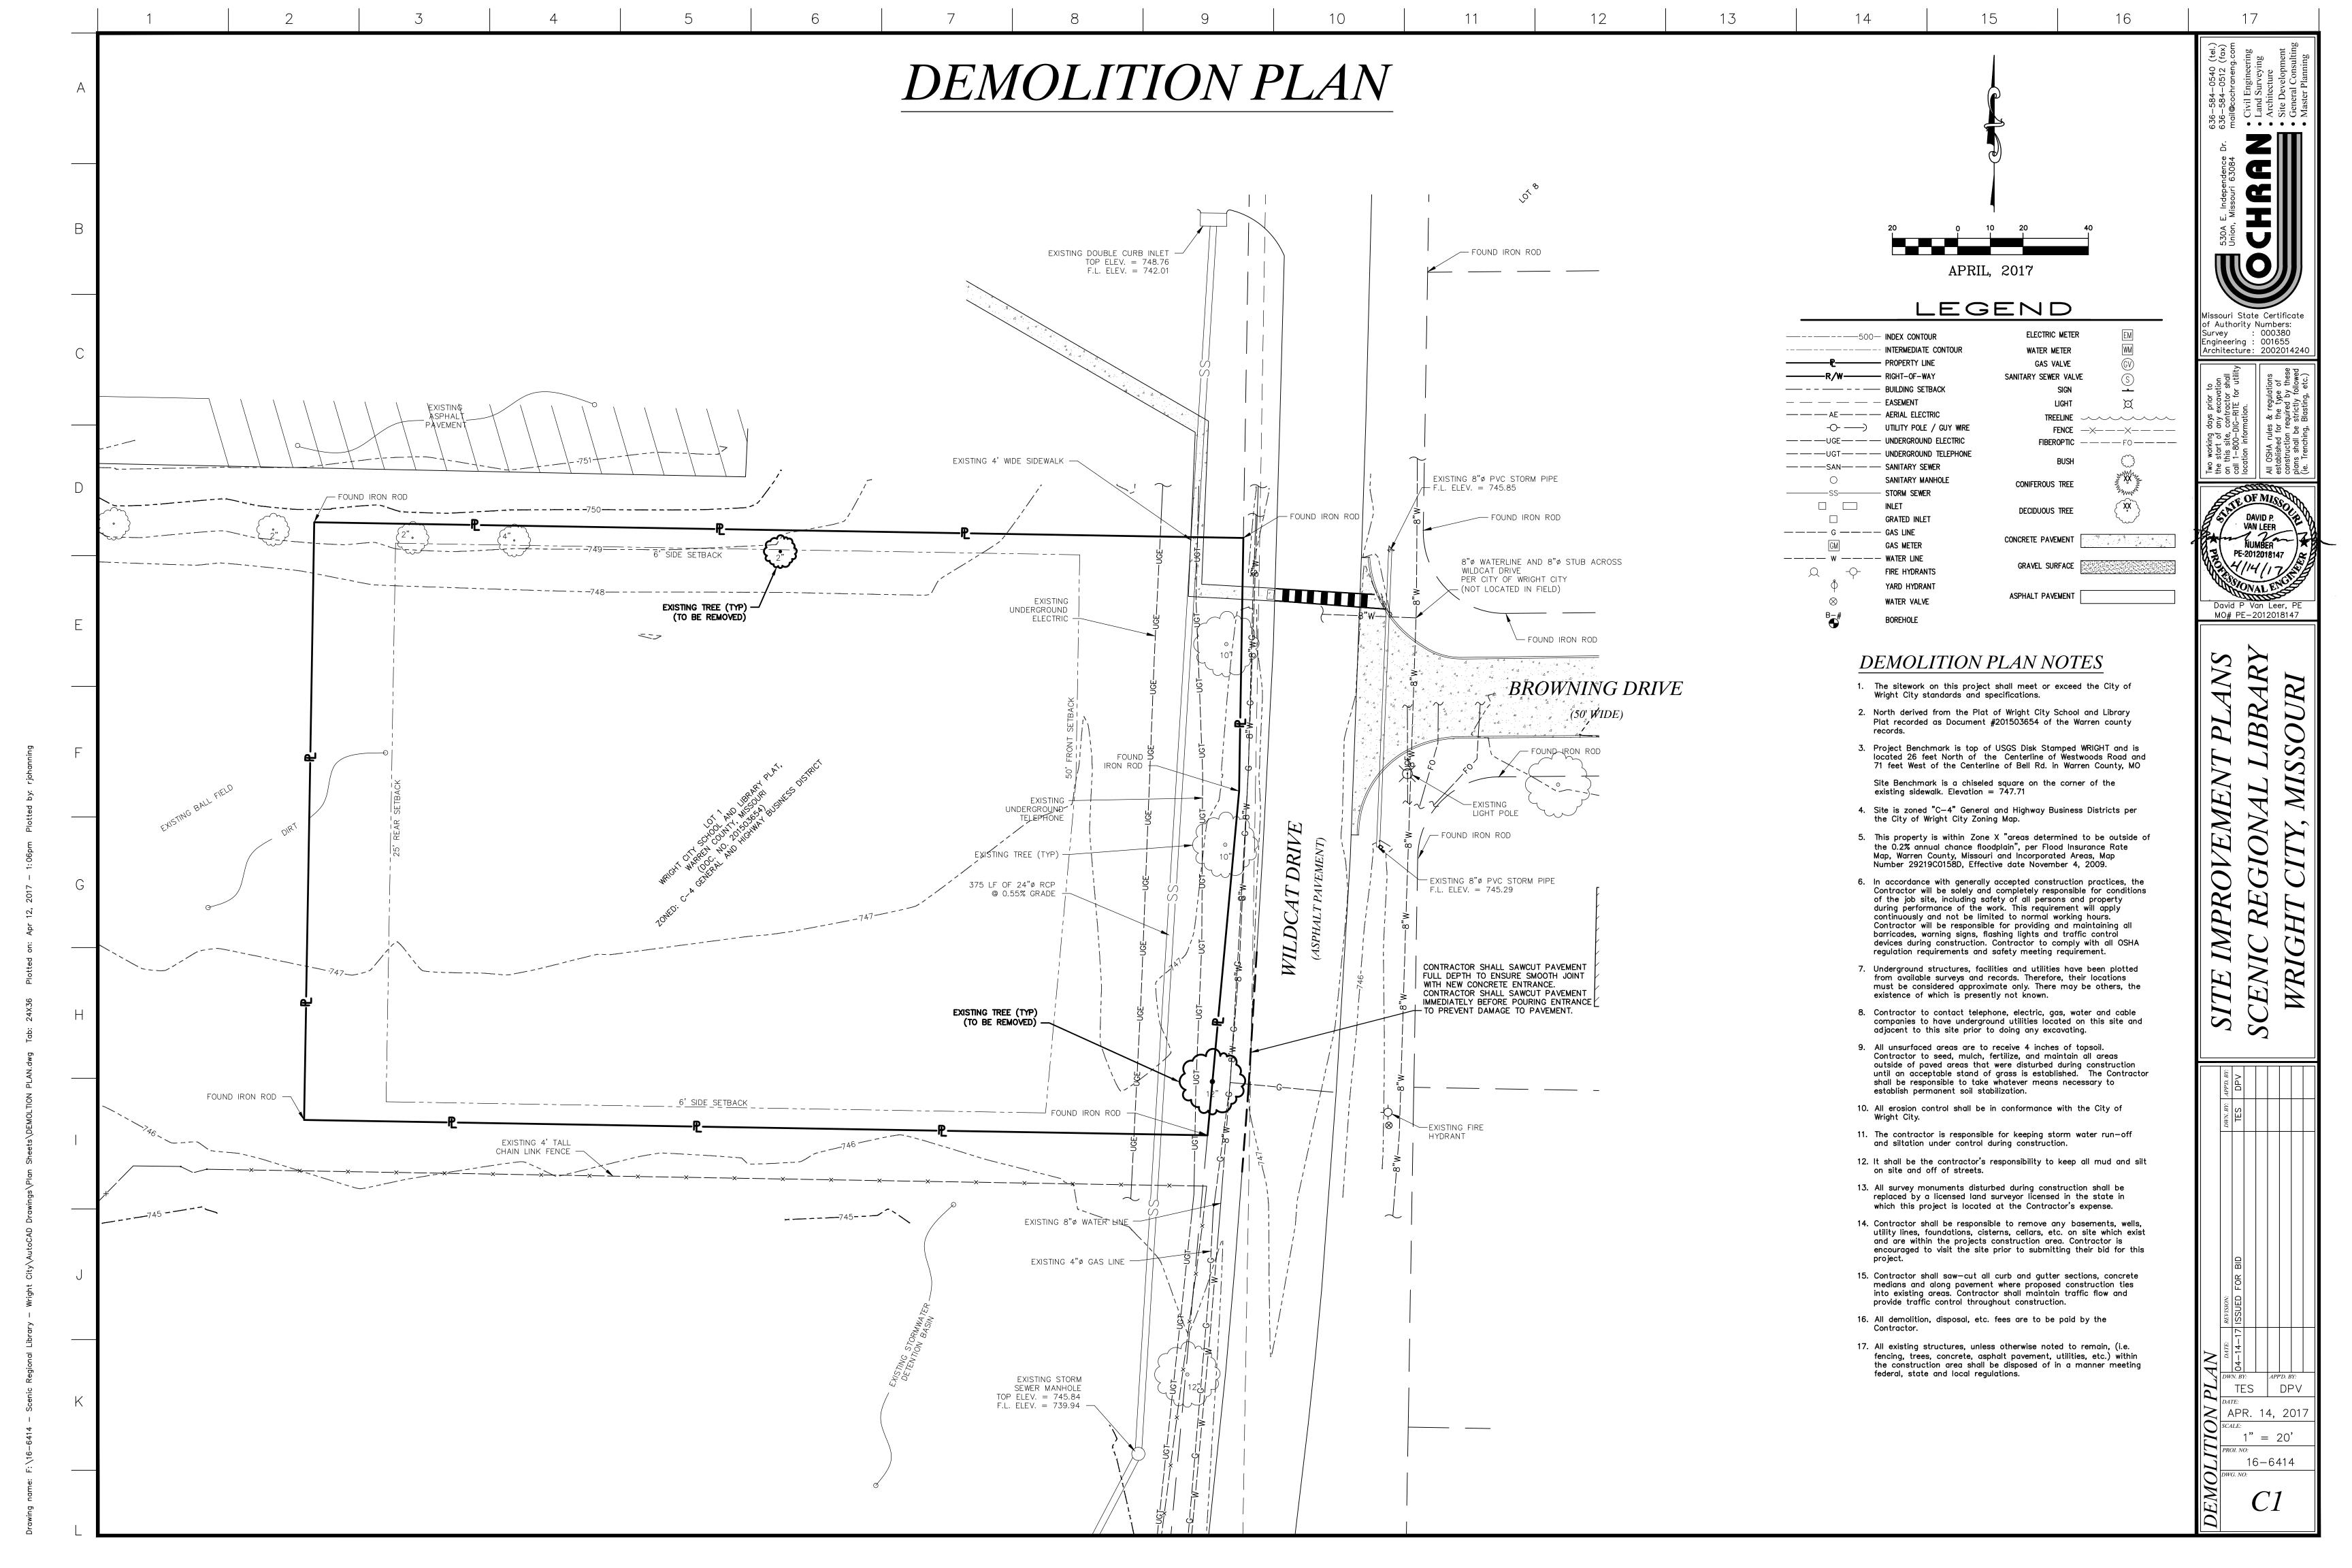

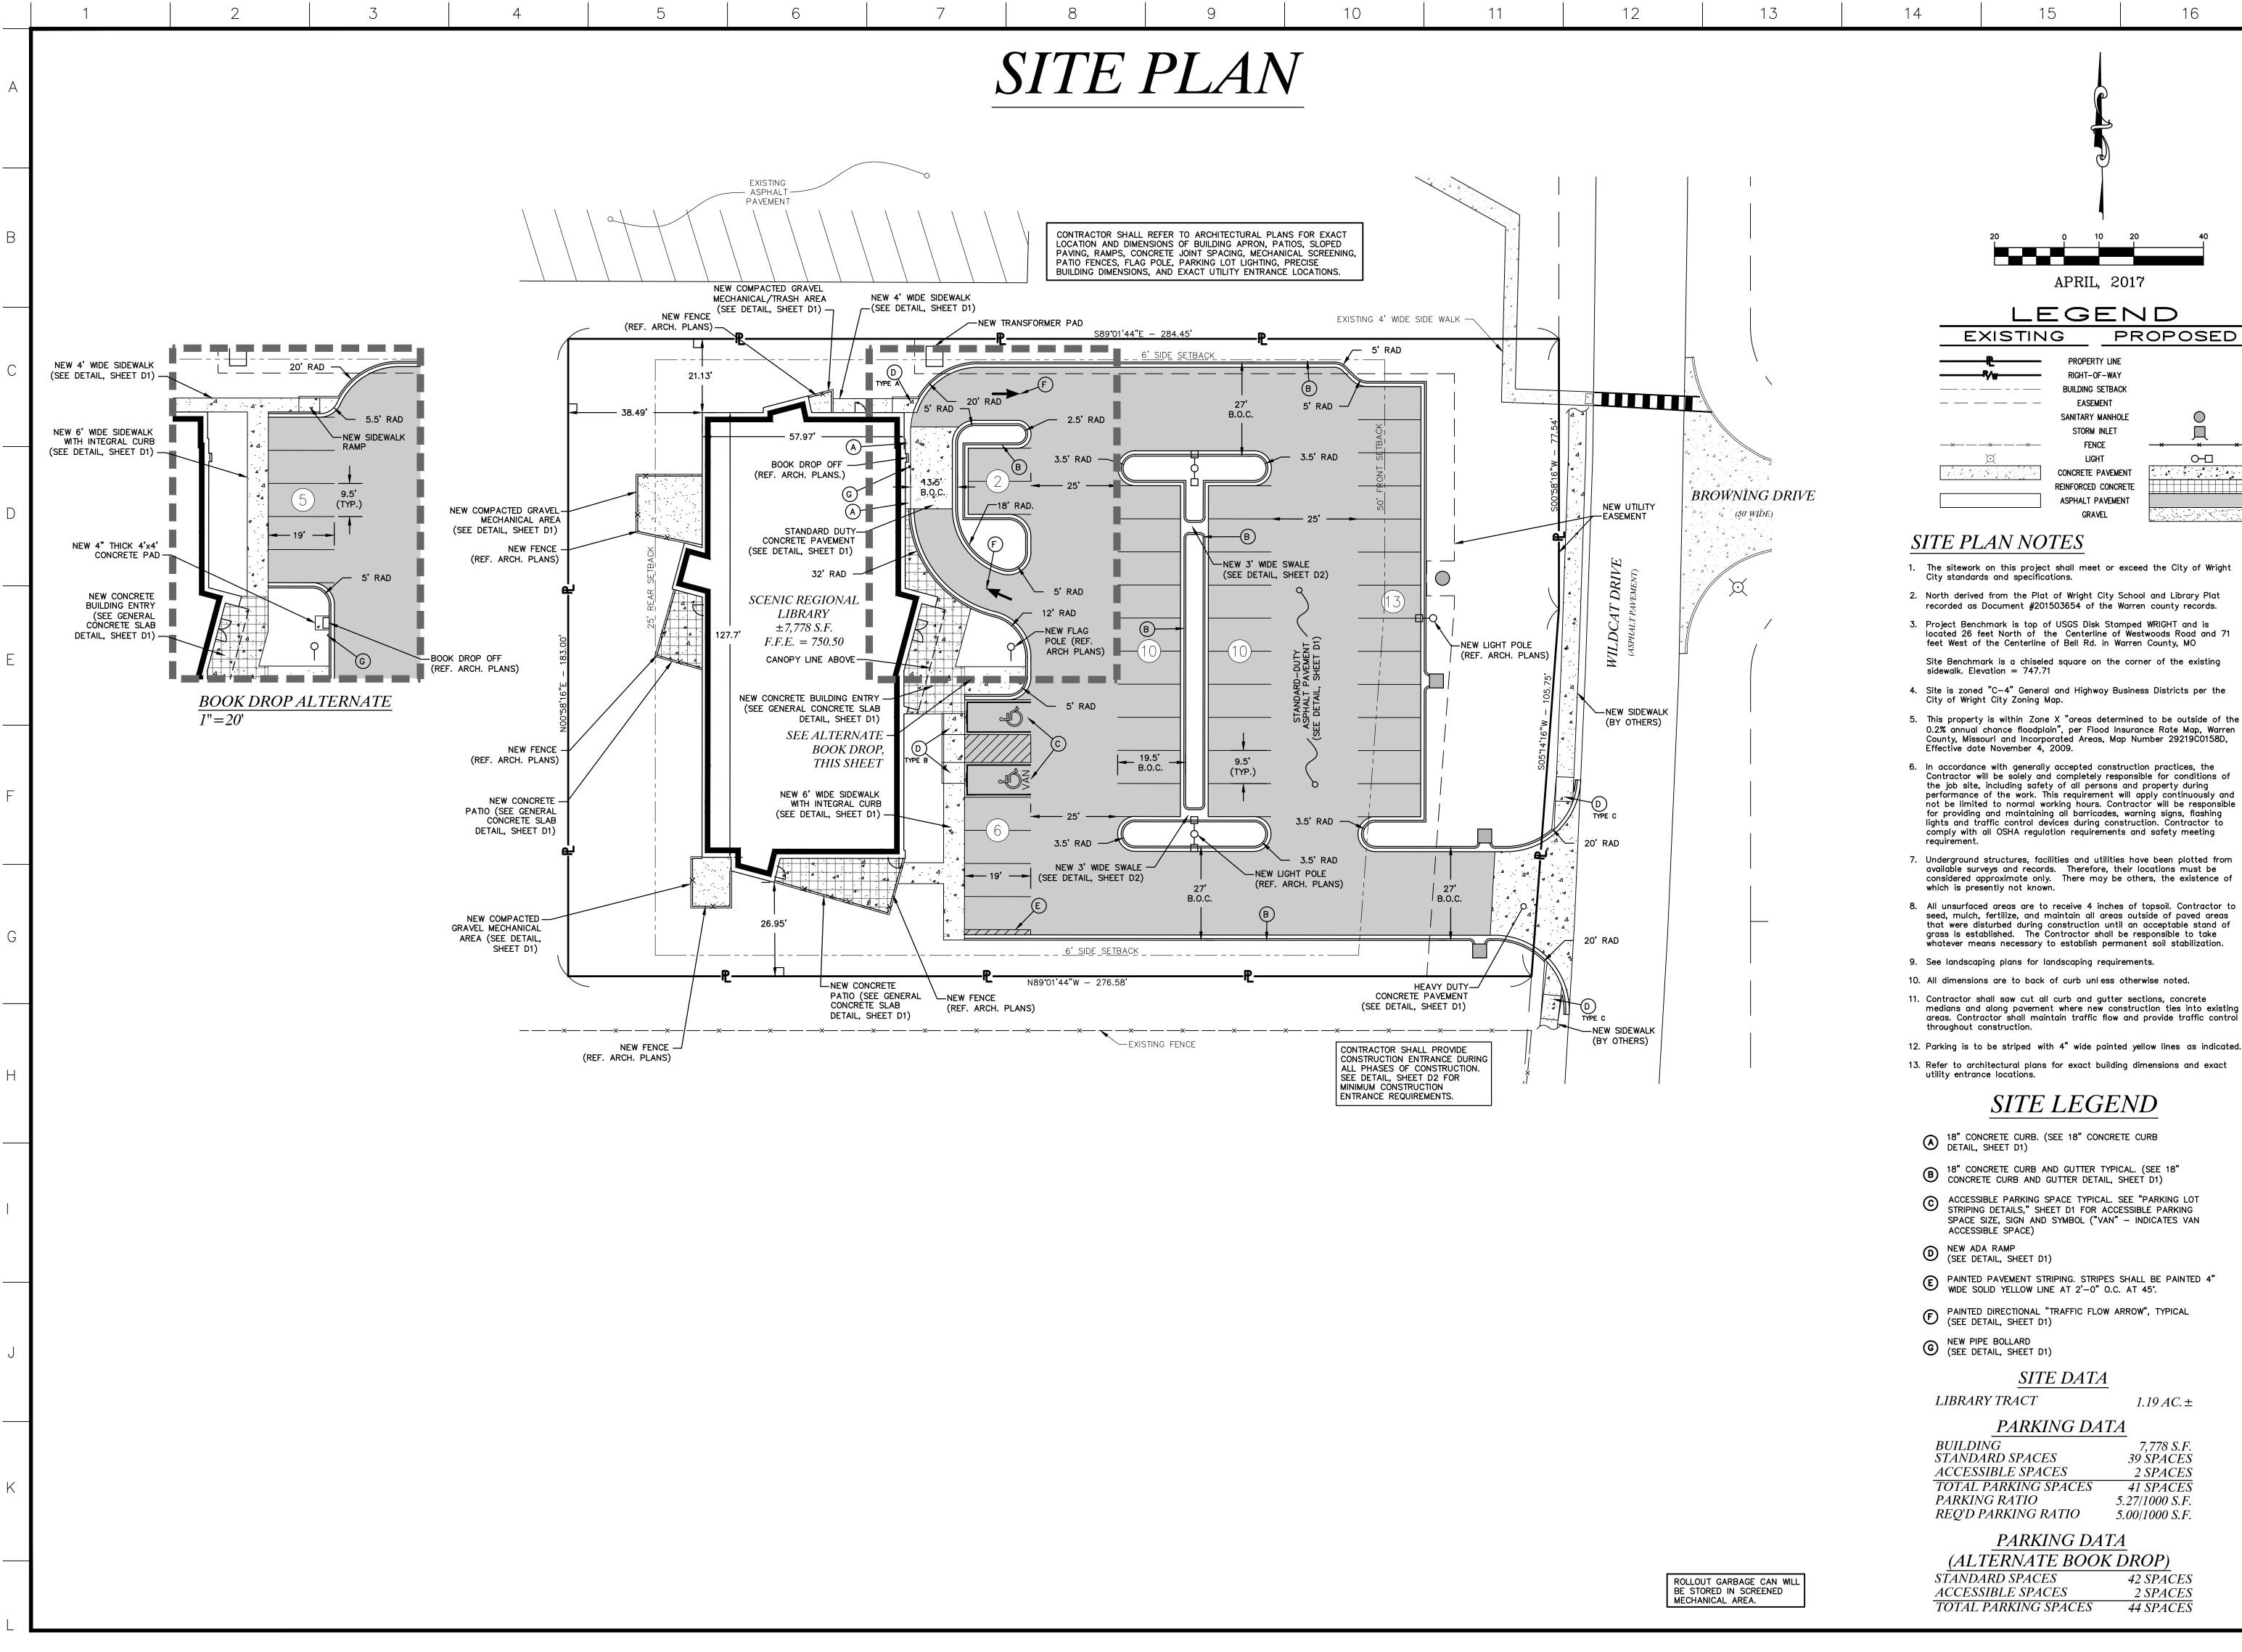

issouri State Certificate of Authority Numbers: 000380 Survey Engineering: 001655 Architecture: 2002014240

 \bigcirc

Two the on call PE-2012018147

PRO

David P Van Leer, Pl MO# PE-2012018147

4. Site is zoned "C-4" General and Highway Business Districts per the

5. This property is within Zone X "areas determined to be outside of the 0.2% annual chance floodplain", per Flood Insurance Rate Map, Warren County, Missouri and Incorporated Areas, Map Number 29219C0158D,

6. In accordance with generally accepted construction practices, the Contractor will be solely and completely responsible for conditions of the job site, including safety of all persons and property during performance of the work. This requirement will apply continuously and not be limited to normal working hours. Contractor will be responsible for providing and maintaining all barricades, warning signs, flashing lights and traffic control devices during construction. Contractor to comply with all OSHA regulation requirements and safety meeting

7. Underground structures, facilities and utilities have been plotted from available surveys and records. Therefore, their locations must be considered approximate only. There may be others, the existence of

8. All unsurfaced areas are to receive 4 inches of topsoil. Contractor to seed, mulch, fertilize, and maintain all areas outside of paved areas that were disturbed during construction until an acceptable stand of grass is established. The Contractor shall be responsible to take whatever means necessary to establish permanent soil stabilization.

10. All dimensions are to back of curb unless otherwise noted.

11. Contractor shall saw cut all curb and gutter sections, concrete medians and along pavement where new construction ties into existing areas. Contractor shall maintain traffic flow and provide traffic control

12. Parking is to be striped with 4" wide painted yellow lines as indicated.

13. Refer to architectural plans for exact building dimensions and exact

© ACCESSIBLE PARKING SPACE TYPICAL. SEE "PARKING LOT STRIPING DETAILS," SHEET D1 FOR ACCESSIBLE PARKING SPACE SIZE, SIGN AND SYMBOL ("VAN" - INDICATES VAN

7,778 S.F. 39 SPACES 2 SPACES 41 SPACES 5.27/1000 S.F.

42 SPACES

16-6414

TES DPV

APR. 14, 2017

1" = 20'

CONTRACTOR SHALL REFER TO ARCHITECTURAL PLANS FOR EXACT LOCATION AND DIMENSIONS OF BUILDING APRON, PATIOS, SLOPED PAVING, RAMPS, CONCRETE JOINT SPACING, MECHANICAL SCREENING PATIO FENCES, FLAG POLE, PARKING LOT LIGHTING, PRECISE BUILDING DIMENSIONS, AND EXACT UTILITY ENTRANCE LOCATIONS.

CURB INLET #3

<u>746.66 TC</u> 746.16 TŘ

47 L.F. OF NEW

@ 0.50% GRADE

DOGHOUSE CURB INLET #1

CONTRACTOR SHALL VERIFY

EXISTING STORM SEWER DERTH

PRIOR TO ORDERING MATERIALS

TOP ELEV. = 746.87

12"ø STORM SEWER

OPEN ON (E&W) SIDES

(E) INLET ELEV. = 745.66

F.L. ELEV. IN (DS) = 743.74

748.49 TC 748.37 TC 747.99 TP 748.37 TP F.L. ELEV. IN (DS) = 743.64

SEE ALTERNATI

BOOK DROP,


THIS SHEET

NEW SILT FENCE -

(SEE DETAIL, SHEET D2)

_ ____745--_____

TOP ELEV. = 746.66

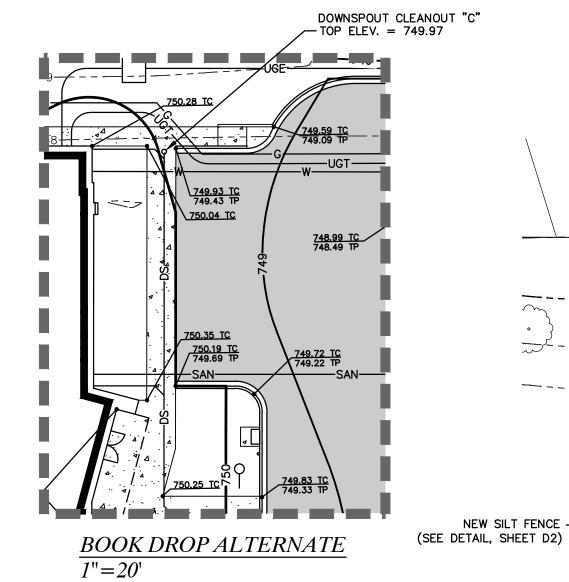

NEW SILT FENCE

GRADING & DRAINAGE PLAN NOTES

- 1. The sitework on this project shall meet or exceed the City of Wright City standards and
- 2. North derived from the Plat of Wright City School and Library Plat recorded as Document #201503654 of the Warren county records.

Site Benchmark is a chiseled square on the corner of the existing sidewalk

- 3. Project Benchmark is top of USGS Disk Stamped WRIGHT and is located 26 feet North of the Centerline of Westwoods Road and 71 feet West of the Centerline of Bell Rd. in Warren
- 4. Site is zoned "C-4" General and Highway Business Districts per the City of Wright City Zoning
- This property is within Zone X "areas determined to be outside of the 0.2% annual chance floodplain", per Flood Insurance Rate Map, Warren County, Missouri and Incorporated Areas, Map Number 29219C0158D, Effective date November 4, 2009.
- 6. In accordance with generally accepted construction practices, the Contractor will be solely and completely responsible for conditions of the job site, including safety of all persons and property during performance of the work. This requirement will apply continuously and not be limited to normal working hours. Contractor will be responsible for providing and maintaining all barricades, warning signs, flashing lights and traffic control devices during construction. Contractor to comply with all OSHA regulation requirements and safety meeting requirement.
- Underground structures, facilities and utilities have been plotted from available surveys and records. Therefore, their locations must be considered approximate only. There may be others, the existence of which is presently not known.
- 8. No investigation has been performed by Cochran regarding hazardous waste, underground
- 9. Contractor to contact telephone, electric, gas, water and cable companies to have underground utilities located on this site and adjacent to this site prior to doing any excavating.
- 10. All unsurfaced areas are to receive 4 inches of topsoil. Contractor to seed, mulch, fertilize, and maintain all areas outside of paved areas that were disturbed during construction until an acceptable stand of grass is established. The Contractor shall be responsible to take whatever mean's necessary to establish permanent soil stabilization.
- 11. See Landscaping Plans for landscaping requirements.
- 12. All grading, drainage, detention, and erosion control shall be in conformance with the City of Wright City Standards.
- 13. The Contractor is specifically cautioned that the location and/or elevation of existing utilities as shown on these plans is based on records of the various utility companies and, where possible, measurements taken in the field. The information is not to be relied on as being exact or complete. The Contractor must call the appropriate utility company to request exact field location of utilities. It shall be the responsibility of the Contractor to relocate all existing utilities,
- 14. All trenches under paved areas shall be backfilled with granular material and compacted to meet compaction requirements for the road/parking lot.
- 15. All survey monuments disturbed during construction shall be replaced by a licensed land surveyor licensed in the state in which this project is located at the Contractor's expense.
- 16. Contractor to obtain and follow installation requirements for storm sewer from pipe manufacturer for each type of piping material. Storm sewer pipe shall be reinforced concrete pipe, Class III per ASTM C-76, with plastic bitumen gaskets at joints. Storm sewer pipe installed in green areas may be HDPE pipe, AASHTO M252 Type S and M294 Type S.
- 17. Contractor shall coordinate adjustments to existing utilities with appropriate utility company as
- 18. Contractor shall coordinate the scheduling and location of the demolition and installation of all utilities, including stakeout, conduit required, trenching required, etc. Contractor shall contact each utility provider with at least 30 days advance notice of any work to be done.
- 19. Contractor shall provide a minimum of 18" of clearance between sanitary sewer and waterlines and a minimum of 18" of clearance between storm sewers and waterlines. This may mean that lowering of waterlines may be necessary.
- 20. Contractor shall submit shop drawings for sanitary sewer, water main, and storm sewer structures to Cochran for review and approval prior to fabrication of any structures.
- 21. Storm and sanitary sewer plan information depicts pipe lengths and grades calculated from the
- 22. All trenching, pipe laying, and backfilling shall be in accordance with Federal OSHA Regulations. 23. Utility Contractor shall have approval of all governing agencies having jurisdiction over this system
- 24. All necessary inspections, testing, and/or certifications required by codes, the County, and/or utility service companies shall be performed prior to announced building possession and the final
- 25. Contractor is encouraged to visit the site prior to submitting their bid for this project. 26. Contractor shall maintain the site in a well—drained manner in order to assume the shortest possible drying time after each rainfall. This will mean that pumping of standing water in low areas on the site will most likely be required during construction.
- 27. Contractor shall saw cut all curb and gutter sections, concrete medians and along pavement where new construction ties into existing areas. Contractor shall maintain traffic flow and provide
- 28. All existing structures unless otherwise noted to remain, (i.e. fencing, trees, concrete, asphalt pavement, utilities, etc.) within the construction area shall be removed and disposed off-site in a manner meeting local and state regulations. Any burning on site shall be subject to local and state ordinances and the Owner's Specifications.
- 29. All cut or fill slopes shall be 3:1 or flatter unless otherwise noted.
- 30. Existing grade contours shown at 1 foot intervals. New grade contours shown at 1 foot intervals. 31. If any existing structures to remain are damaged during construction it shall be the Contractor's responsibility to repair and/or replace the existing structure as necessary to return it to existing
- 32. Contractor shall assure positive drainage away from buildings for all green space and paved
- 33. It shall be the contractor's responsibility to keep all mud and silt on site and off of streets. 34. Land disturbing activities shall not commence until approval to do so has been received by governing agencies and until all erosion control measures have been taken.

DOWNSPOUT SCHEDULE

750.50 TC

DROP SLOT SHALL

BE 3'-11" ABOVE

SCENIC REGIONAL

 $\pm 7,778$ S.F.

F.F.E. = 750.50

750.50 TC 750.50 TC 750.50 TC

TOP OF PAVEMENT

DOWNSPOUT WYE "B"

DOWNSPOUT

750.30 749.80

STRUCTURE INFO	ORMATI	ON
STRUCTURE NUMBER	TOP ELEV.	FL. ELEV.
DOWNSPOUT WYE "A"	-	745.62
DOWNSPOUT WYE "B"	-	745.88
DOWNSPOUT CLEANOUT "C"	749.52	746.39
DOWNSPOUT WYE "D"	-	745.71

750.30 TO

DOWNSPOUT LEGEND

- 6"ø SCH. 40 PVC DOWNSPOUT LATERAL (1.00% MIN. GRADE)
- B 8"ø SDR. 35 PVC DOWNSPOUT COLLECTOR (1.00% MIN. GRADE)

Soil Preparation and Compaction:

DOWNSPOUT

-CLEANOUT "E"

Remove all stumps, bushes, trees, weeds, roots and other surface obstructions from the site. Contractor to strip all topsoil from the entire area to be graded. After the removal of all foreign organic matter, and after stripping of topsoil, the entire surface to be filled, or areas that are cut to subgrade shall be scarified to a minimum depth of 12 inches and then compacted by proof rolling with suitable compaction equipment weighing not less than 400 psi based on the contact area of one row of feet, or pneumatic—tired roller of equivalent compaction characteristics.

The maximum thickness of fill shall be in lifts not to exceed 8 inches. The proof rolling and the fill compaction operations under the building and paved areas shall produce at least 95% of the Standard Proctor Maximum Dry Density Test (ASTM D-698). Any soft areas encountered during proof rolling shall be undercut and replaced with a properly compacted fill. The compaction of the fill shall be tested during placement by a qualified soil technician to determine if the proper densification is taking place. All fill used on the site should consist of low plasticity soils as approved by the soils engineer. After proof rolling, no water should be allowed to pond on the surface. The earthwork for all building foundations and slabs shall be in accordance with architectural building plans and specifications. Compaction equipment shall be operating of the site at all times during filling operations.

Rock Preparation and Compaction:

Prior to fill placement, vegetation should be stripped and sloped areas should be benched. The fill materials placed at the site will consist primarily of a rock/soil mixture and blasted rock generated from the site. The shot rock fill materials should be well graded with particle sizes ranging from sand and silt to boulders less that 18 inches in diameter. Boulders larger than 18 inches in diameter should be separated and broke using a track hoe with a breaker or by other means or the boulders should be placed in non-critical fill areas, as approved by a soil technician. We recommend that boulders larger than 18 inches not be placed in areas where they will be encountered when excavating to install utilities or construct basements, or within 2 or 3 feet of the street subgrade level. Where the larger boulders are placed, care should be taken to ensure that voids are not present around them. It may be necessary to place gravel to in fill or "choke off" voids around the larger boulders.

Ripped rock and shot rock should be placed in horizontal lifts not exceeding 18 inches in loose thickness and compacted by a minimum of five passes of a vibratory roller weighing at least 10 tons. Proper compaction may not be achieved without vibratory roller. Due to the varying graduation of fill materials, density tests will generally be considered inappropriate to determine the quality of the fill. Therefore, performance criteria will be used to evaluate the fill. This involves observing the placement of each lift of fill and the effects of the compaction equipment prior to placing additional fill.

GEOTECHNICAL REQUIREMENTS


- 1. The soils at the site are susceptible to disturbance during grading operations (i.e, pumping and/or rutting). Care must be exercised to maintain the integrity of the subgrade when preparing the site for the placement of fill, making excavations, and other earth-related construction activities. If sensitive soils are present, a special approach to grading may need to be adopted. The special approach to grading includes excavating with a trackhoe or wide—tracked excavator. Care should be exercised to maintain the integrity of the subgrade prior to the placement of fill and building
- 2. Medium to high plastic soils were encountered in the six borings at depths that will affect the proposed construction. Therefore, remediation of the expansive clay soils to a minimum depth of 5 feet below the finished floor elevation is required within the proposed building footprint. Only approved fill material will be allowed within the proposed building
- All vegetation/organic materials must be stripped where encountered. The organic material can be stockpiled on-site for later use in landscaped areas or disposed of off-site in a legal manner. In all areas, the resulting exposed subgrade should be proofrolled, and any soft soil or yielding areas should be over excavated and backfilled with new compacted fill or well-graded crushed rock.
- 4. Where the bearing and/or subgrade soils consist of expansive clay soils, they shall be removed to a minimum depth of 5 feet below the finished floor elevation. The overexcavation should extend at least 5 feet beyond the outside edge of the building footprint to facilitate uniform compaction of the replacement materials and may require additional widening at the corners to allow equipment access for proper compaction. The overexcavation should be backfilled with properly compacted low plastic soil or 1-inch minus crushed limestone or limestone screenings. The foundations and floor slabs would then be constructed on the newly placed fill.
- 5. Fill Materials. Prior to placement of the fill, the fill material is to be approved by a representative of the Owner. In general, fill materials should consist of low plasticity, (liquid limit less than 45 percent and a plasticity index less than 20) cohesive soils or granular materials. Acceptable non_organic fill soils include materials designated CL, ML CL_ML, SP, SW, and GW by ASTM D 2487. Open-graded "clean" granular materials, in general, should not be used, as they tend to hold water, resulting in softening of the underlying cohesive soil subgrade.

- 6. Compaction. Fill or backfill must be placed in lifts of uniform thickness and compacted. The fill should be placed in 8—inch loose lifts. The engineered fill should be compacted to at least 95 percent of its standard Proctor (ASTM 698) maximum dry density and be placed at a moisture content that is plus or minus 2 percent of optimum moisture content. The soil fill may require aeration or wetting at the time of construction to achieve proper compaction. Deleterious
- 7. Observation of the type of soil or granular material to be placed as fill, placement of the compacted fill and field density testing should be performed by a qualified technician on each lift to verify the compaction requirements are met in the field and to insure that high plastic or highly compressible soils are not in the fill within the building pad

material should not be included in fill, nor should the fill be

placed on soft or frozen materials.

- 8. Site Drainage and Grading. During construction, proper drainage should be provided to protect the foundation excavations, floor slab and pavement subgrades from the detrimental effects of weather conditions during construction. Finished subgrades and foundation excavations should be kept free of standing water at all times.
- 9. Positive site drainage should be provided to reduce surface water infiltration around the perimeter of the building and beneath the floor slab. Grades must be sloped away from the structures and roof and surface drainage collected and discharged in such a way that water is not permitted to infiltrate the foundation backfill. Drain and utility pipes beneath the floor should have tight joints to prevent leakage. Utility trenches beneath the floor slab and pavement areas should be carefully backfilled with compacted low plastic soil or minus gradation crushed rock. "Clean" rock backfill can be a possible pathway for moisture to the potentially expansive high plastic clay.
- 10. Proofroll pavement subgrade in both cut and fill areas and recompact the subgrade immediately prior to placing base rock for the pavement. Soft areas should be selectively undercut and backfilled with properly compacted cohesive soil of the same type present in the subgrade. Proofroll passes should be limited, particularly on silty subgrades to reduce the potential for pumping of moisture from deeper within the soil profile. The asphaltic concrete surface course should be checked during placement to verify density and total

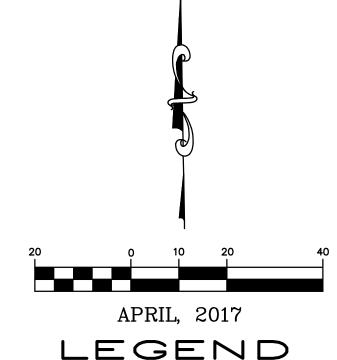

LEGEND PROPOSED EXISTING INDEX CONTOUR INTERMEDIATE CONTOUR UNDERGROUND ELECTRIC UNDERGROUND TELEPHONE SANITARY MANHOLE STORM INLET GAS LINE WATER LINE FIRE HYDRANTS WATER VALVE WATER METER SILTATION CONTROL CONCRETE PAVEMENT

INLET PROTECTION (SEE DETAIL, SHEET D2)

EROSION CONTROL NOTES:

EXISTING 8" PVC STORM PIPE

- F.L. ELEV. = 745.85

[©] BROWNING DRIVE

- EXISTING 8" PVC STORM PIPE

F.L. ELEV. = 745.29

DOGHOUSE CURB INLET #2

OPEN ON (N&S) SIDES

F.L. ELEV. IN = 743.40F.L. ELEV. = 740.70

CONTRACTOR SHALL PROVIDE

CONSTRUCTION ENTRANCE

DURING ALL PHASES OF CONSTRUCTION. SEE DETAIL,

SHEET D2 FOR MINIMUM

REQUIREMENTS.

CONSTRUCTION ENTRANCE

TOP ELEV. = 746.87(N) INLET ELEV. = 745.87

I EXISTING 375 LF OF


SEWER @ 0.55% GRAD

P∢∥24"ø RCP STORM

- 1. Contractor shall assure positive drainage from buildings for all natural & paved areas.
- 2. All unsurfaced areas are to receive four inches of topsoil. Contractor to seed, mulch, and fertilize all areas outside of paved areas that were disturbed during construction until an acceptable stand of grass is
- 3. Underground facilities, structures, and utilities have been plotted from available surveys and records. Therefore, their locations must be considered approximately only. There may be others, the existence of which is presently not known.
- 4. No land clearing or grading shall begin until all erosion control measures
- 5. Should construction stop for longer than 15 days, the site shall be seeded as specified by temporary seeding mix.
- 6. Maintain erosion control measures after each rain and at least once a
- 7. This plan shall not be considered all inclusive as the contractor shall take all necessary precautions to prevent soil sediment from leaving the
- 8. Contractor shall comply with all state and local ordinances that apply.
- 9. Additional erosion and sediment control measures will be installed if deemed necessary by on site inspection.
- 10. Land disturbing activities shall not commence until approval to do so has been received by governing authorities.
- 11. If installation of storm drainage system should be interrupted by weather or nightfall, the pipe ends shall be covered with filter fabric.
- 12. Contractor shall be responsible to take whatever means necessary to establish permanent soil stabilization.
- 13. Contractor shall adjust and/or cut existing pavement as necessary to assure a smooth fit and continuous grade.
- 14. The contractor is responsible for keeping stormwater run—off and
- siltation under control during construction. 15. Pavement lifts shall be placed in traverse directions with final layer
- perpendicular to the finished contours on parking lot. . Contractor to obtain and follow installation requirements for storm sewer, sanitary sewer waterline from pipe manufacturer for each type of
- 17. Contractor shall coordinate adjustments to existing utilities with
- appropriate utility company as work progresses. 18. Contractor shall coordinate the scheduling and location of the demolition and installation of all utilities, including stakeout, conduit required, trenching required, etc. Contractor shall contact each utility
- provider with at least 30 days advance notice of any work to be done. 19. Site grading shall not proceed until erosion control measures have been
- 20. In areas where french drain & storm sewer share the same trench, backfill shall be clean to allow for proper drainage.
- 1. Contractor shall maintain the site in a well—drained manner in order to assume the shortest possible drying time after each rainfall. This will mean that pumping of standing water in low areas on the site will most likely be reqd. during construction.
- 22. Contractor shall saw cut all curb and gutter sections, concrete medians and along pavement where new construction ties into existing areas. Contractor shall maintain traffic flow and provide traffic control throughout construction.
- 23. It shall be the contractor's responsibility to keep mud and silt on site
- 24. All cut or fill slopes shall be 3:1 or flatter unless otherwise noted.
- 25. All storm pipe entering structures shall be grouted to assure connection at structure is watertight.

SITE IMPROVEMENTS HAVE INCREASED THE IMPERVIOUS AREA BY 0.40 ACRES. THIS CREATES A 1.4 CFS INCREASE FOR THE 15 YEAR, 20 MINUTE STORM EVENT, STORMWATER WILL FLOW INTO THE EXISTING WRIGHT CITY SCHOOL DISTRICT DETENTION BASIN SOUTH OF THE PROPERTY. SITE IMPROVEMENTS WILL RAISE THE 100 YEAR 20 MINUTE HIGH

WATER LEVEL IN THE DETENTION BASIN BY ±0.04'.

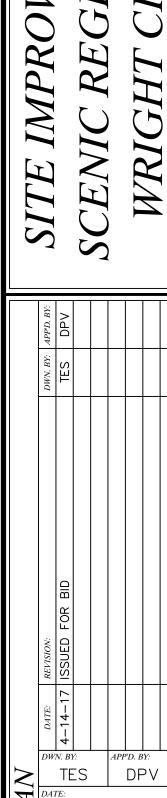

APR. 14, 201

1" = 20'


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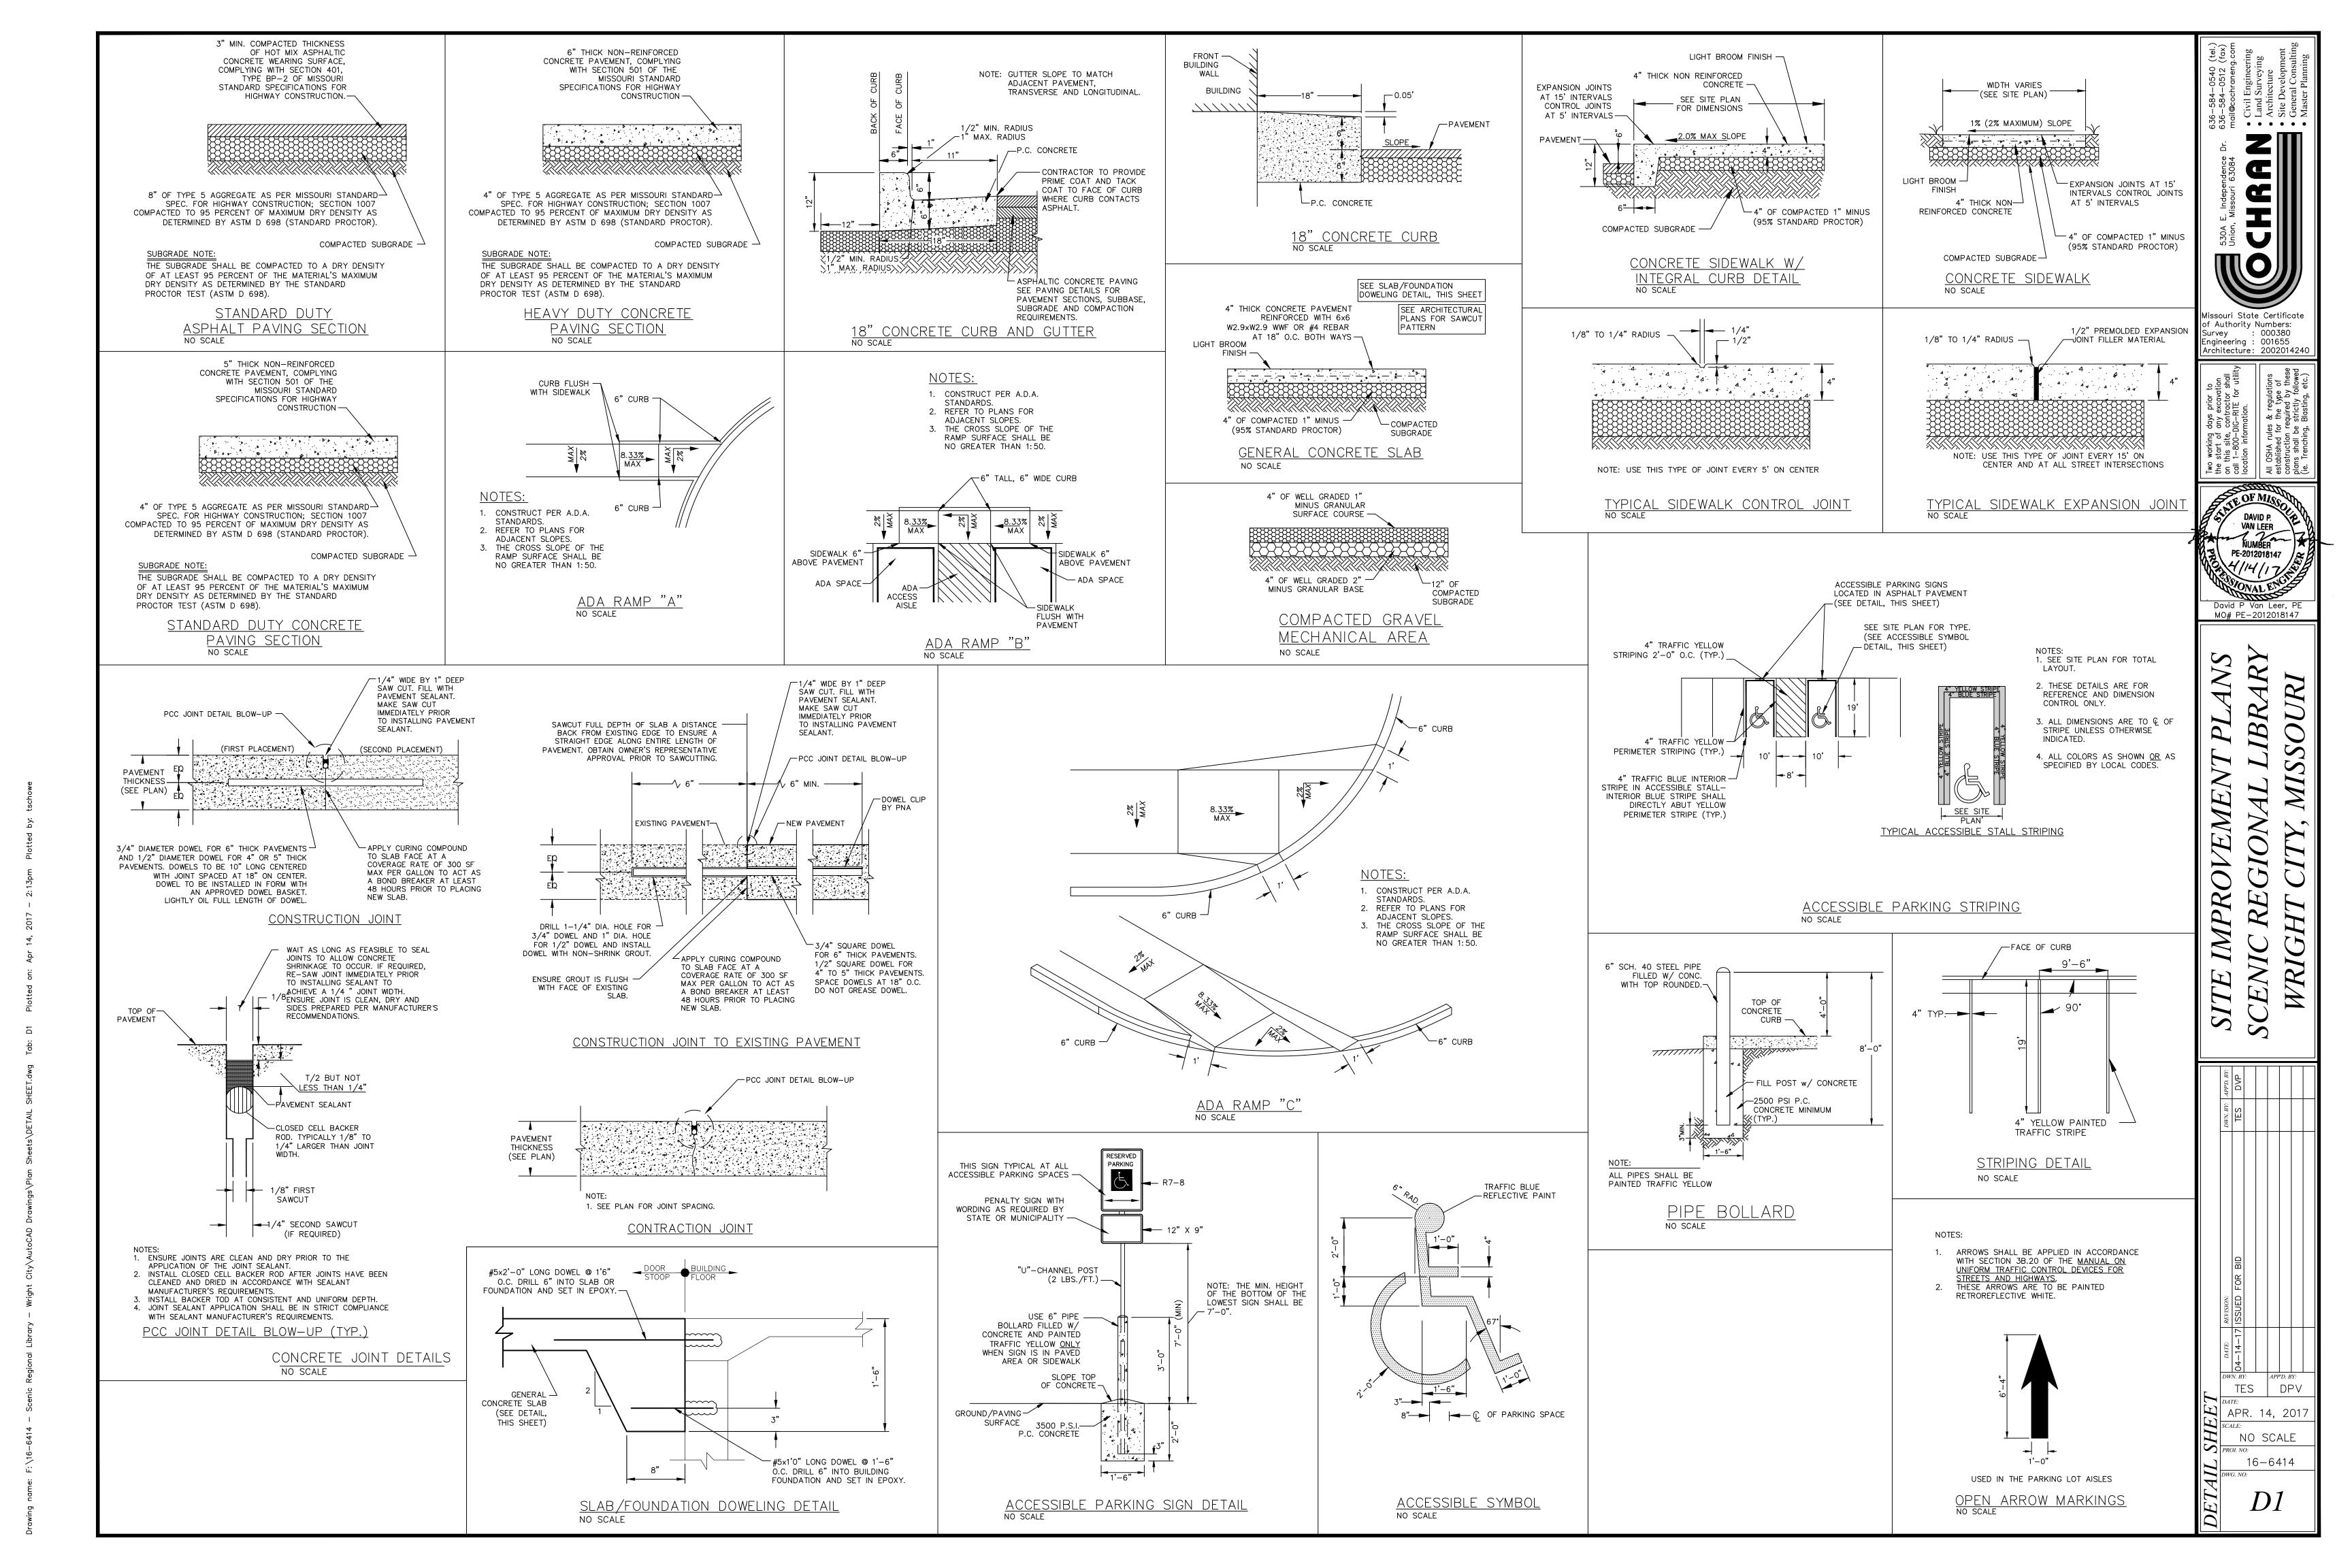
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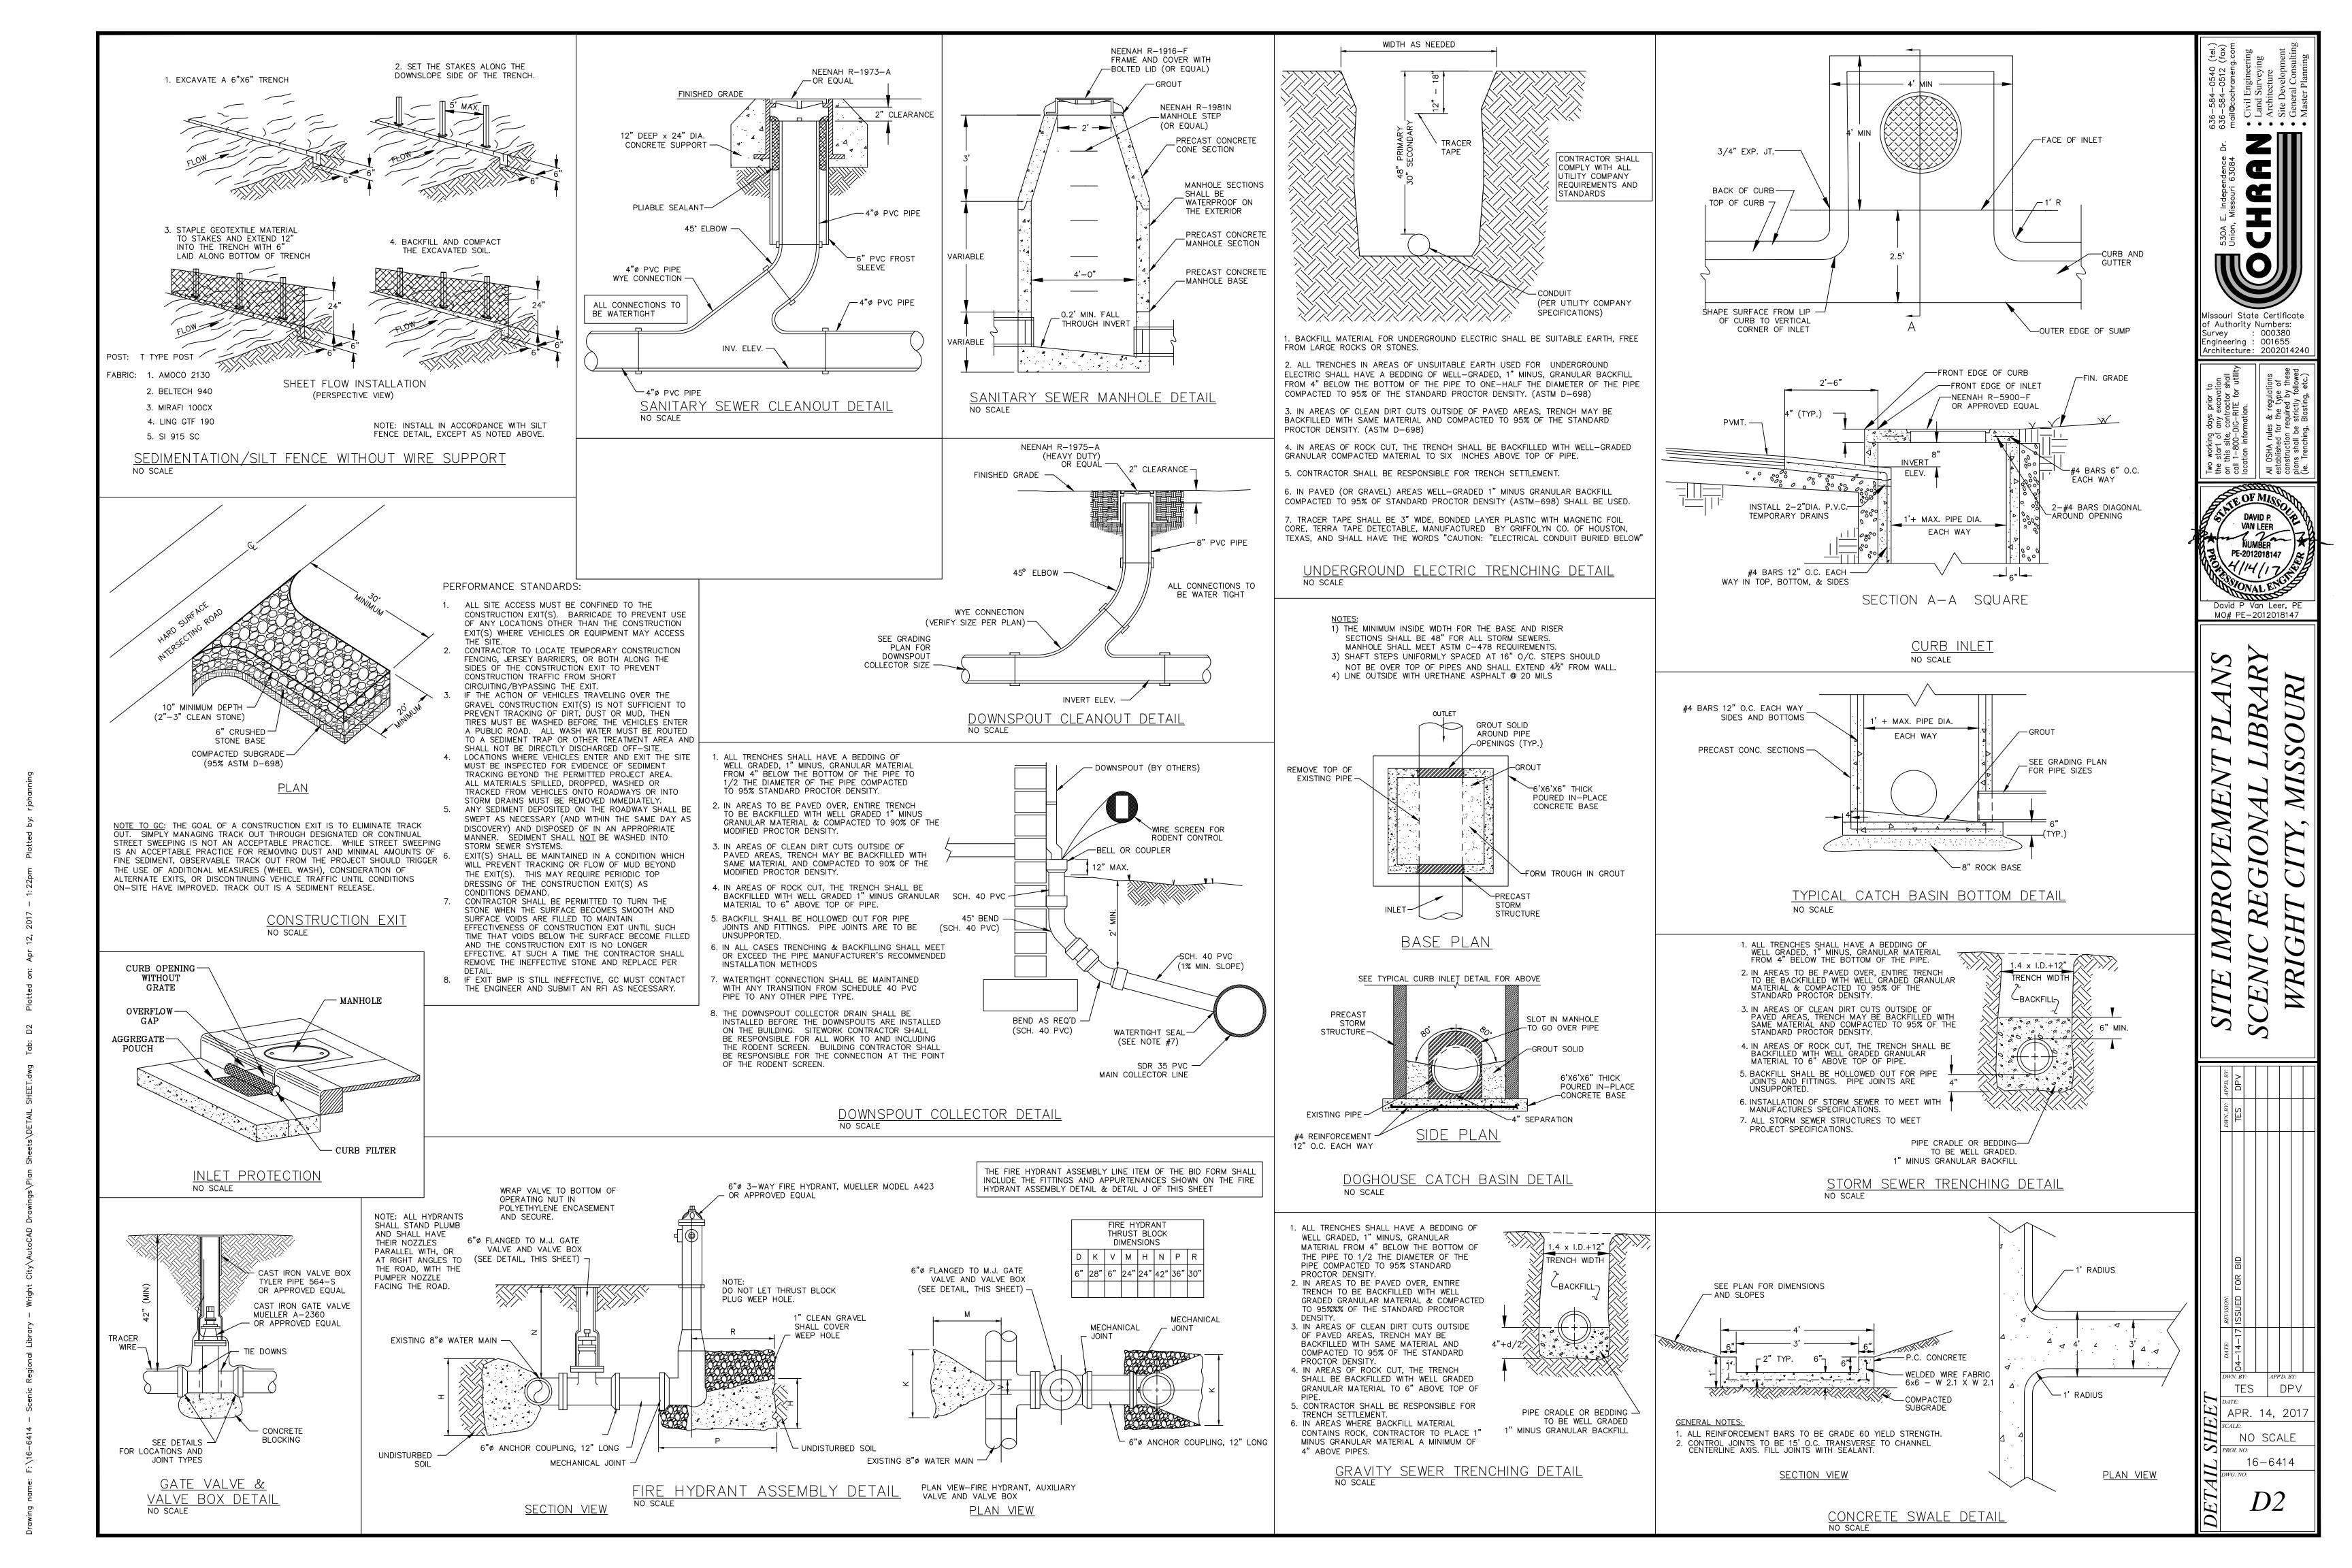
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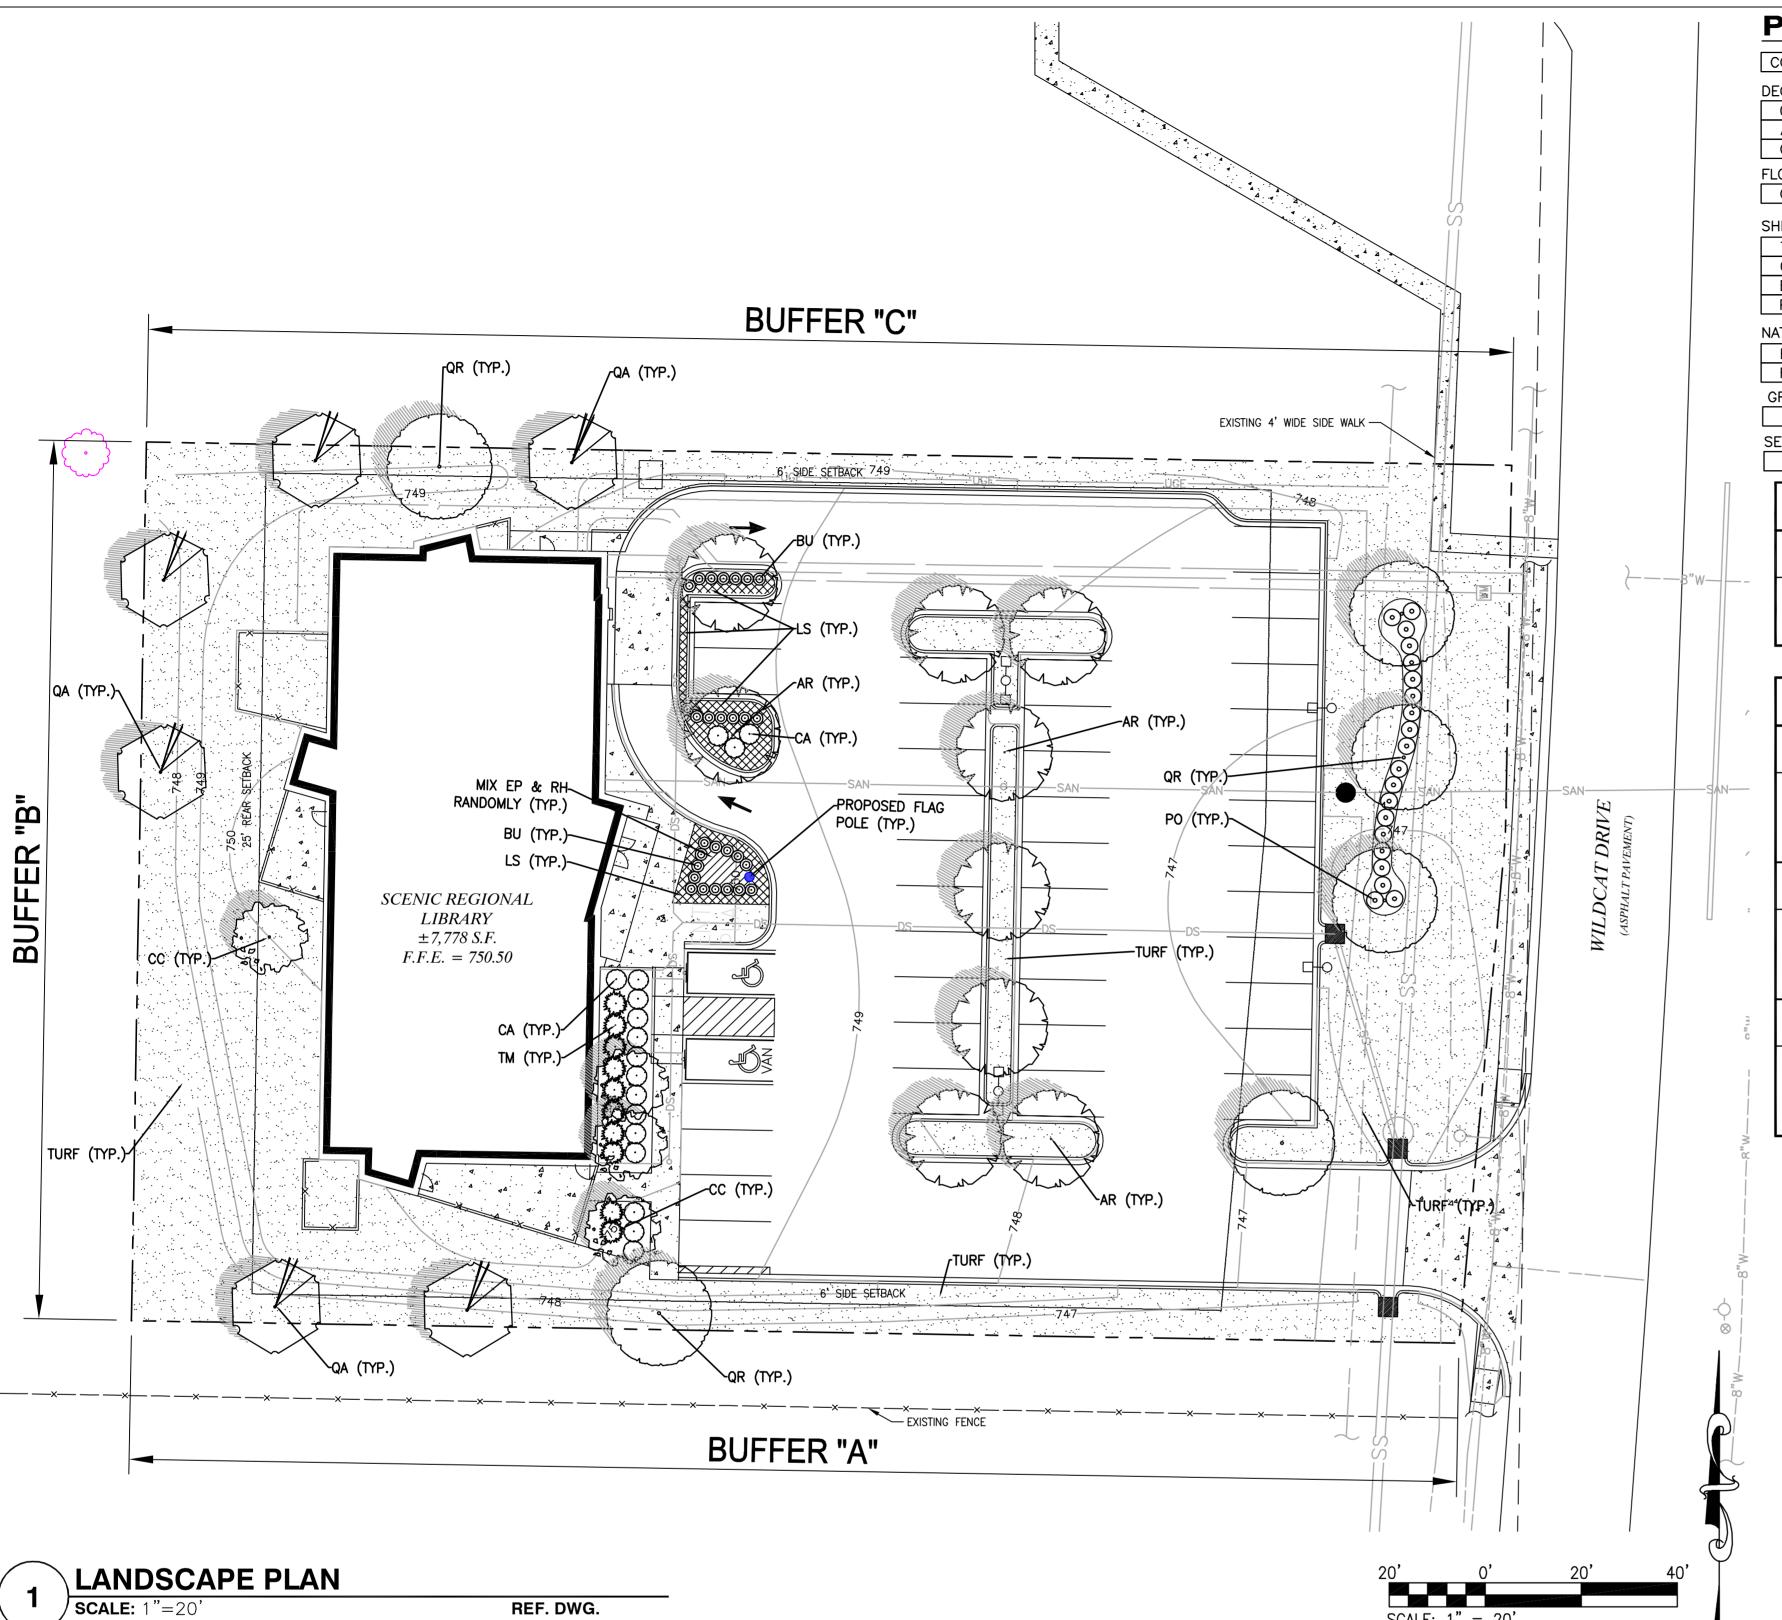
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CODE	QIY.	GENUS	SPECIES	COMMON NAME	SIZE	COND.	COMMENTS
DECIDU	OUS TR	REES					
QR	6	QUERCUS	RUBRA	NORTHERN RED OAK	2.5" CAL. MIN.	B&B	
AR	9	ACER	RUBRUM	RED MAPLE	2.5" CAL. MIN.	B&B	
QA	6	QUERCUS	ALBA	WHITE OAK	2.5" CAL. MIN.	B&B	
FLOWER	ING TR	EES					
СС	4	CERCIS	CANADENSIS	EASTERN REDBUD	1.5" CAL. MIN.	B&B	
SHRUBS TM	10	TAXUS	X MEDIA 'DENSIFORMIS'	YEW	3 GAL.	CONT.	
CA	17	CEANOTHUS	AMERICANUS	NEW JERSEY TEA	2 GAL.	CONT.	
BU	28	BUXUS	'GREEN VELVET'	GREEN VELVET BOXWOOD	18"-24" MIN.	CONT.	PLANT 30" 0.0
PO	20	PHYSOCARPUS	OPULIFOLIUS 'NANUS'	DWARF NINEBARK	2 GAL.	CONT.	
NATIVE	GRASSI	ES	•	•		•	
EP	15	ECHINACEA	PURPUREA	PURPLE CONEFLOWER	SP4	CONT.	18" O.C.
RH	15	RUDBECKIA	HIRTA	BLACK-EYED-SUSAN	SP4	CONT.	18" O.C.
	ID COV	ER					
GROUN				LULY TUBE	14 041	OOLIT.	40" 00
GROUN LS		LIRIOPE	SPICATA	LILY TURF	1 GAL.	CONT.	18" O.C.
		LIRIOPE	SPICATA	LILY TURF	1 GAL.	CON1.	18" O.C.

2,027 31		TI LOCOL OLLD
OFF-STREET PARKING CODE SEC. 405.110 D. (3) - SCI	AND LOADING REQUIRENT REENING AND LANDSCAPING	MENTS
REQUIREMENTS — WILDCAT LANE FRONTAGE	CALCULATIONS - REQUIRED LANDSCAPE	PROPOSED LANDSCAPE
1 SHRUB FOR EVERY 10 FEET OF LOT FRONTAGE	183.29 LINEAL FEET OF FRONTAGE 183.29/10 = 18.3 = 19 SHRUBS REQUIRED	20 SHRUBS PROPOSED

OFF-STREET PARKING AND LOADING REQUIREMENTS CODE SEC. 405.110 D. (13) — SCREENING AND LANDSCAPING			
REQUIREMENTS — BUFFER A	CALCULATIONS - REQUIRED LANDSCAPE	PROPOSED LANDSCAPE	
ALL SIDE AND REAR PROPERTY LINES SHALL CONTAIN DECIDUOUS SHADE TREES WITH A MAX SPACING OF 100 FET	276.8 FEET OF PROPERTY LINE 276.8/100 = 2.76 = 3 SHADE TREES REQUIRED	3 SHADE TREES PROPOSED	
REQUIREMENTS — BUFFER B	CALCULATIONS - REQUIRED LANDSCAPE	PROPOSED LANDSCAPE	
ALL SIDE AND REAR PROPERTY LINES SHALL CONTAIN DECIDUOUS SHADE TREES WITH A MAX SPACING OF 100 FET	183 FEET OF PROPERTY LINE 183/100 = 1.83 = 2 SHADE TREES REQUIRED	2 SHADE TREES PROPOSED	
REQUIREMENTS — BUFFER C	CALCULATIONS - REQUIRED LANDSCAPE	PROPOSED LANDSCAPE	
ALL SIDE AND REAR PROPERTY LINES SHALL CONTAIN DECIDUOUS SHADE TREES WITH A MAX SPACING OF 100 FET	284.45 FEET OF PROPERTY LINE 284.45/100 = 2.84 = 3 SHADE TREES REQUIRED	3 SHADE TREES PROPOSED	

LANDSCAPE NOTES:


- 1. LANDSCAPE CONTRACTOR TO VERIFY LOCATION OF UNDERGROUND UTILITIES BEFORE BEGINNING WORK. 2. ALL LANDSCAPE SHALL COMPLY WITH THE CURRENT EDITION OF ANSI Z 60.1 "AMERICAN STANDARD FOR NURSERY STOCK.'
- 3. ALL PLANTS SHALL MEET THE REQUIREMENTS OF THE STATE AND FEDERAL LAW WITH RESPECT TO DISEASE 17. THE OWNER'S REPRESENTATIVE/LANDSCAPE ARCHITECT RESERVES THE RIGHT TO INSPECT AND TAG ALL AND INSECT INFESTATION.
- 4. MULCH AREAS WITH TRIPLE GROUND HARDWOOD MULCH 3" MIN. DEPTH.
- 5. ALL LANDSCAPE SUBSTITUTIONS MUST BE APPROVED BY THE OWNER'S REPRESENTATIVE/LANDSCAPE
- 6. FORMAL LINES AND GROUPINGS OF A SPECIES OF TREE, SHRUB, OR GROUNDCOVER SHALL BE MATCHED FOR SIZE, FORM, AND COLOR. 7. ALL BACKFILL IN PLANTING BEDS AND TREE PITS SHALL BE BACKFILLED WITH PLANTING SOIL.
- 8. ALL TREES OUTSIDE OF PLANT BEDS SHALL BE PLANTED WITH A MULCH RING. OBTAIN APPROVAL FROM OWNER'S REPRESENTATIVE/LANDSCAPE ARCHITECT FOR ANY TREES THAT WILL NOT BE MULCHED FOR EXCESSIVE MOISTURE REASONS.
- 9. ALL LANDSCAPING SHALL BE INSTALLED AS SHOWN ON THE APPROVED PLAN. 10. AT PLANTING, TREE TRUNKS MUST BE STRAIGHT WITH MINIMAL DOGLEGS.
- 11. WIRE BASKETS, BURLAP WRAPPINGS, ROPE, TWINE OR ANY SIMILAR SHIPPING MATERIALS SHALL BE
- REMOVED BEFORE PLANTING. 12. A SPADE CUT EDGE SHALL BE CREATED AT ALL LOCATIONS WHERE PLANTING BEDS ARE ADJACENT TO GRASS AREAS UNLESS OTHERWISE NOTED.
- 13. SEE CIVIL PLANS FOR TYPE AND LOCATION OF EROSION CONTROL MATERIALS.
- 14. DO NOT DISTURB EXISTING UTILITIES WITHIN WORK AREA, SILT FENCE AND PLANTINGS SHALL AVOID ANY EXISTING UTILITIES.
- 15. THE CONTRACTOR SHALL FOLLOW THE LANDSCAPE PLANS. ANY SUBSTITUTION OR ALTERATION SHALL NOT BE ALLOWED WITHOUT APPROVAL OF THE OWNER'S REPRESENTATIVE/LANDSCAPE ARCHITECT. OVERALL PLANT 21. PRIOR TO INSTALLATION OF PLANT MATERIALS, AREAS THAT HAVE BEEN COMPACTED OR DISTURBED BY QUANTITY AND QUALITY SHALL BE CONSISTENT WITH THE PLANS.

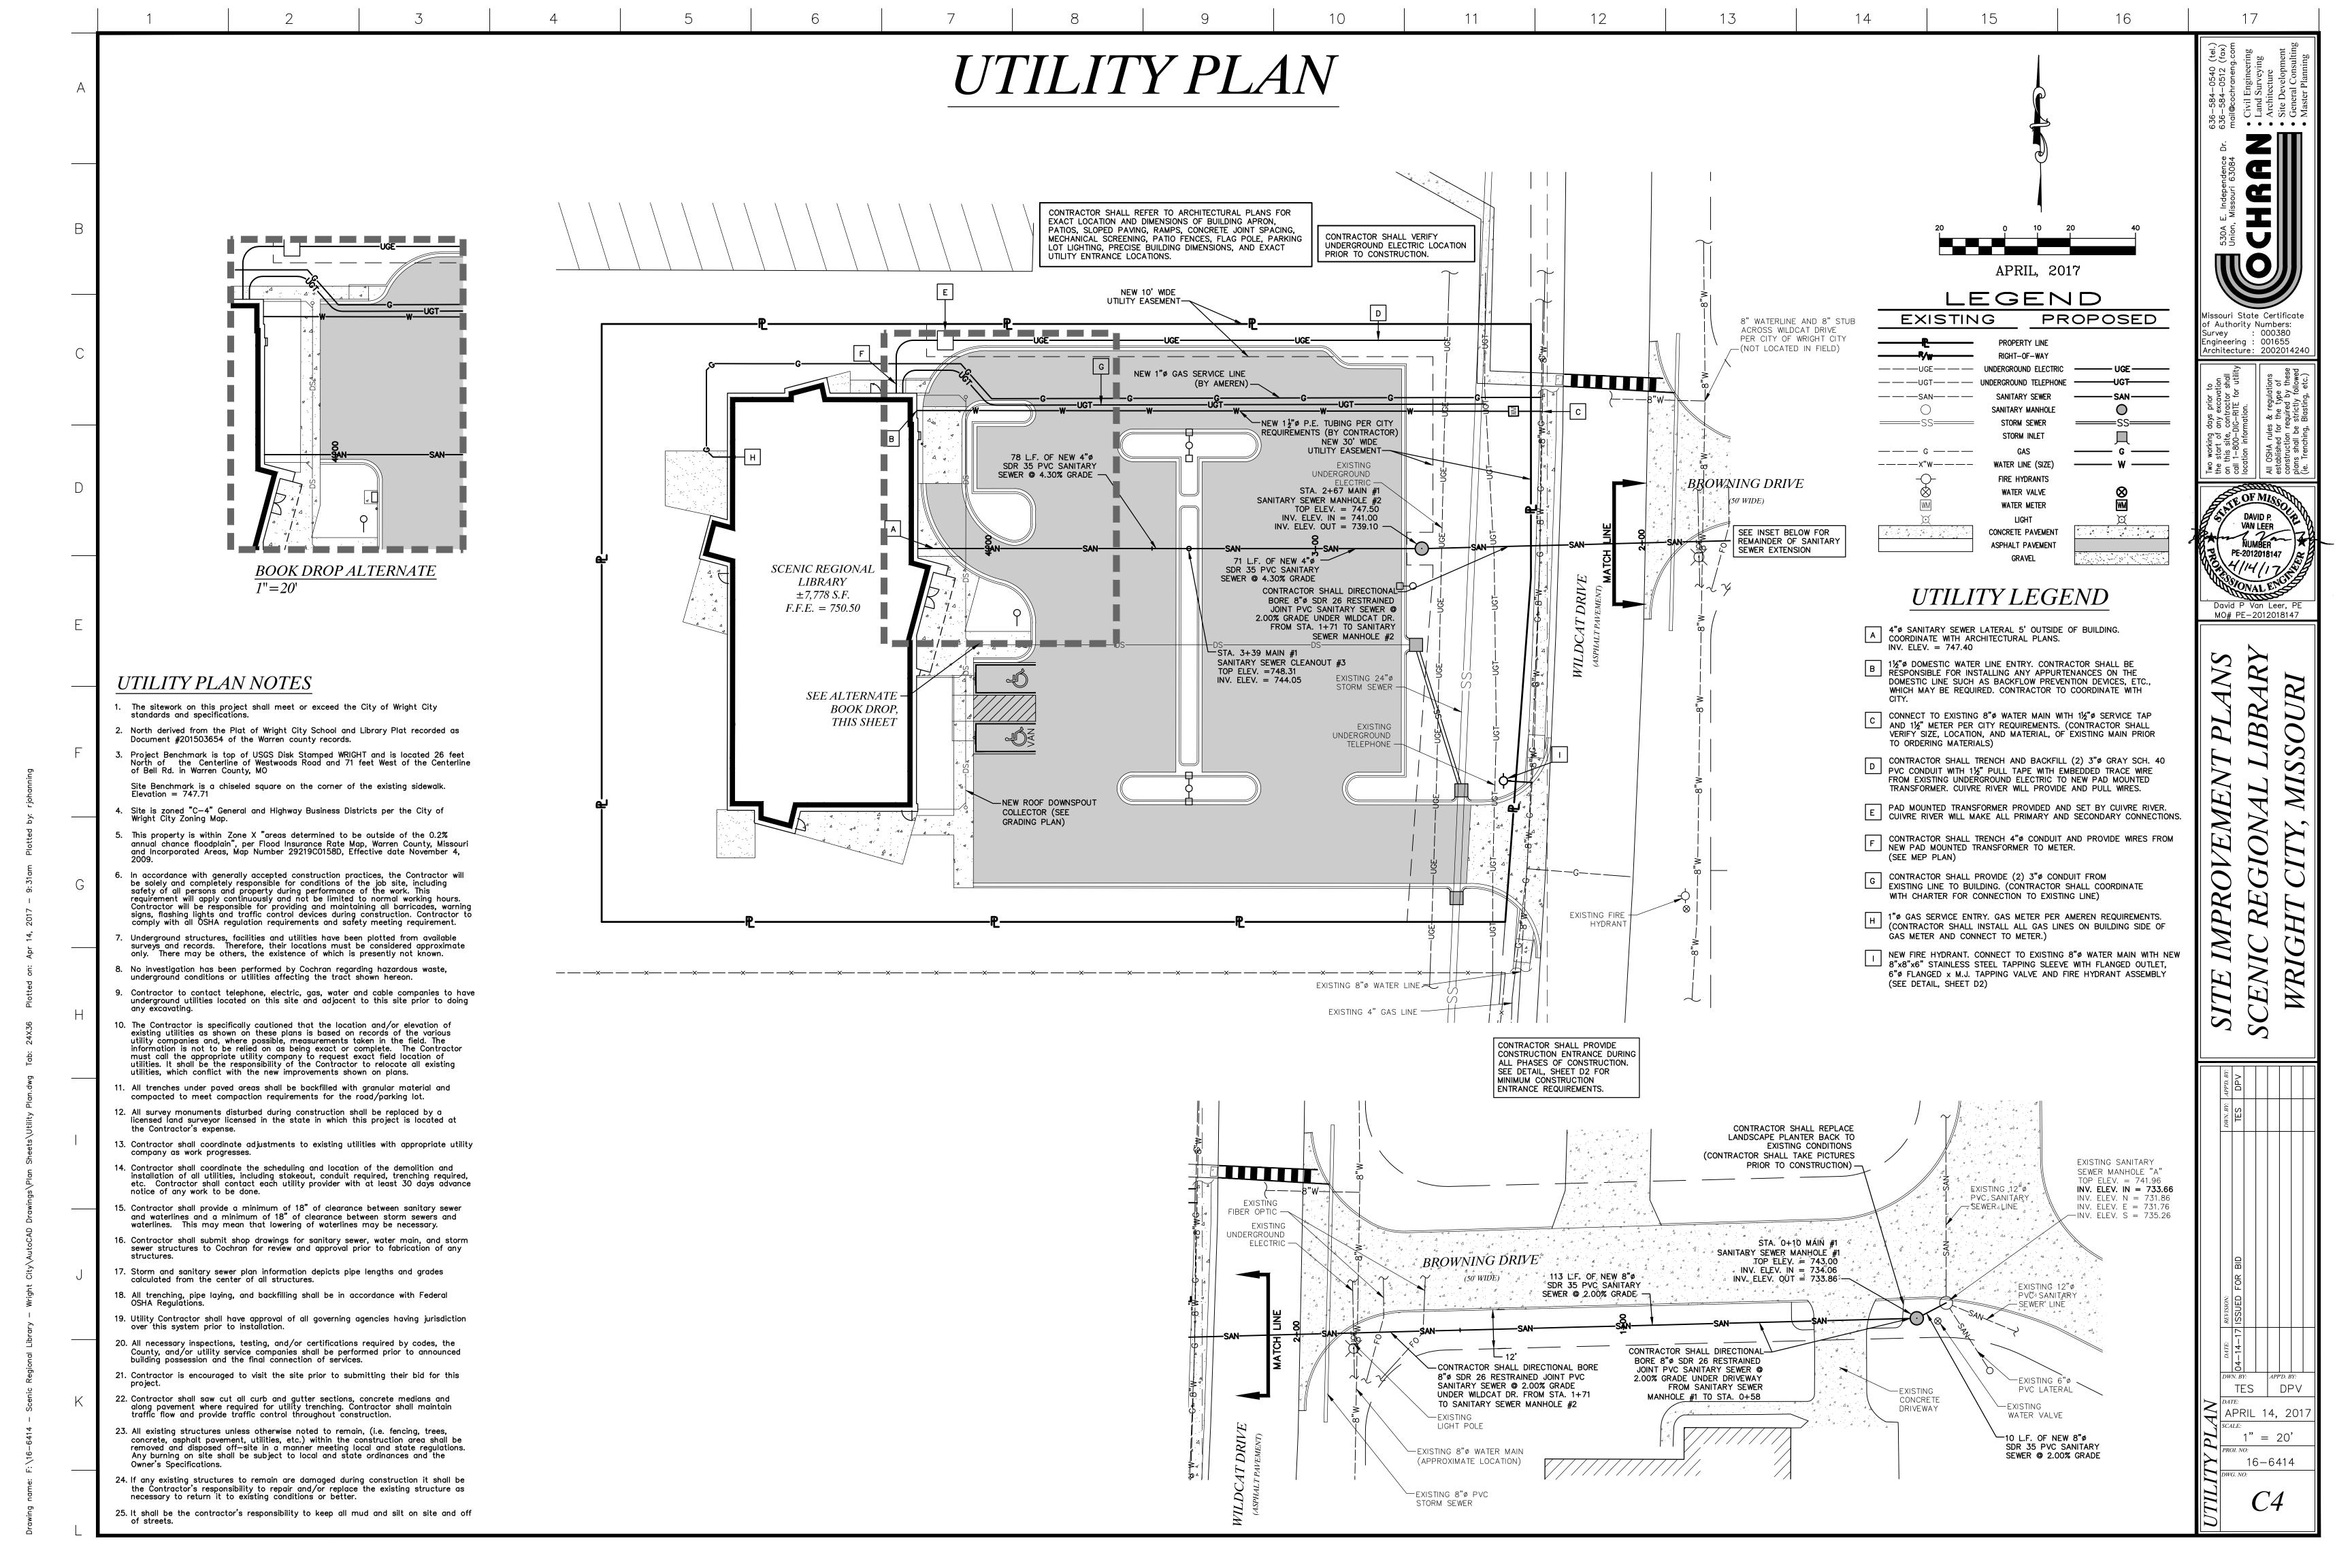- 16. THE CONTRACTOR IS RESPONSIBLE FOR VERIFYING ALL PLANT QUANTITIES. WRITTEN QUANTITIES TAKES PRECEDENCE OVER GRAPHIC QUANTITIES. NOTIFY OWNER'S REPRESENTATIVE/LANDSCAPE ARCHITECT OF DISCREPANCIES
- PLANT MATERIAL PRIOR TO SHIPPING TO THE SITE. IN ALL CASES, THE LANDSCAPE ARCHITECT MAY REJECT PLANT MATERIAL AT THE SITE IF MATERIAL IS DAMAGED, DISEASED, OR DECLINING IN HEALTH AT THE TIME 23. ALL EVERGREEN TREES SHALL BE FULLY BRANCHED TO THE GROUND AND SHALL NOT EXHIBIT SIGNS OF OF ONSITE INSPECTIONS OR IF THE PLANT MATERIAL DOES NOT MEET THE MINIMUM SPECIFIED STANDARD IDENTIFIED ON THE PLANS AND IN THE SPECIFICATIONS. THE CONTRACTOR SHALL COORDINATE WITH THE OWNER'S REPRESENTATIVE/LANDSCAPE ARCHITECT FOR INSPECTION AND APPROVAL OF ALL MATERIALS AND PRODUCTS PRIOR TO INSTALLATION.
- 18. THE OWNER'S REPRESENTATIVE/LANDSCAPE ARCHITECT MAY ELECT TO UPSIZE PLANT MATERIAL AT THEIR DISCRETION BASED ON SELECTION, AVAILABILITY, OR TO ENHANCE SPECIFIC AREAS OF THE PROJECT. THE CONTRACTOR SHALL VERIFY PLANT MATERIAL SIZES WITH OWNER'S REPRESENTATIVE/LANDSCAPE ARCHITECT PRIOR TO PURCHASING, SHIPPING OR STOCKING OF PLANT MATERIALS. SUBMIT CHANGE ORDER REQUEST TO OWNER'S REPRESENTATIVE/LANDSCAPE ARCHITECT FOR APPROVAL IF ADDITIONAL COST IS REQUESTED BY THE CONTRACTOR PRIOR TO INSTALLATION. RE-STOCKING CHARGES WILL NOT BE APPROVED IF THE
- CONTRACTOR FAILS TO SUBMIT A REQUEST FOR MATERIAL CHANGES. 19. THE CONTRACTOR SHALL WARRANTY ALL CONTRACTED WORK AND MATERIALS FOR A PERIOD OF ONE YEAR AFTER SUBSTANTIAL COMPLETION HAS BEEN ISSUED BY THE OWNER'S REPRESENTATIVE/LANDSCAPE ARCHITECT FOR THE ENTIRE PROJECT UNLESS OTHERWISE SPECIFIED IN THE CONTRACT DOCUMENTS OR SPECIFICATIONS.
- 20. THE DEVELOPER, HIS SUCCESSORS AND ASSIGNS SHALL BE RESPONSIBLE FOR THE INSTALLATION, MAINTENANCE AND REPLACEMENT OF ALL LANDSCAPING MATERIALS SHOWN OR INDICATED ON THE APPROVED LANDSCAPE PLAN ON FILE WITH THE PLANNING DEPARTMENT. ALL LANDSCAPING WILL BE INSTALLED AS DELINEATED ON THE PLAN, PRIOR TO ISSUANCE OF CERTIFICATE OF OCCUPANCY. CONSTRUCTION ACTIVITY SHALL BE THOROUGHLY LOOSENED TO A DEPTH OF 8" - 12"AND AMENDED PER

SPECIFICATIONS.

- 22. ALL LANDSCAPED AREAS ARE TO HAVE SOIL PREPARATION PER SPECIFICATIONS. (MINIMUM RATE OF 3 CU. 30. AT SEED AREA BOUNDARIES ADJACENT TO EXISTING NATIVE AREAS, OVERLAP ABUTTING NATIVE AREAS BY YDS. OF ORGANIC MATTER PER 1000 S.F.). TREES SHALL NOT BE LOCATED IN DRAINAGE SWALES, RELOCATION OF PLANTS IN QUESTIONABLE AREAS PRIOR TO INSTALLATION.
- ACCELERATED GROWTH AS DETERMINED BY THE OWNER'S REPRESENTATIVE/LANDSCAPE ARCHITECT. 24. ALL TREES ARE TO BE STAKED AND GUYED PER DETAILS FOR A PERIOD OF 1 YEAR. THE CONTRACTOR SHALL BE RESPONSIBLE FOR REMOVING STAKES AT THE END OF 1 YEAR FROM ACCEPTANCE OF
- LANDSCAPE INSTALLATION BY THE OWNER'S REPRESENTATIVE/LANDSCAPE ARCHITECT. OBTAIN APPROVAL BY OWNER'S REPRESENTATIVE PRIOR TO REMOVAL. 25. ALL TREES INSTALLED ABOVE RETAINING WALLS UTILIZING GEO-GRID MUST BE HAND DUG TO PROTECT
- GEO-GRID. IF GEO-GRID MUST BE CUT TO INSTALL TREES, APPROVAL MUST BE GIVEN BY OWNER'S REPRESENTATIVE/LANDSCAPE ARCHITECT PRIOR TO DOING WORK.
- 26. PLACE PLANT MATERIAL IN SHRUB BED SO THAT ONCE PLANTS GROW TO FULL SIZE THEY ARE FULLY CONTAINED WITHIN THE SHRUB BED AREA AND DO NOT HANG OVER THE EDGER LINE.
- 27. THE LANDSCAPE CONTRACTOR SHALL BE RESPONSIBLE FOR ENSURING POSITIVE DRAINAGE EXISTS IN ALL LANDSCAPE AREAS. SURFACE DRAINAGE ON LANDSCAPE AREAS SHALL NOT FLOW TOWARD STRUCTURES AND FOUNDATIONS. MAINTAIN SLOPE AWAY FROM FOUNDATIONS PER THE GEOTECHNICAL REPORT RECOMMENDATIONS. ALL LANDSCAPE AREAS BETWEEN WALKS AND CURBS SHALL DRAIN FREELY TO THE CURB UNLESS OTHERWISE IDENTIFIED ON THE GRADING PLAN. IN NO CASE SHALL THE GRADE, TURF THATCH, OR OTHER LANDSCAPE MATERIALS DAM WATER AGAINST WALKS. MINIMUM SLOPES ON LANDSCAPE AREAS SHALL BE 2%; MAXIMUM SLOPE SHALL BE 25% UNLESS SPECIFICALLY IDENTIFIED ON THE PLANS OR APPROVED BY THE OWNER'S REPRESENTATIVE/LANDSCAPE ARCHITECT.
- 28. SHRUB, GROUNDCOVER AND PERENNIAL BEDS ARE TO BE CONTAINED BY A SPADE CUT EDGE. EDGER IS NOT REQUIRED WHEN ADJACENT TO CURBS, WALKS OR SOLID FENCES WITHIN 3"OF PRE-MULCHED FINAL GRADE. EDGER SHALL NOT BE REQUIRED TO SEPARATE MULCH TYPES UNLESS SPECIFIED ON THE PLANS.

- 29. ALL SHRUB BEDS ARE TO BE MULCHED WITH MIN. 3" DEPTH, SHREDDED HARDWOOD BARK MULCH. THE FULL WIDTH OF THE SEEDER.
- DRAINAGE AREAS, OR UTILITY EASEMENTS. CONTACT OWNER'S REPRESENTATIVE/LANDSCAPE ARCHITECT FOR 31. EXISTING TURF AREAS THAT ARE DISTURBED DURING CONSTRUCTION, ESTABLISHMENT AND THE MAINTENANCE PERIOD SHALL BE RESTORED WITH SEED TO MATCH EXISTING TURF SPECIES.
 - 32. CONTRACTOR SHALL OVER SEED ALL MAINTENANCE OR SERVICE ACCESS BENCHES AND ROADS WITH SPECIFIED SEED MIX UNLESS OTHERWISE NOTED ON THE PLANS. 33. ALL SEEDED SLOPES EXCEEDING 25% IN GRADE (4:1) SHALL RECEIVE EROSION CONTROL BLANKETS. PRIOR
 - TO INSTALLATION, NOTIFY OWNER'S REPRESENTATIVE FOR APPROVAL OF LOCATION AND ANY ADDITIONAL COST IF A CHANGE ORDER IS NECESSARY.
 - 34. WHEN COMPLETE, ALL GRADES SHALL BE WITHIN +/- 1/8" OF FINISHED GRADES AS SHOWN ON THE

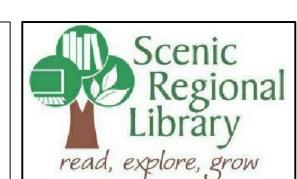



ARCHITECT-OF-RECORD

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CONTACT: SCOTT CLARK E-MAIL: SCLARK@JEMASTL.COM

DESIGN ARCHITECT SAPP DESIGN ASSOCIATES ARCHITECTS 3750 SOUTH FREMONT

SPRINGFIELD, MO 65804 T (417) 877-9600 F (417) 877-9696

CONTACT: JAMES STUFFLEBEAM E: STUFFLEBEAM@SDAARCHITECTS.COM

COCHRAN 530A E. INDEPENDENCE DRIVE

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UNION, MO 63084 CONTACT: DAVE VAN LEER T (636) 584-0540

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ALPER AUDI, INC. 1804 BORMAN CIRCLE DRIVE ST. LOUIS, MO 63146 T (314) 432-8600 F (314) 807-2774

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MECHANICAL, ELECTRICAL, PLUMBING BRIC PARTNERSHIP, LLC 343 S. KIRKWOOD ROAD, SUITE 204 KIRKWOOD, MO 63122

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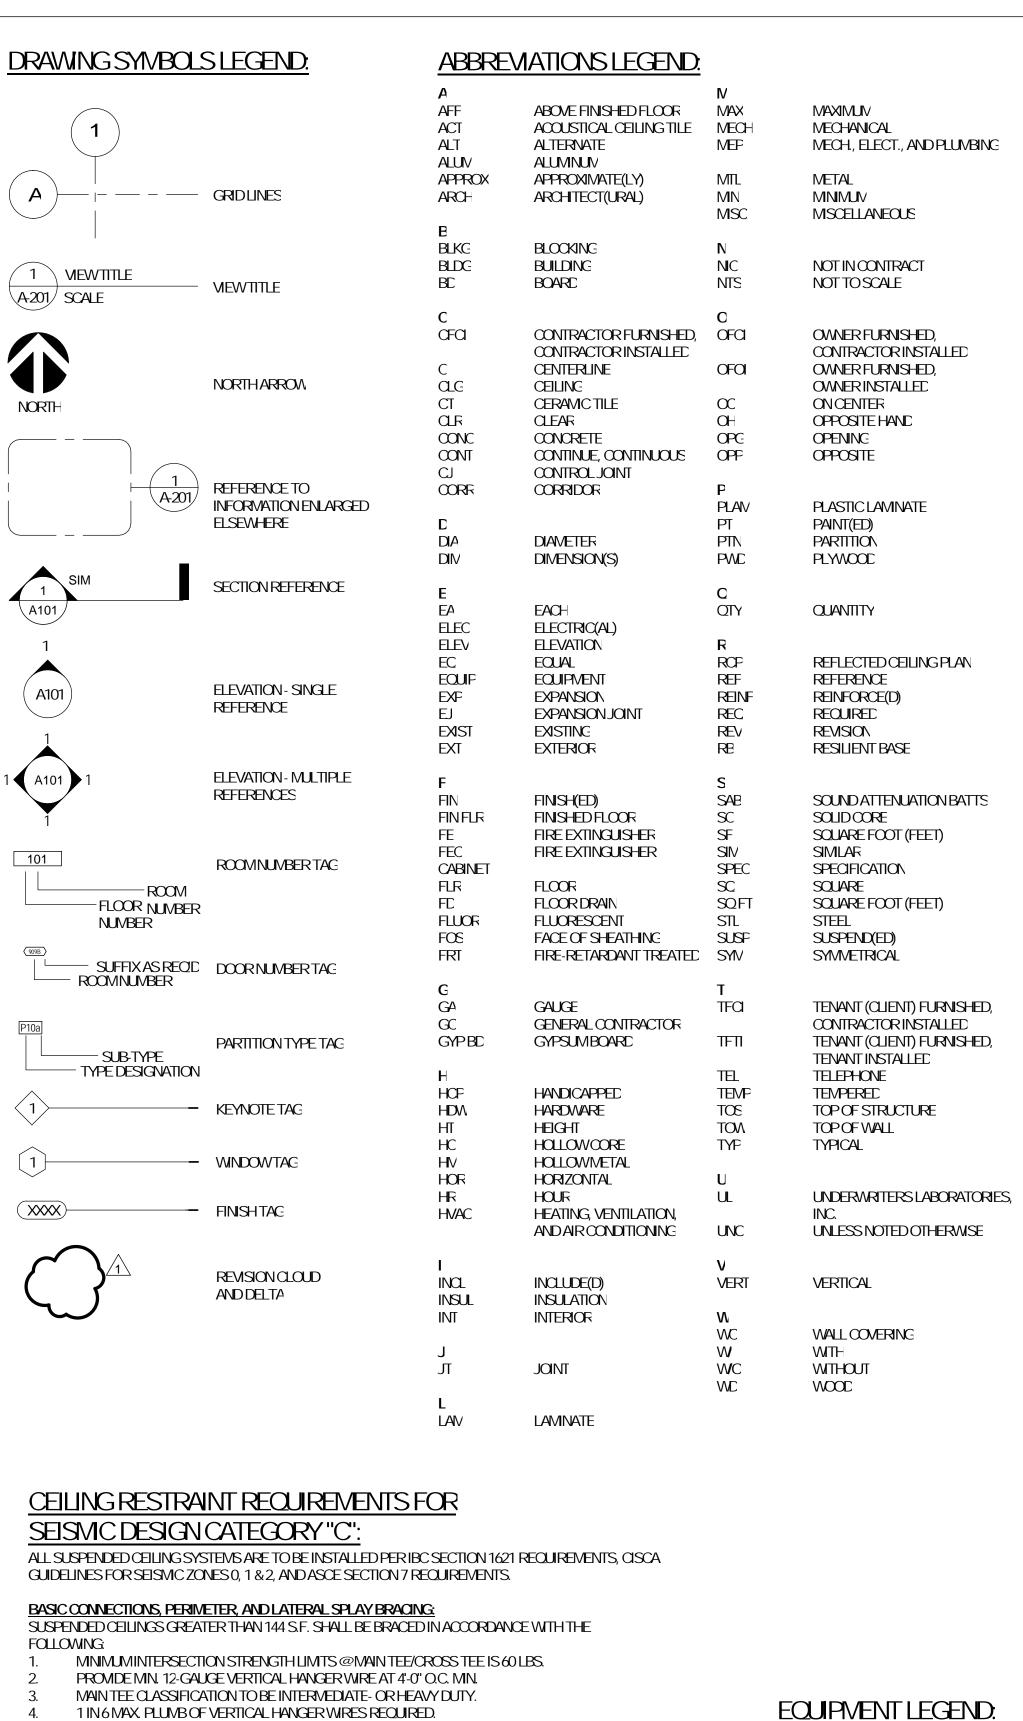
CONTACT: BRUCE COLEMAN E: BCOLEMAN@BRICPARTNERSHIP.COM

ο.	Date	Description
	04/14/17	ISSUED FOR BID

DRAWN BY: J.C.H.

PROJECT NUMBER: **16-1161.03**

LANDSCAPE PLAN



DEFINITION OF TERMS:

- THE WORD "CLIENT" AS USED IN THESE DOCUMENTS REFERS TO THE ENTITY WHO HAS CONTRACTED THE ARCHITECT TO PERFORMPROFESSIONAL SERVICES ON THIS PROJECT. THE WORD "PROJECT" AS USED IN THESE DOCUMENTS REFERS TO THE SCOPE OF WORK DESCRIBED IN THESE DOCUMENTS.
- THE WORDS "CONTRACTOR", "GENERAL CONTRACTOR", AND "G.C." AS USED IN THESE DOCUMENTS REFER TO THE GENERAL CONTRACTOR SELECTED BY THE CLIENT TO PERFORM 2 THE WORK DESCRIBED IN THESE DOCUMENTS. ALL NOTES IN THESE DOCUMENTS INSTRUCT THE GENERAL CONTRACTOR
- THE WORD "ARCHITECT" AS USED IN THESE DOCUMENTS REFERS TO ARCHITE-OF-RECORD.
- THE WORDS "CONSTRUCTION TEAM" REFER TO ALL PARTIES INVOLVED IN THE CONSTRUCTION PHASE, INCLUDING BUT NOT LIMITED TO: THE CLIENT AND THEIR CONSULTANTS; THE BUILDING OWNER, THE CONSTRUCTION MANAGER, THE GENERAL CONTRACTOR AND ALL SUBCONTRACTORS; THE CONSULTING ENGINEERS AND THE
- THE WORD "ALIGN" AS USED IN THESE DOCUMENTS SUPERSEDES ANY DIMENSIONAL INFORVATION INDICATED. IF DISCREPANCIES OCCUR, NOTIFY ARCHITECT IMMEDIATELY.
- THE WORD "PROMDE" AS USED IN THESE DOCUMENTS MEANS FURNISH AND INSTALL THE WORD "CLEAR" AS USED IN THESE DOCUMENTS SHALL MEAN THAT THE CONDITION IS NOT ADJUSTABLE WITHOUT THE APPROVAL OF THE ARCHITECT. CLEAR DIMENSIONS ARE TYPICALLY TO FINISH FACE OF MAJOR SURFACE. COORDINATE REQUIREMENTS FOR BASE
- BOARD HEATERS OR OTHER PROTRUSIONS WITH ARCHITECT THE WORD "MAXIMUM" OR "MAX." AS USED IN THESE DOCUMENTS SHALL MEAN THE CONDITION IS SLIGHTLY ADJUSTABLE BUT MAY NOT VARY TO A DIMENSION OR QUANTITY GREATER THAN THAT SHOWN WITHOUT APPROVAL OF THE ARCHITECT.
- ISSLIGHTLY ADJUSTABLE BUT MAY NOT VARY TO A DIMENSION OR QUANTITY LESS THAN THAT SHOWN WITHOUT APPROVAL OF THE ARCHITECT THE WORD "TYPICAL" OR "TYP" AS USED IN THESE DOCUMENTS SHALL MEAN THE CONDITION OR DIMENSION IS THE SAVE OR REPRESENTATIVE FOR SIMLAR CONDITIONS THROUGHOUT.

THE WORD "MINIMUM" OR "MIN" AS USED IN THESE DOCUMENTS SHALL MEAN THE CONDITION

THE SYMBOL "+/-" AS USED IN THESE DOCUMENTS SHALL MEAN THE DIMENSION OR QUANTITY IS ADJUSTABLE TO ACCOMMODATE ACTUAL CONDITIONS. IF ACTUAL DIMENSION VARIES BY MORE THAN 1" FROM DIMENSION NOTED AS "+/-", INFORMARCHITECT BEFORE PROCEEDING.

GENERAL NOTES: REFLECTED CEILING PLAN

- REVIEW CEILING LAYOUT AS SHOWN AND NOTIFY ARCHITECT OF ANY CONFLICTS WITH STRUCTURAL, ELECTRICAL, MECHANICAL, PIPEWORK, FIRE PROTECTION SYSTEMS, ETC. BEFORE PROCEEDING WITH CONSTRUCTION U.N.O. ALL NEW SUSPENDED ACOUSTICAL CEILING GRID AND TILE SYSTEMS ON PLANTO BE ACT-1. CENTER GRID ON COLUMN CENTERLINE OR REFERENCE GRID STARTING POINT ON
- PLAN. REFERTOFINISHLEGEND FOR SPECIFICATION. INSTALL NEW CEILINGS TO COVPLY WITH ALL SEISMIC RESTRAINT REQUIREMENTS IN ACCORDANCE WITH ALL LOCAL BUILDING CODES. REFER TO SEISMC INFORMATION ON SHEET
- U.N.O. LOCATE DOWNLIGHTS AND WALL WASHERS IN CENTER OF CEILING TILE. IF CONFLICT OCCURS, NOTIFY ARCHITECT PRIOR TO PROCEEDING CONTRACTOR TO VERIFY EXACT LOCATION OF ALL RECESSED DOWNLIGHTING IN G.W.B.
- CEILINGS. COORDINATE WITH ARCHITECT BEFORE PROCEEDING WITH THE WORK. REFER TO LIGHT FIXTURE LEGEND FOR LIGHT FIXTURE SPECIFICATION AND ADDITIONAL INFORMATION.
- U.N.O. ALL G.W.B. CEILINGS TO BE PAINTED PT-2. REFER TO FINISH LEGEND FOR SPECIFICATION. VERIFY EXACT LOCATION OF ALL RECESSED DOWNLIGHTING IN G.W.B.CEILINGS.
- COORDINATE WITH ARCHITECT BEFORE PROCEEDING WITH THE WORK U.N.O. INSTALL LINEAR DIFFUSERS IN ALL G.W.B. AND A.C.T. CEILINGS. U.N.O. ALL SPRINKLER HEADS IN G.W.B. AND A C.T. CEILINGS TO BE FULLY RECESSED TYPE.
- CENTER ALL SPRINKLER HEADS WITHIN 3" OF CENTER OF A.C.T. REFER TO ELEVATIONS FOR EXACT MOUNTING HEIGHTS OF ALL WALL-MOUNTED LIGHT FIXTURES.
- COORDINATE AND VERIFY LOCATION OF LIGHT SWITCHES, THERVOSTATS, FIRE ALARWS, ETC. WITH ARCHITECT BEFORE INSTALLATION.
- REFER TO ELECTRICAL DRAWINGS FOR DEVICE LOCATION DIAGRAM. ALL EXPOSED CEILING EDGES TO BE FINISHED. U.N.O. ALL G.W.B. CEILINGS IN RESTROOMS, SHOWER ROOMS AND OTHER WET LOCATIONS TO BEMOISTURE RESISTANT.
- ELECTRICAL CONTRACTOR TO COORDINATE SWITCHING AND DIMMING REQUIREVENTS AND LOCATIONS WITH ARCHITECT. U.N.O. LIGHTING IN EACH ROOM TO BE SWITCHED FROM ONE LOCATION WITHIN THAT ROOM
- U.N.O. ALL LIGHT FIXTURE TYPES WITHIN EACH ROOMOR OPEN OFFICE AREA TO BE SWITCHED SEPARATELY. GANG ALL SWITCHES IN EACH ROOM UNDER A SINGLE
- U.N.O. POWER OUTLETS, COMMUNICATIONS RECEPTAGLES, COVER PLATES, DEVICES, ETC. TC BE BUILDING STANDARD HEIGHT. REFER TO ELECTRICAL SHEETS FOR ELEC/COMMSYMBOLS AND ADDITIONAL INFORMATION.
- IDENTIFY AND COORDINATE LOCATIONS FOR ALL CEILING ELEVENTS INCLUDING LIGHTING, MECHANICAL DIFFUSERS, RETURN AIR GRILLES, FIRE PROTECTION DEVICES, ACCESS PANELS, EXIT SIGNS, AUDIOMSUAL EQUIPMENT, SECURITY DEMCES, ETC. WITH ARCHITECT BEFORE INSTALLATION.
- NOTIFY ARCHITECT OF ANY REQUIREMENTS FOR ACCESS PANELS NOT SHOWN ON DOCUMENTS BEFORE PROCEEDING WITH CONSTRUCTION.
- ELECTRICAL CONTRACTOR IS RESPONSIBLE FOR VERIFYING QUANTITY AND LOCATION OF EXIT LIGHTING. EXIT LIGHTING IS SHOWN IN PLANS ONLY TO IDENTIFY PATHS OF EGRESS. ALL EXPOSED DUCTWORK TO BE RIGID METAL DUCTWORK.
- U.N.O. PAINT ALL EXPOSED CEILINGS ELEVENTS INCLUDING BUT NOT LIMITED TO STRUCTURE, UNDERSIDE OF ROOF DECK, DUCTWORK, CONDUIT, PIPING, WIRING, AND SPRINKLER SYSTEMS PT-2.

GENERAL NOTES: FINISH

- G.C. TO REMEWAND SUBMIT TO ARCHITECT ALL MATERIALS IN FINISH LEGEND. REFER TO PLANS, RCP, ELEVATIONS, FINISH SCHEDULE, DOOR SCHEDULE, AND DETAILS FOR FINISHINFORMATION AND LOCATIONS. SAMPLES TO BE THE SPECIFIED COLOR AND FINISH FOR REVIEW. SUPPLY AMNIMUM OF FIVE COPIES OF EACH ITEM ARCHITECT, GENERAL CONTRACTOR, SUE-CONTRACTOR, FIELD COPY, AND CLIENT. REFER TO PLANS, RCP, FINISH LEGEND, AND DETAILS TO VERIFY FINISHES. REFER TO
- ELEVATIONS FOR ADDITIONAL FINISH INFORMATION OR WHERE MULTIPLE FINISHES ARE INDICATED ON PLAN FOR THE SAME WALL THE FINISH NAVE TAKES PRECEDENT OVER THE FINISH PRODUCT NUMBER WHEN
- ORDERING MATERIALS. CONTACT ARCHITECT WITH DISCREPANCIES BEFORE ORDERING
- IDENTIFY AND INFORM CONSTRUCTION TEAMOF ALL CRITICAL PATH ITEMS, CRITICAL DEADLINES, AND DATE OF SUBSTANTIAL COMPLETION.
- PATCH AND REPAIR EXISTING FINISHES AS REQUIRED WHERE DEVOLITION OR NEW CONSTRUCTION OCCURS. NEW FINISHES TO MATCH EXISTING IN MANUFACTURER, COLOR, FINISH, AND TEXTURE. WHERE MATERIALS ARE NOT AVAILABLE FOR EXACT MATCH, SUBMIT MATERIALS FOR SUITABLE REPLACEMENT BEFORE PURCHASE OR
- INSTALLATION. PATCH AND REPAIR OR REPLACE ANY EXISTING FINISHES IN BUILDING COMMON AREAS OUTSIDE SCOPE OF WORK IF DAVAGE OCCURS RELATED TO THE CONSTRUCTION OF THE **SCOPE OF WORK**
- ALL INTERIOR FINISH AND SUNDRIES TO MEET OR EXCEED CLASS II FLAVE SPREAD, 26-75 AND SWOKE DEVELOPMENT RATING LESS THAN 450 AND ALL OTHER APPLICABLE
- ALL IMPACT-RESISTANT PANELS TO BE CLASS 1 COMPONENTS. TESTED IN ACCORDANCE WITH UL-723 (ASTIV-E849A) FLAVE SPREAD 20 OR LESS. SWOKE DEVELOPED 400 OR LESS. ALL VINYL WALL COVERING FIRE HAZARD CLASSIFICATION (ASTIV-E-84) FLAVE SPREAD 5, FUEL CONTRIBUTION 0, SMOKE DENSITY FACTOR 5.
- MAINTAIN AND PROTECT EXISTING FLOORING AND FINISHES TO REMAIN DURING CONSTRUCTION. CLEAN AND PREPARE FLOOR AREA SCHEDULED TO RECEIVE NEW FLOORING SO THE AREAS ARE ABLE TO ACCEPT NEW FLOORING, AND MAINTAIN REQUIRED FLOOR ASSEMBLY RATING, TO BE FLUSHAND CONTINUOUS WITH ADJACENT FLOOR SURFACE, AS REQUIRED FOR NEW FINISH.
- U.N.O. ALL PARTITIONS, EXTERIOR WALLS AND COLUMNS TO RECEIVE PAINT PT-1 AND BASE RE-1.
- U.N.O. ALL G.W.B. CEILINGS TO BE PAINTED PT-2. REFER TO REFLECTED CEILING PLAN FOR ADDITIONAL CEILING FINISHES. U.N.O. ALL HOLLOWIVETAL FRAVES TO RECEIVE PAINT PT-3. REFER TO DOOR SCHEDULE FOR ADDITIONAL INFORMATION.
- U.N.O. ALL METAL DOORS TO RECEIVE PAINT PT-3. REFER TO DOOR SCHEDULE FOR ADDITIONAL INFORMATION.
- U.N.O. ALL PAINTED SURFACES TO RECEIVE A MINIMUMOF ONE (1) PRIMER COAT AND THEN TWO (2) FINISH PAINT COATS. TINT PRIVER COAT PERMANUFACTURERS SPECIFICATIONS.
- U.N.O. ALL PARTITIONS RECEIVING PAINT (PT-?), (PT-?), OR (PT-?) TO RECEIVE A LEVEL FIVE (5) FINISH PRIOR TO PRIME AND FINISH COATS TO AVOID PAINT FLASHING.
- ADDITIONAL FINISH COATS WILL BE REQUIRED. U.N.O. ALL GLASS IN DOORS AND SIDELITES TO BE GLASS GL-2. U.N.O. ALL WOOD DOORS AND TRIMTO RECEIVE STAIN ST-1. REFER TO DOOR SCHEDULE
- FOR ADDITIONAL INFORMATION. ANY WALLCOVERING WITH RECOR BACKING TO BE ADHERED WITH HEAVY-DUTY CLAY
- CLEAN AND PREPARE FLOOR AREA TO ACCEPT NEW FLOORING, MAINTAINING REQUIRED FLOOR ASSEMBLY RATING, TO BE FLUSH AND CONTINUOUS WITH ADJACENT FLOOR
- SURFACE, AS REQUIRED FOR NEWFINISH. U.N.O. ALL FLOORING SHALL BE INSTALLED PER MANUFACTURER'S RECOMMENDATION. VERIFY WITH ALL MANUFACTURERS AND SUPPLIERS.
- U.N.O. ALL FLOORING TRANSITIONS TO BEGIN AT CENTER LINE UNDER DOOR REFER TO TRANSITION DETAILS FOR ALL FLOORING CHANGES.
- U.N.O. ALL RESILIENT BASE TO BE RESILIENT BASE RE-1, 4" STRAIGHT AT CARPET AND 4" COVE AT HARD SURFACE FLOORING.
- U.N.O. ALL RESILIENT AND TILE FLOORING TO EXTEND UNDER MILLWORK. ALL COUNTERTOP EDGE PROFILES TO BE AN EASED EDGE.
- REFER TO INTERIOR ELEVATIONS AND MILWORK SECTIONS FOR FINISH INFORMATION. U.N.O. ALL WALLCOMERING SHALL BE INSTALLED PER MANUFACTURERS INSTRUCTIONS. AFTER HANGING 3 LENGTHS OF THE WALLCOVERING MATERIAL, CHECK FOR ANY
- DEFECTS. IF THERE IS A PROBLEM CONTACT YOUR SUPPLIER IMMEDIATELY, IF THE PROBLEM CAN NOT BE RESOLVED IN A TIMELY MANNER. CONTACT THE ARCHITECT. U.N.O. ALL CABINETS HARDWARE PULLS HM-1. U.N.O. ALL MILLWORK BACKSPLASHES TO BE 4" TALL
- U.N.O. ALL EXPOSED ENDS AND OPEN MILLWORK TO MATCH FINISH OF EXTERIOR 30. MILLWORK.
- U.N.O. ALL MILLWORK INTERIORS TO BE WHITE MELAMINE
- PAINT ALL PLYWOOD TO MATCH NEW WALL FINISH TO WHICH IT IS ATTACHED. WOOD VENEERS TO BE APPLIED FLUSH AND SWOOTH TO SUBSTRATE WITH NO RIPPLING
- TOLERATED. NO GLUE UP WOOD BASE TOLERATED.
- ALL WOOD SHALL BE OF THE SAVE SPECIES AND SAVE CUT OF WOOD.
- ALL WOOD (VENEER, HARDWOOD) SHALL BE ORDERED AT THE SAVE TIME FROM THE SAVE LOT WITH A SAVPLE FROM THE LOT SUBMITTED TO THE ARCHITECT FOR APPROVAL. NOTIFY ARCHITECT IMMEDIATELY OF NEED TO HAVE TWO LOTS OF WOOD, IN WHICH CASE A SAVPLE FROM EACH LOT MUST BE SUBMITTED FOR APPROVAL

MILLWORK CONSTRUCTION TO COVPLY WITH LATEST EDITION OF A W.I. STANDARDS.

<u>U.N.O. ALL PAINTED SURFACES TO RECEIVE THE FOLLOWING FINISHES:</u> G.W.B. VERTICAL WALL SURFACES - EGGSHELL (SATIN) G.W.B. CEILINGS, SOFFITS, BULKHEADS - FLAT HOLLOWMETAL SURFACES - SEMI-GLOSS PAINTED WOOD SURFACES - SEMI-GLOSS CONCRETE MASONRY UNIT - EGGSHELL

GENERAL NOTES: ARCHITECTURAL

- THE CONTRACTOR SHALL MST THE SITE AND BE KNOWLEDGEABLE OF CONDITIONS THEREON, AND SHALL INVESTIGATE, VERIFY AND BE RESPONSIBLE FOR ALL CONDITIONS OF THE PROJECT, AND SHALL NOTIFY THE OWNER OF ANY CONDITIONS REQUIRING MODIFICATION BEFORE PROCEEDING WITH THE WORK
- THE CONTRACTOR SHALL THOROUGHLY REMEWTHE CONTRACT DOCUMENTS PRIOR TO CONSTRUCTION AND AS AVENDVENTS MAY BE MADE AS CONSTRUCTION PROCEEDS, AND SHALL NOTIFY THE ARCHITECT OF ANY DISCREPANCIES, CONFLICTS, INCONSISTENCIES, ERRORS OR OMSSIONS THAT MAY BE DISCOVERED. IN SUCH CASES THE CONTRACTOR IS TO OBTAIN CLARIFICATION OR VERIFICATION OF INTENT PRIOR TO PROCEEDING WITH THE WORK.
- THE WORK IS TO BE PERFORVED IN CONFORVANCE WITH APPLICABLE WRITTEN CODES, ORDINANCES, LAWS, RULES, REGULATIONS AND REQUIREMENTS OF AUTHORITIES HAMNG JURISDICTION. IF THE CONTRACTOR PERFORIVS OR PROCEEDS IN A MANNER CONTRARY TO ANY SUCH REQUIREMENTS THE CONTRACTOR ASSUMES FULL RESPONSIBILITY THEREFORE AND SHALL BEAR COSTS RESULTING FROM NONCOMPLIANCE OR MOLATION, INCLUDING COSTS ASSOCIATED WITH REPAIRING, REPLACING OR OTHERWISE BRINGING THE WORK INTO CONFORMANCE. THE CONTRACTOR IS TO BRING TO THE ARCHITECT'S ATTENTION ANY CONDITIONS REPRESENTED IN THE CONTRACT DOCUMENTS THAT ARE NOT IN CONFORMANCE WITH APPLICABLE REQUIREMENTS. THE CONTRACTOR IS TO MAINTAIN ON SITE A COPY OF THE APPLICABLE EDITION OF THE UL FIRE
- RESISTANCE DIRECTORY AND OTHER FIRE RESISTIVE STANDARDS REFERENCED IN THE CONTRACT DOCUMENTS FOR USE BY INSPECTORS AT TIMES OF INSPECTION. CONTRACT DOCUMENTS SHALL NOT BE REPRODUCED AS THE BASIS FOR REQUIRED SUBMITTALS
- UNLESS PRIOR WRITTEN PERMISSION HAS BEEN OBTAINED FROM THE ARCHITECT. SUBMITTALS CONTAINING CONTRACT DOCUMENTS OR PORTIONS OF CONTRACT DOCUMENTS WILL BE REJECTED AND RETURNED TO THE CONTRACTOR WITHOUT ACTION OR COMMENT, AND ARE NOT TO BE USED. FOR PROCUREMENT, FABRICATION OR INSTALLATION OF ANY WORK IN THE PROJECT.
- WHERE WORK OR EQUIPMENT IS INDICATED AS 'NOT IN CONTRACT (NIC)' IN THE DOCUMENTS, SUCH WORK OR EQUIPMENT SHALL BE PROMDED OUTSIDE THE CONTRACT SCOPE REPRESENTED IN THESE DOCUMENT. THE CONTRACTOR SHALL COORDINATE HIS WORK WITH NIC ITEVS AND COOPERATE TO AFFECT THE IMPLEIVENTATION OF SUCH WORK OR INSTALLATION. DETAILS NOT SHOWN ARE TO BE SIMLAR IN CHARACTER TO THOSE DRAWN. WHERE SPECIFIC

DIMENSIONS, DETAILS OR DESIGN INTENT CANNOT BE DETER-MINED THE CONTRACTOR IS TO

- OBTAIN CLARIFICATION FROM THE ARCHITECT BEFORE PROCEEDING WITH THE WORK PROMDE BLOCKING IN STUD WALLS BEHIND ITEMS SUPPORTED BY WALLS, OF SIZES, LENGTHS AND HEIGHTS AS REQUIRED. ATTACH BLOCKING TO STUDS WITH TYPE, SIZE, NUMBER AND SPACING OF ANCHORS AS REQUIRED TO PROPERLY SUPPORT LOADS OF ITEMS SUPPORTED. WHERE WOOD BLOCKING IS USED IT IS TO BE FIRE RETARDANT TREATED. WHERE METAL IS USED PROMDE MIN 1/8 INCHTHICK PLATE, WELDED, SCREWED OR BOLTED TO METAL STUD FRAMING. IF PLATES ARE NOT LOCATED COVPLETELY BEHIND ITEMS SUPPORTED, LET PLATES INTO STUDS OR OTHERWISE CONFIGURE SO THAT THERE ARE NO VISIBLE BULGES IN SURFACE OF FINISHED GYPSUMBOARD DUE TO THICKNESS OF PLATES BETWEEN STUDS AND GYPSUMBOARD.
- TO PREVENT GALVANIC ACTION BETWEEN DISSIMLAR METALS, WHERE DISSIMLAR METALS COME INTO CONTACT WITH EACH OTHER, WHERE METALS COME INTO CONTACT WITH WOOD, CONCRETE OR MASONRY, WHERE RUNOFF FROM A METAL SURFACE FLOWS OVER A DISSIMLAR METAL, OR WHERE NON-PASSIVE METAL FASTENERS PENETRATE DISSIMLAR METALS, BREAK THE CONTACT BETWEEN MATERIALS WITH A HEAVY WATERPROOF PAPER OR FELT, A HEAVY COAT OF BITUMNOUS COATING OR AN ELASTOMERIC FILMUNLESS OTHER SEPARATOR IS INDICATED IN THE CONTRACT DOCUMENTS.
- STEEL EXPOSED TO WATER AND/OR EXTERIOR WEATHER CONDITIONS IS TO BE GALVANIZED UNLESS INDICATED OTHERWISE. WHERE CUTTING, FASTENING, ANCHORAGE OR CONNECTION CONDITIONS RESULT IN BREAKS IN THE GALVANIZING COATING, RESTORE COATING OR APPLY ADDITIONAL COMPATIBLE PROTECTIVE COATING TO MAINTAIN INTEGRITY OF PROTECTION
- SHEET METAL FLASHING SHALL BE OF APPROPRIATE THICKNESS AND SIZES, AND DETAILED, CONFIGURED AND INSTALLED SO AS TO ALLOW FOR ACCEPTABLE THERWAL MOVEMENTS WITHOUT MSIBLE DISTORTIONS, LEAKS OR FAILURES OF THE FLASHING SYSTEMS ABILITY TO PERFORMAS REQUIRED BY THE CONTRACT DOCUMENTS.
- EDGE OF DOOR SHALL BE LOCATED 6" OFF PERPENDICULAR WALL UNLESS OTHERWISE NOTED. ALL WOOD BLOCKING TO SECURE CABINETS, MARKER BOARDS, ETC. TO PARTITIONS SHALL BE FIRE RETARDANT WOOD BLOCKING.
- CONTRACTOR SHALL VERIFY ALL DIMENSIONS AND CONDITIONS SHOWN ON THE DRAWINGS AT THE JOB SITE AND SHALL NOTIFY ARCHITECT OF ANY OMSSIONS. DISCREPANCIES. AND/OR CONFLICTS
- BEFORE PROCEEDING WITH THE JOB. DO NOT SCALE DRAWINGS, DIMENSIONS GOVERN, LARGE SCALE DETAILS GOVERN OVER SMALL
- SCALE
- PARTITIONS SHALL BE DIMENSIONED TO FACE OF PARTITION UNLESS NOTED OTHERWISE. 17. ALL DISSIMLAR METAL MATERIALS SHALL BE ISOLATED WITH A NON-METALLIC SEPARATOR. 18. ALL MATERIALS USED IN FIRE-RATED ASSEMBLIES SHALL BE APPROVED BY U.L. OTHER RECOGNIZED STANDARD FOR USE IN SUCH ASSEMBLIES.
- ALL BUILDING ACCESSIBILITY IS DESIGNED AND SHALL BE IN ACCORDANCE WITH I.B.C., ANSI 117.1 2003. ADAAG AND DOJ 2010 ADA STANDARDS FOR ACCESSIBLE DESIGN. WHICHEVER STANDARD PROMDES THE GREATEST DEGREE OF ACCESSIBILITY FOR ANY GIVEN BUILDING ELEMENT.
- EXIT DOORS SHALL BE OPERABLE FROM THE INSIDE WITHOUT THE USE OF A KEY, SPECIAL KNOWLEDGE, OR EFFORT. THE OPERATION OF THE SECURITY DEVICES SHALL BE COMPLIANT WITH THE CODES.
- SIGNAGE INDICATING ACCESSIBLE ENTRANCES, RESTROOMS, SIGNS PLAINLY VISIBLE STATING "ELECTRICAL ROOM" AND ANY OTHER INTERIOR SIGNAGE REQUIRED BY CODE SHALL BE PROMDED BY OWNER AND INSTALLED BY CONTRACTOR 22. ALL EXITS SERMING A REQUIRED ACCESSIBLE SPACE, BUT NOT PROMDING AN ACCESSIBLE MEANS
- OF EGRESS, SHALL PROMDE SIGNS INDICATING THE LOCATION OF ACCESSIBLE MEANS OF EGRESS. SIGNS WILL BE BY OWNER AND INSTALLED BY CONTRACTOR SEE SHEET A-902 FOR PARTITION TYPES.
- FOR ALL DOORS INTO ELECTRICAL CONTROL PANELS, HANDLES, PULLS, LATCHES, LOCKS, AND OTHER OPERATING DEVICES ON ACCESSIBLE DOORS SHALL HAVE A SHAPE THAT IS EASY TO GRASP WITH ONE HAND AND DOES NOT REQUIRE TIGHT GRASPING, TIGHT PINCHING, OR TWISTING OF THE WRIST TO OPERATE LEVER- OPERATED MECHANISMS, PUSH-TYPE MECHANISMS, AND L-SHAPED HANDLES ARE ACCEPTABLE DESIGNS, WHEN SLIDING DOORS ARE FULLY OPEN, OPERATING HARDWARE SHALL BE EXPOSED AND USABLE FROMBOTH SIDES. HARDWARE REQUIRED FOR ACCESSIBLE DOOR PASSAGE SHALL BE MOUNTED NO HIGHER THAN 48" ABOVE FINISH FLOOR.
- FROMAN OPEN POSITION OF 70 DEGREES, THE DOOR WILL TAKE AT LEAST 3 SECONDS TO MOVE TO A POINT 3 INCHES FROM THE LATCH, MEASURED TO THE LEADING EDGE OF THE DOOR. THE MAXIMUM FORCE FOR PUSHING OR PULLING OPEN A DOOR SHALL BE AS FOLLOWS: (1) FIRE DOORS SHALL HAVE THE MINIMUMOPENING FORCE ALLOWABLE BY THE APPROPRIATE ADMNISTRATIVE AUTHORITY. (2) OTHER DOORS. (A) INTERIOR HINGED DOORS: 5 IBF (22.2N) (B)

IF A DOOR HAS A CLOSER, THEN THE SWEEP PERIOD OF THE CLOSER SHALL BE ADJUSTED SO THAT

- SLIDING OR FOLDING DOORS: 5 IBF (22.2N) THESE FORCES DO NOT APPLY TO THE FORCE REQUIRED TO RETRACT LATCH BOLTS OR DISENGAGE OTHER DEVICES THAT MAY HOLD THE DOOR IN A CLOSED POSITION. TACTILE SIGNAGE SHALL BE LOCATED ON THE WALL ADJACENT TO THE DOORS SIDE AND AT A
- HEIGHT OF 60 INCHES ABOVE THE FLOOR. SIGNS MAY BE LATCH PLACED ON THE NEAREST ADJACENT WALL WHEN THERE IS NO WALL SPACE ON THE LATCH SIDE
- EACH GLAZING UNIT SHALL BEAR THE MANUFACTURER'S LABEL DESIGNATING THE TYPE AND THICKNESS OF GLASS. GLAZING LOCATED WITHIN 24" OF A DOOR AND LESS THAN 60' ABOVE WALKING SURFACE SHALL BE SAFETY GLAZED.
- 29. ACCESSIBLE TOILET FACILITIES SHALL BE IDENTIFIED WITH A SIGN, PROMDED BY OWNER AND INSTALLED BY CONTRACTOR.
- ALL BUILDING ENTRANCES / EXITS ARE ACCESSIBLE. ACCESSIBLE DOOR'S SHALL HAVE A LANDING ON BOTH SIDES. LANDINGS SHALL BE NOMORE THAN
- 1/2 INCH BELOWTHE TOP OF THE DOOR THRESHOLD.
- DOORS SHALL HAVE A SWOOTH, UNINTERRUPTED SURFACE ON THE LOWER 10 INCHES. FOR CORNER GUARD LOCATIONS & INFORMATION REFERENCE THE FINISH LEGEND AND FINISH
- REFER TO AWI STANDARDS FOR MILLWORK CONSTRUCTION. INSTALL MOISTURE RESISTANT GYP. BOARD AT ALL WALLS, INCLUDING BUT NOT LIMITED TO
- LAVATORY LOCATIONS. CONTRACT DOCUMENTS SHALL NOT BE REPRODUCED AS THE BASIS FOR REQUIRED SUBMITTALS UNLESS PRIOR WRITTEN PERMSSION HAS BEEN OBTAINED FROM THE ARCHITECT. SUBMITTALS CONTAINING CONTRACT DOCUMENTS OR PORTIONS OF CONTRACT DOCUMENTS WILL BE REJECTED AND RETURNED TO THE CONTRACTOR WITHOUT ACTION OR COMMENT, AND ARE NOT TO BE USED

FOR PROCUREMENT, FABRICATION OR INSTALLATION OF ANY WORK IN THE PROJECT.



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JOHN EDWARD MUELLER MOARCHTECTURAL LICENSE A2010039554 MO CERTIFICATE OF AUTHORITY A2014008380

No.	Date	Description
	04/14/17	ISSUED FOR BID

DRAWNBY: SC/SH

PROJECT NUMBER: 16-1161.03 SHEET TITLE:

SYMBOLS AND ABBREVIATIONS

SUPPORT PENDANT-HUNG FIXTURES DIRECTLY FROM STRUCTURE WITH 9-GAUGE WIRE OR APPROVED ALTERIVATE

SURFACE-MOUNTED FIXTURES DO NOT REQUIRE ATTACHMENT TO GRID.

FOR RIGID LAY-IN OR CAN LIGHT FIXTURES WEIGHING LESS THAN 10 LBS PROMDE (1) WIRE TO STRUCTURE (MAY BE SLACK). FOR RIGID LAY-IN OR CAN LIGHT FIXTURES WEIGHING FROM 10 TO 56 POUNDS PROMDE (2) VERTICAL SUPPORT WIRES (MUST BE SLACK). FOR LIGHT FIXTURES GREATER THAN 56 POUNDS PROMDE DIRECT AND INDEPENDENT SUPPORT FROM THE BUILDING

PROMDE MINIMUM7/8" PERINETER CLOSURE (MOLDING). IF WOLDING IS LESS THAN 7/8" PROMDE

NO. 12 GA HANGER WIRES AROUND ENTIRE PERIMETER OF CEILING AT EACH TEE AT A MAX. OF

8" OFF THE WALL AND 4"-0" EACH DIRECTION AT NO MORE THAN 1-IN-6 OUT OF PLUMB; ATTACH

GRID CONNECTION TO PERIMETER ATTACHED ON TWO ADJACENT WALLS IS NOT PERMITTED.

MECHANICALLY ATTACHALL LIGHT FIXTURES TO CEILING GRID. ATTACHMENTS MUST SUPPORT

PARTITION ATTACHMENT IS ALLOWED ONLY OF CEILING IS ABLE TO MOVE LATERALLY.

SERMCE APPLICATIONS:

BRACING

LIGHT FIXTURE ATTACHMENT:

TOWALLOR STRUCTURE ABOVE.

100% OF LIGHT FIXTURE WEIGHT.

TIE PERIMETER TEE ENDS TOGETHER

PROMDEMN. 3/8" GRID END TO WALL CLEARANCE.

ALL MECHANICAL AIR TERMINALS MUST BE POSITIVELY ATTACHED TO THE CEILING GRID. FOR TERMINALS WEIGHING FROM 20 TO 56 POUNDS PROMDE (2) VERTICAL SUPPORT WIRES (MAY BE SLACK) FOR TERMINALS WEIGHING GREATER THAN 56 POUNDS PROMDE DIRECT AND INDEPENDENT SUPPORT FROM THE BUILDING STRUCTURE. SPRINKLER HEADS AND OTHER PENETRATIONS REQUIRE AMN. 3/8" CLEARANCE ON ALL SIDES.

CABLE TRAYS AND ELECTRICAL CONDUIT DO NOT REQUIRE INDEPENDENT SUPPORT OR

AND ADDITIONAL REQUIREMENTS. MCROWAVE (T.F.T.I.) PROMDE REQUIRED ELECTRICAL COORDINATE STRUCTURE WITH CLIENT FOR SPECIFICATION AND ADDITIONAL REQUIREMENTS. <u>VENDING-SNACK (T.F.C.I.):</u>

COFFEE MAKER (T.F.C.I.):

REFRIGERATOR (T.F.C.I.):

ICE MAKER (T.F.C.I.):

AND ADDITIONAL REQUIREMENTS.

AND ADDITIONAL REQUIREMENTS.

PROMDE REQUIRED ELECTRICAL AND PLUMBING.

COORDINATE WITH CLIENT FOR SPECIFICATION

PROMDE ELECTRICAL DUPLEX RECEPTACLE

COORDINATE WITH CLIENT FOR SPECIFICATION

PROMDE REQUIRED ELECTRICAL AND PLUMBING.

COORDINATE WITH CLIENT FOR SPECIFICATION

PROMDE REQUIRED ELECTRICAL COORDINATE

WITH CLIENT FOR SPECIFICATION AND

ADDITIONAL REQUIREMENTS.

l av l

F = = =

REF

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REFLECTED CEILING SYMBOLS LEGEND.


NEW2x2 CEILING GRID AND TILE, SEE FINISH LEGEND NEWGYPSUMBOARD CEILING 2x2 FLUORESCENT LIGHT FIXTURE 2x4' FLUORESCENT LIGHT FIXTURE RECESSED CAN LIGHT FIXTURE LINEAR PENDANT FIXTURE

DECORATIVE PENDANT FIXTURE

SUPPLY DIFFUSER

RETURN DIFFUSER

EXITSIGN

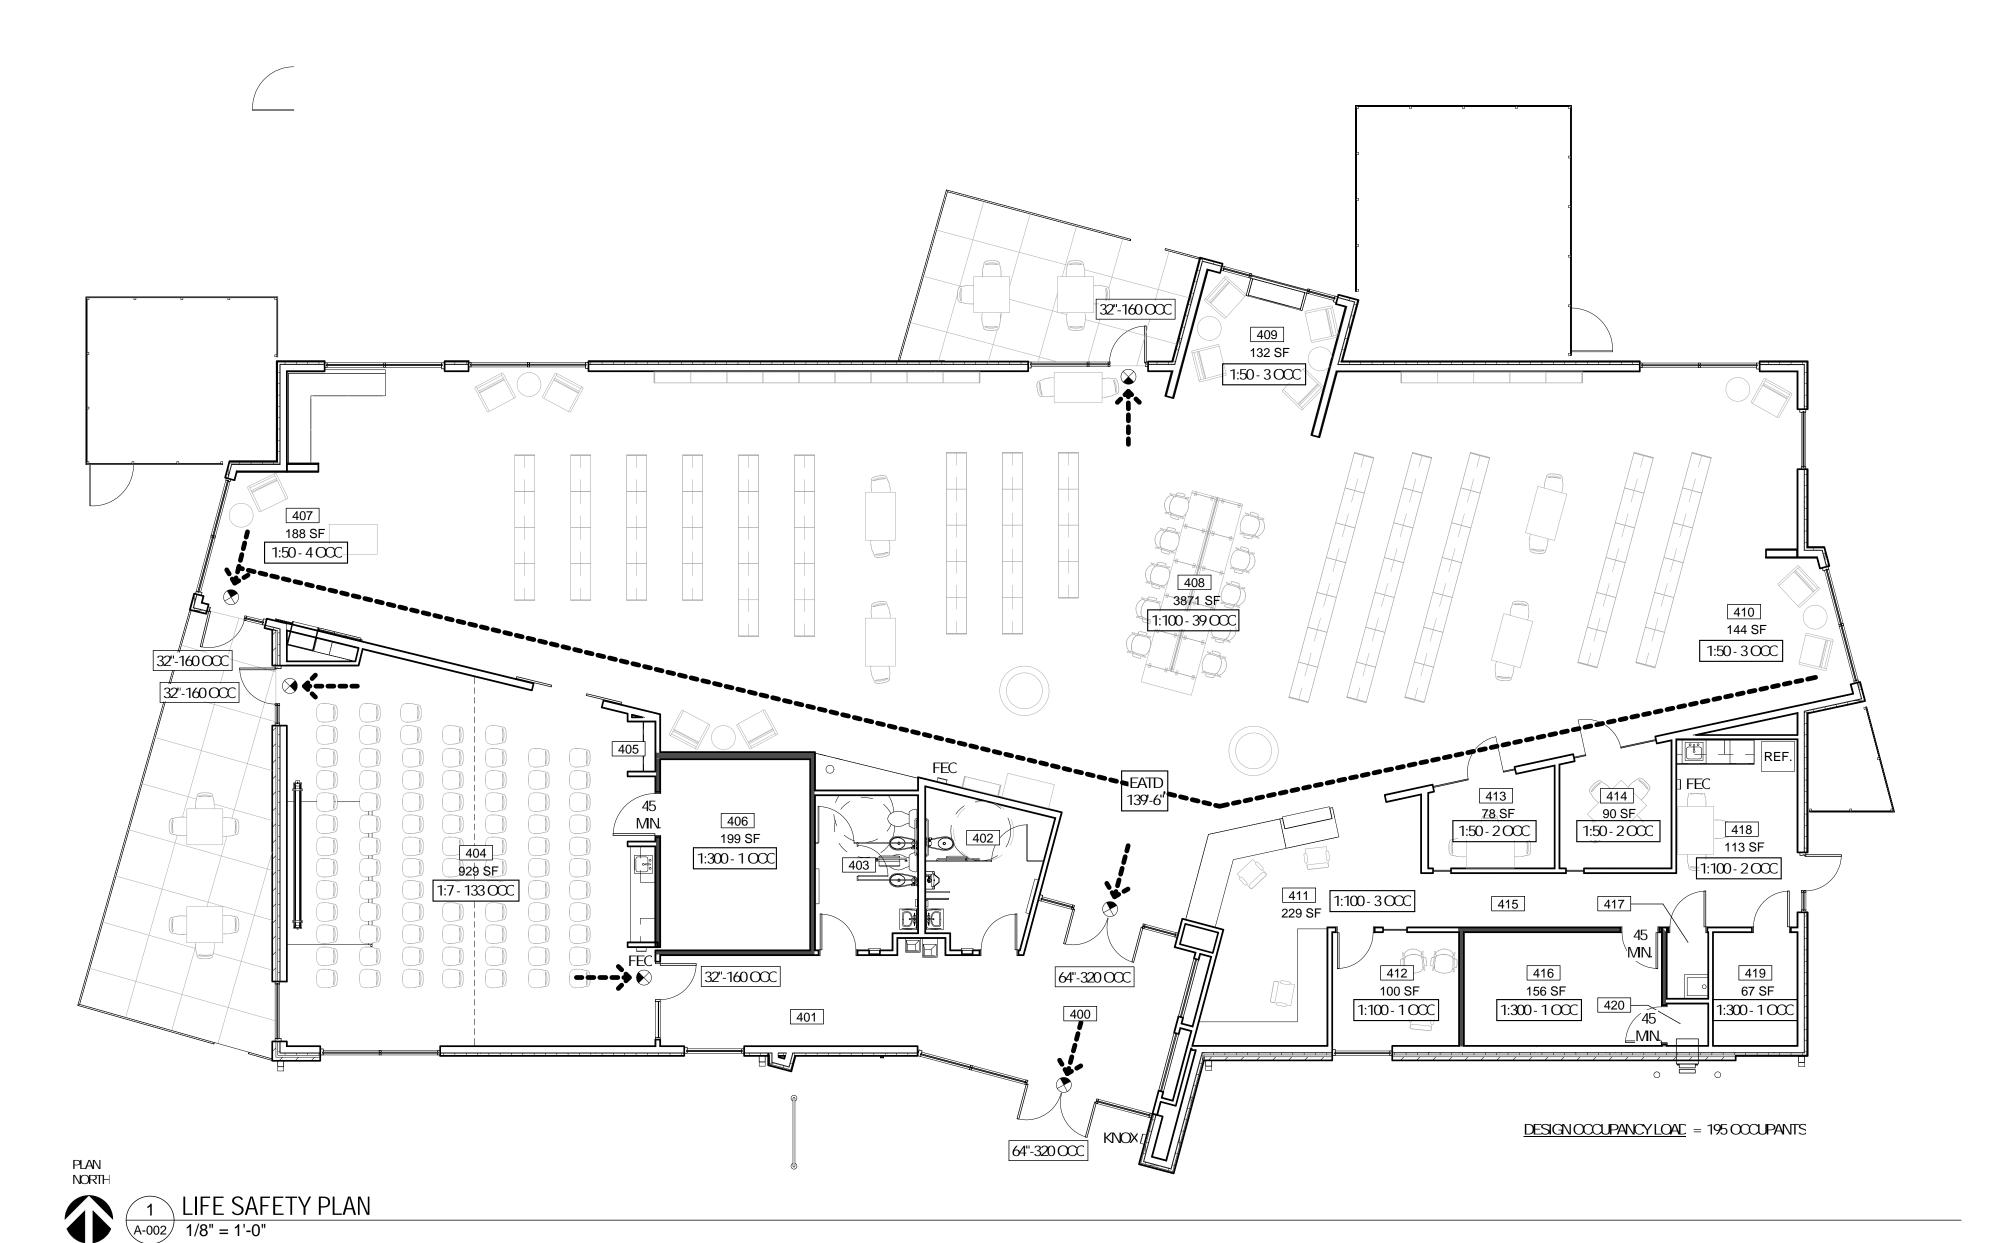

CODE INFORMATION

CITY OF WRIGHT CITY, MO (WARREN COUNTY) <u>AUTHORITIES HAMNGJURISDICTION:</u> WRIGHT CITY FIRE PROTECTION DISTRICT

BUILDING CODE: INTERNATIONAL BUILDING CODE (IBC) 2009 EDITION

ACCESSIBILITY: AMERICANS WITH DISABILITIES ACT

ICC/ANSI A117.1, REFERENCED BY BUILDING CODE

INTERNATIONAL FIRE CODE (IFC) 2009 EDITION FIRE PREVENTION:

INTERNATIONAL MECHANICAL CODE (IMC) 2009 EDITION MECHANICAL:

ELECTRICAL: NATIONAL ELECTRICAL CODE, 2008 EDITION, WITH CITY ADDITIONS.

<u>PLUMBING</u> INTERNATIONAL PLUMBING CODE (IPC) 2009 EDITION

PROPERTY MAINTENANCE: INTERNATIONAL PROPERTY MAINTENANCE CODE (IPVC) 2009 EDITION

BUILDING INFORMATION

RATINGS

<u>USE GROUPS</u> <u>RATING:</u> 0 HOUR COLUMN ASSEMBLY, LIBRARY OMNUTE MODERATE HAZARD STORAGE (ACCESSORY USE, SEE LIFE CORRIDOR OMNUTE SAFETY PLAN, SHEET A-002) DOOR 0 HOUR FLOOR 0 HOUR CONSTRUCTION TYPE: STORAGE

TYPE IIE NON-SPRINKLERED, NOT PROTECTED

REFER TO CISCA GUIDELINES FOR REQUIREMENTS

<u>AREA:</u> FLOOR ACTUAL GSF DESIGN OCCUPANCY: FIRST FLOOR 7,695 SF 195 OCCUPANTS

ALLOWABLE HEIGHT AND AREA:

USE GROUP A-3 IS MOST RESTRICTIVE USE. ALLOWABLE HEIGHT AND AREA, IBC TABLE 503 - 2 STORIES AND 9,500 SF.

FIRE RESISTANCE RATINGS-HOURS: BUILDING ELEVENT TYPE TYPE IIB

STRUCTURAL FRAME, COLUMNS, GIRDERS & TRUSSES BEARINGWALLS - EXTERIOR / INTERIOR NON-BEARING WALLS & PARTITIONS-INTERIOR FLOOR CONSTRUCTION INCLUDING BEAVIS & JOIST ROOF CONSTRUCTION INCLUDING BEAVS & JOIST

THE EXIT CAPACITY FOR EACH FLOOR AREA MUST BE SUFFICIENT FOR THE OCCUPANT LOAD AS CALCULATED. EXIT CAPACITY IS DETERMINED BY DIVIDING THE CLEAR WIDTH OF EACH EXIT COMPONENT BY THE APPROPRIATE FACTOR NOTED BELOW

DOORS/AISLES - 0.20" PER OCCUPANT

IBC OCCUPANCY CALCULATIONS:

OCCUPANCY TYPE: AREA PER OCCUPANT

GENERAL LIBRARY STACK AREA 100 SF 50 SF READING ROOMS MEETING ROOM(S) (CONCENTRATED CHAIRS ONLY) 7SF

SECTION 903 AUTOMATIC SPRINKLER SYSTEM

903.2.1.3 GROUP A-3, NONE OF THE (3) CONDITIONS PERTAIN TO THE PROJECT THEREFORE AN AUTOVATIC SPRINKLER SYSTEMIS NOT REQUIRED.

SECTION 903.2.1.3 GROUP A-3 AN AUTOWATIC SPRINKLER SYSTEM SHALL BE PROMDED FOR GROUP A-3 OCCUPANCIES WHERE ONE OF THE FOLLOWING CONDITIONS EXISTS: 1. THE FIRE AREA EXCEEDS 12,000 SQUARE FEET (1115 M2); 2. THE FIRE AREA HAS AN OCCUPANT LOAD OF 300 OR MORE;

3. THE FIRE AREA IS LOCATED ON A FLOOR OTHER THAN A LEVEL OF EXIT DISCHARGE SERMING SUCH OCCUPANCIES.

SECTION 1016.1 EXIT ACCESS TRAVEL DISTANCE:

FOR NON-SPRINKLERED ASSEMBLY USE GROUP THE MAXIMUM EXIT ACCESS TRAVEL DISTANCE IS 200.

SYMBOL LEGEND

	1-HOUR RATED WALL PARTITION
KI/VOX	RECESSED KNOX BOX CABINET
FEC	SEMI-RECESSED FIRE EXTINGUISHER CABINET
	EGRESS PATH
XX-XCC	XOCC= AREA PER OCCUPANCY LOAD
XX" - XCCC	XX=CLEAR OPENING IN INCHES AND EGRESS CAPACITY
EATD X-X'	EXIT ACCESS TRAVEL DISTANCE, MAX. CONDITIONWORST CASE INDICATED

EXITSIGN


DIRECTION/LOCATION OF EGRESS

401	CORRIDOR
402	MENS
403	WOMENS
404	MEETING ROOM
405	COATS
406	STORAGE
407	CHILDREN AREA
408	CIRCULATION
409	ADULT AREA
410	TEEN AREA
411	WORK ROOM
412	OFFICE
413	STUDY
414	STUDY
415	CORRIDOR
416	STORAGE
417	JANITORS CLOSET
418	BREAK ROOM
419	MECH / ELEC
420	BOOK DROP

ROOM SCHEDULE

400 VESTIBULE

Number

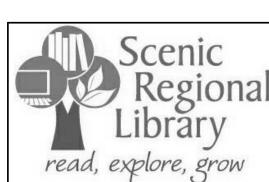



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ARCHITECT OF RECORD:

No. Date


JOHN EDWARD MUELLER MOAPOHTECTURAL LICENSE A2010039554 MO CERTIFICATE OF AUTHORITY A2014008380

Description

		•
	04/14/17	ISSUED FOR BID
DRAW	NBY: SC	/SH

PROJECT NUMBER: 16-1161.03

SHEET TITLE: LIFE SAFETY PLAN

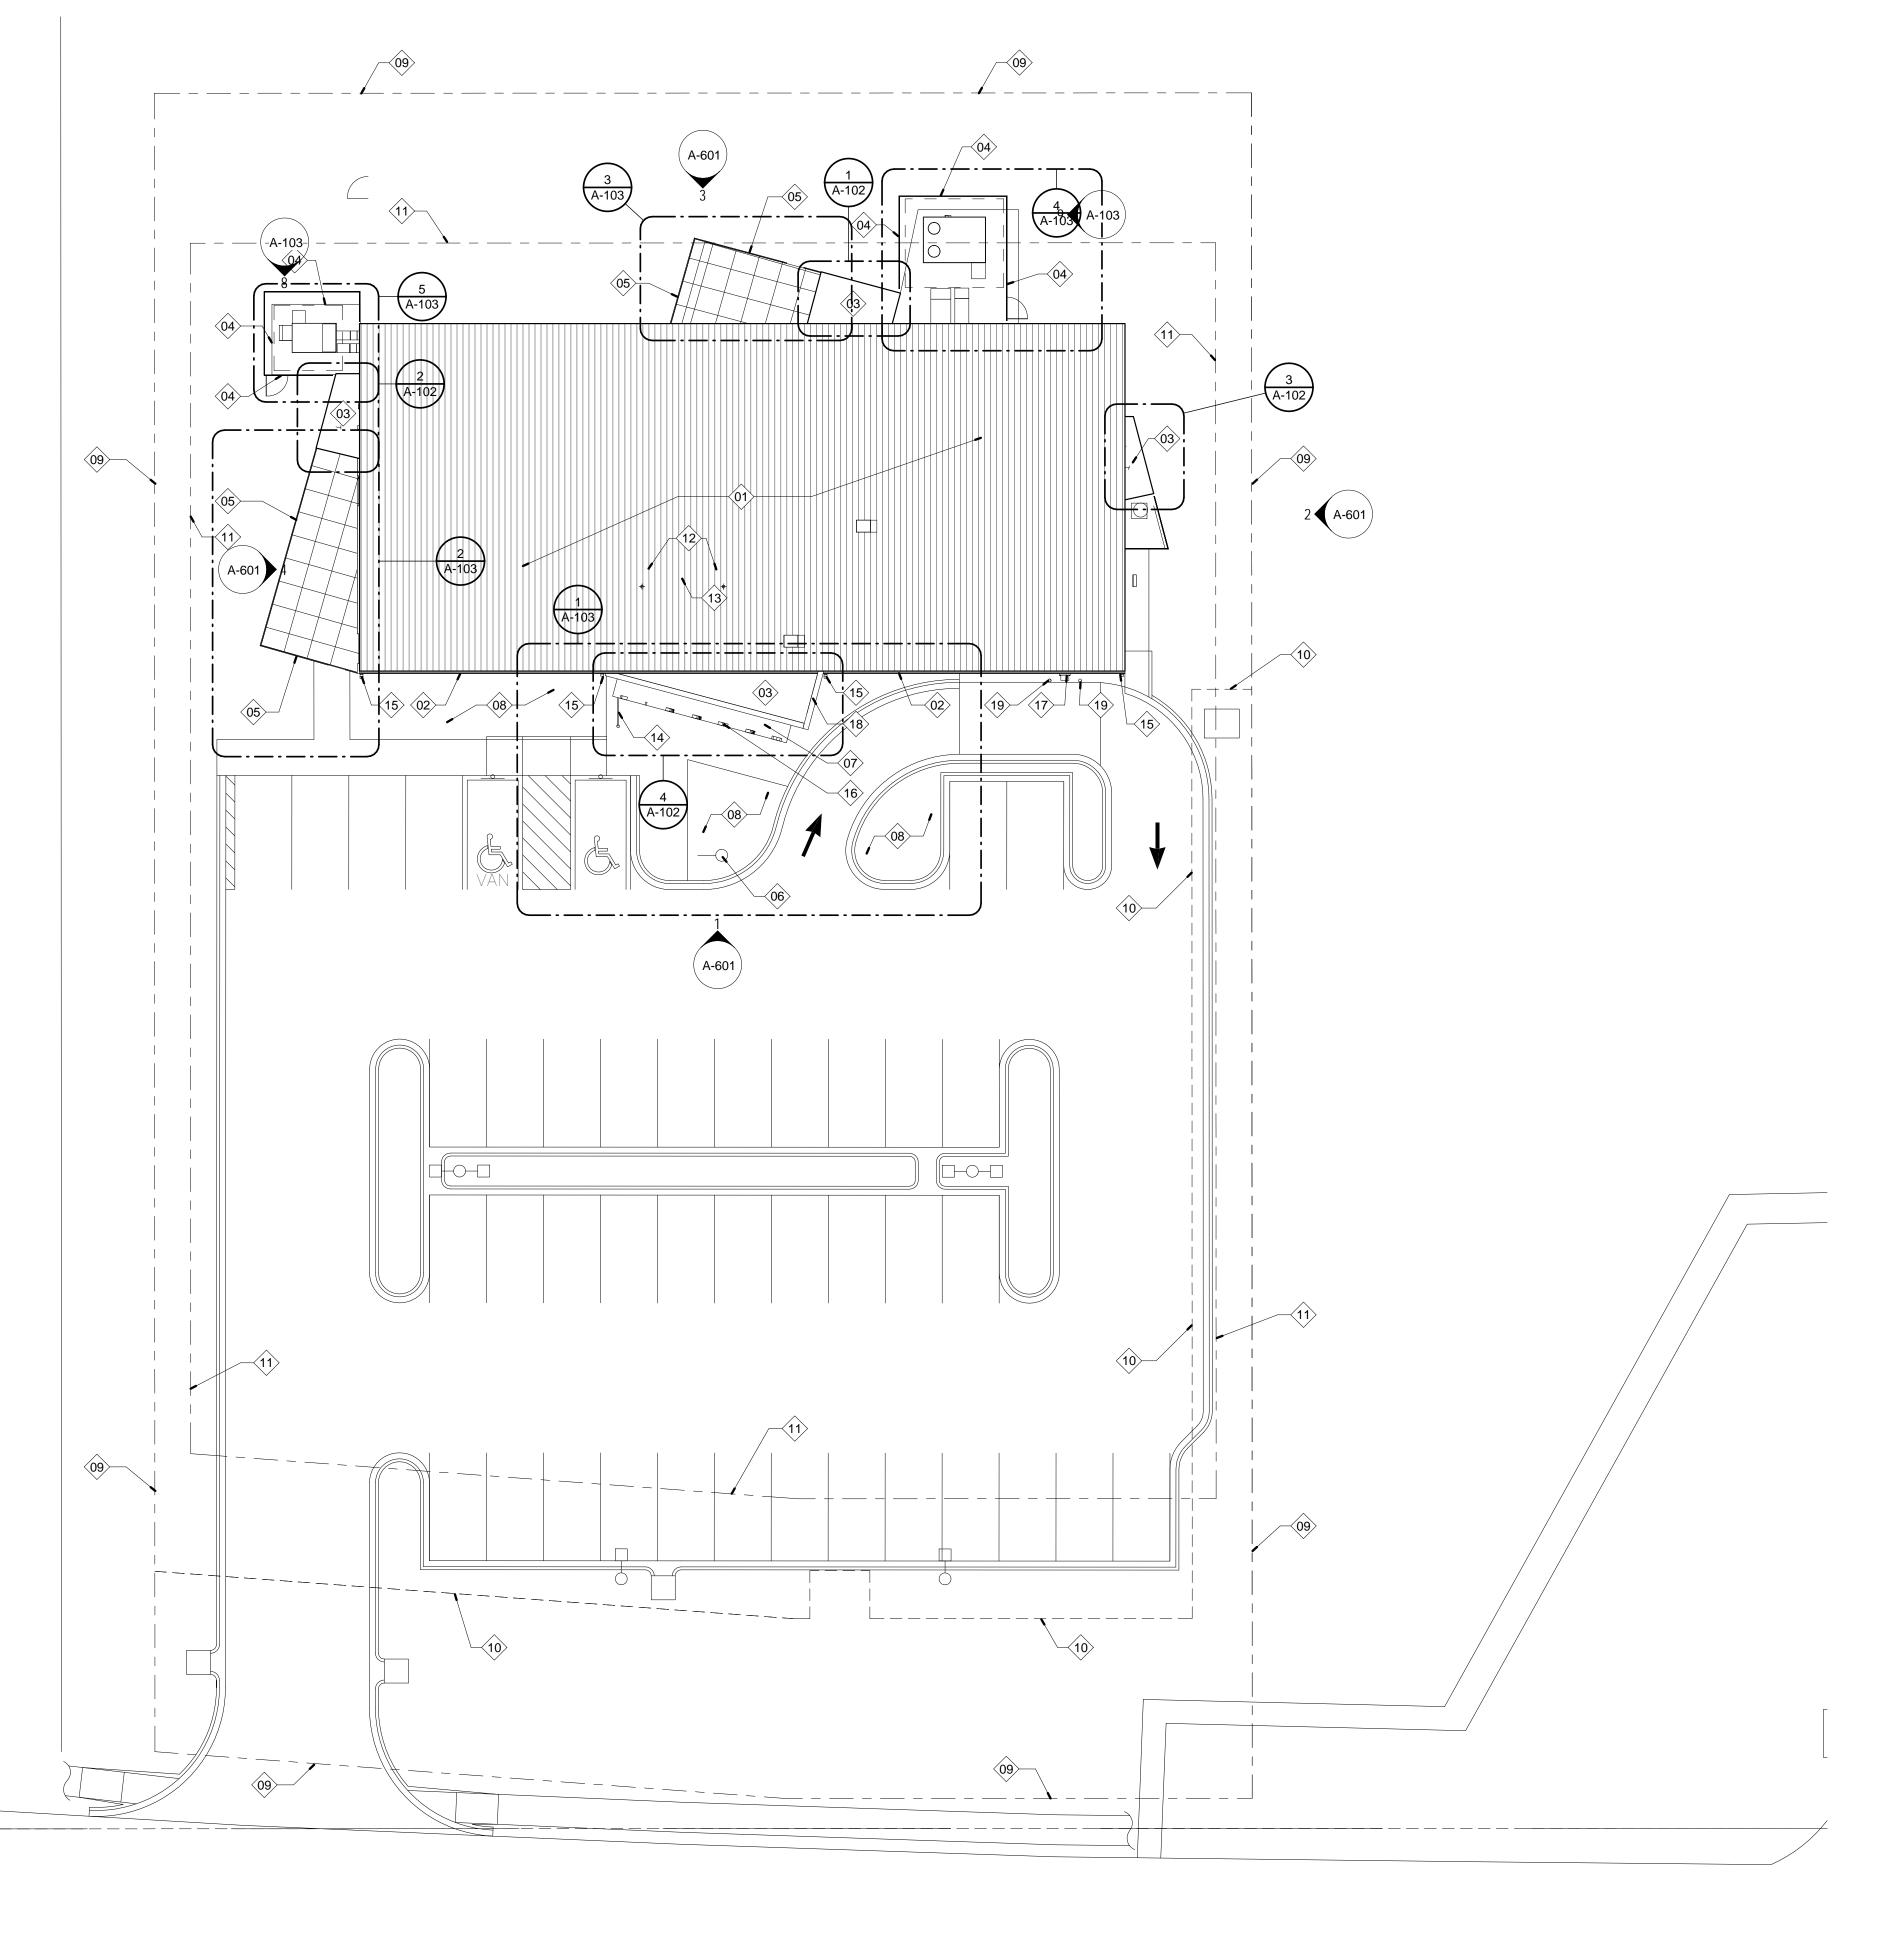

1 SITE PLAN - ARCHITECTURAL 1/16" = 1'-0"

	KEYED NOTES - SITE PLAN
Keynote Number	Description
01	STANDING SEAM MTL. ROOF SYSTEM, REFER TO SPECS.
02	PRE-FINISHED GUTTER, REFER TO SPECS.
03	ROOFING MEMBRANE, REFER TO SPECS.
04	MECHANICAL SCREEN FENCING - REFER TO SPECIFICATIONS AND DETAILS
05	PRE-FINISHED ALUM. FENCE - REFER TO SPECIFICATIONS
06	SINGLE FLAGPOLE, REFER TO SPECS.
07	PRE-FINISHED COMPOSITE METAL PANEL CANOPY, REFER TO SPECS.
08	PLANTING AREA, REFER TO LANDSCAPE PLAN.
09	PROPERTY LINE
10	EASEMENT
11	BUILDING SETBACK LINE
12	EXHAUST FAN PIPING PENETRATION, SEE ROOF DETAIL.
13	PLUMBING EXHAUST PIPING PENETRATION, SEE ROOF DETAIL.
14	SURFACE MOUNTED BIKE RACK, REFER TO SPECS.
15	DOWN SPOUT LOCATION - REFER TO CIVIL DWGS. FOR TIE-IN INFORMATION.
16	BUILDING SIGNAGE - REFER TO SPECS. FOR MORE INFORMATION
17	THROUGH WALL BOOK DROP UNIT, REFER TO SPECS.
18	WALL SCUPPER, COLLECTOR HEAD AND DOWN SPOUT, REFER TO ENLARGED ROOF PLAN FOR MORE INFORMATION.

TRAFFIC BOLLARD, REFER TO CIVIL DRAWINGS.



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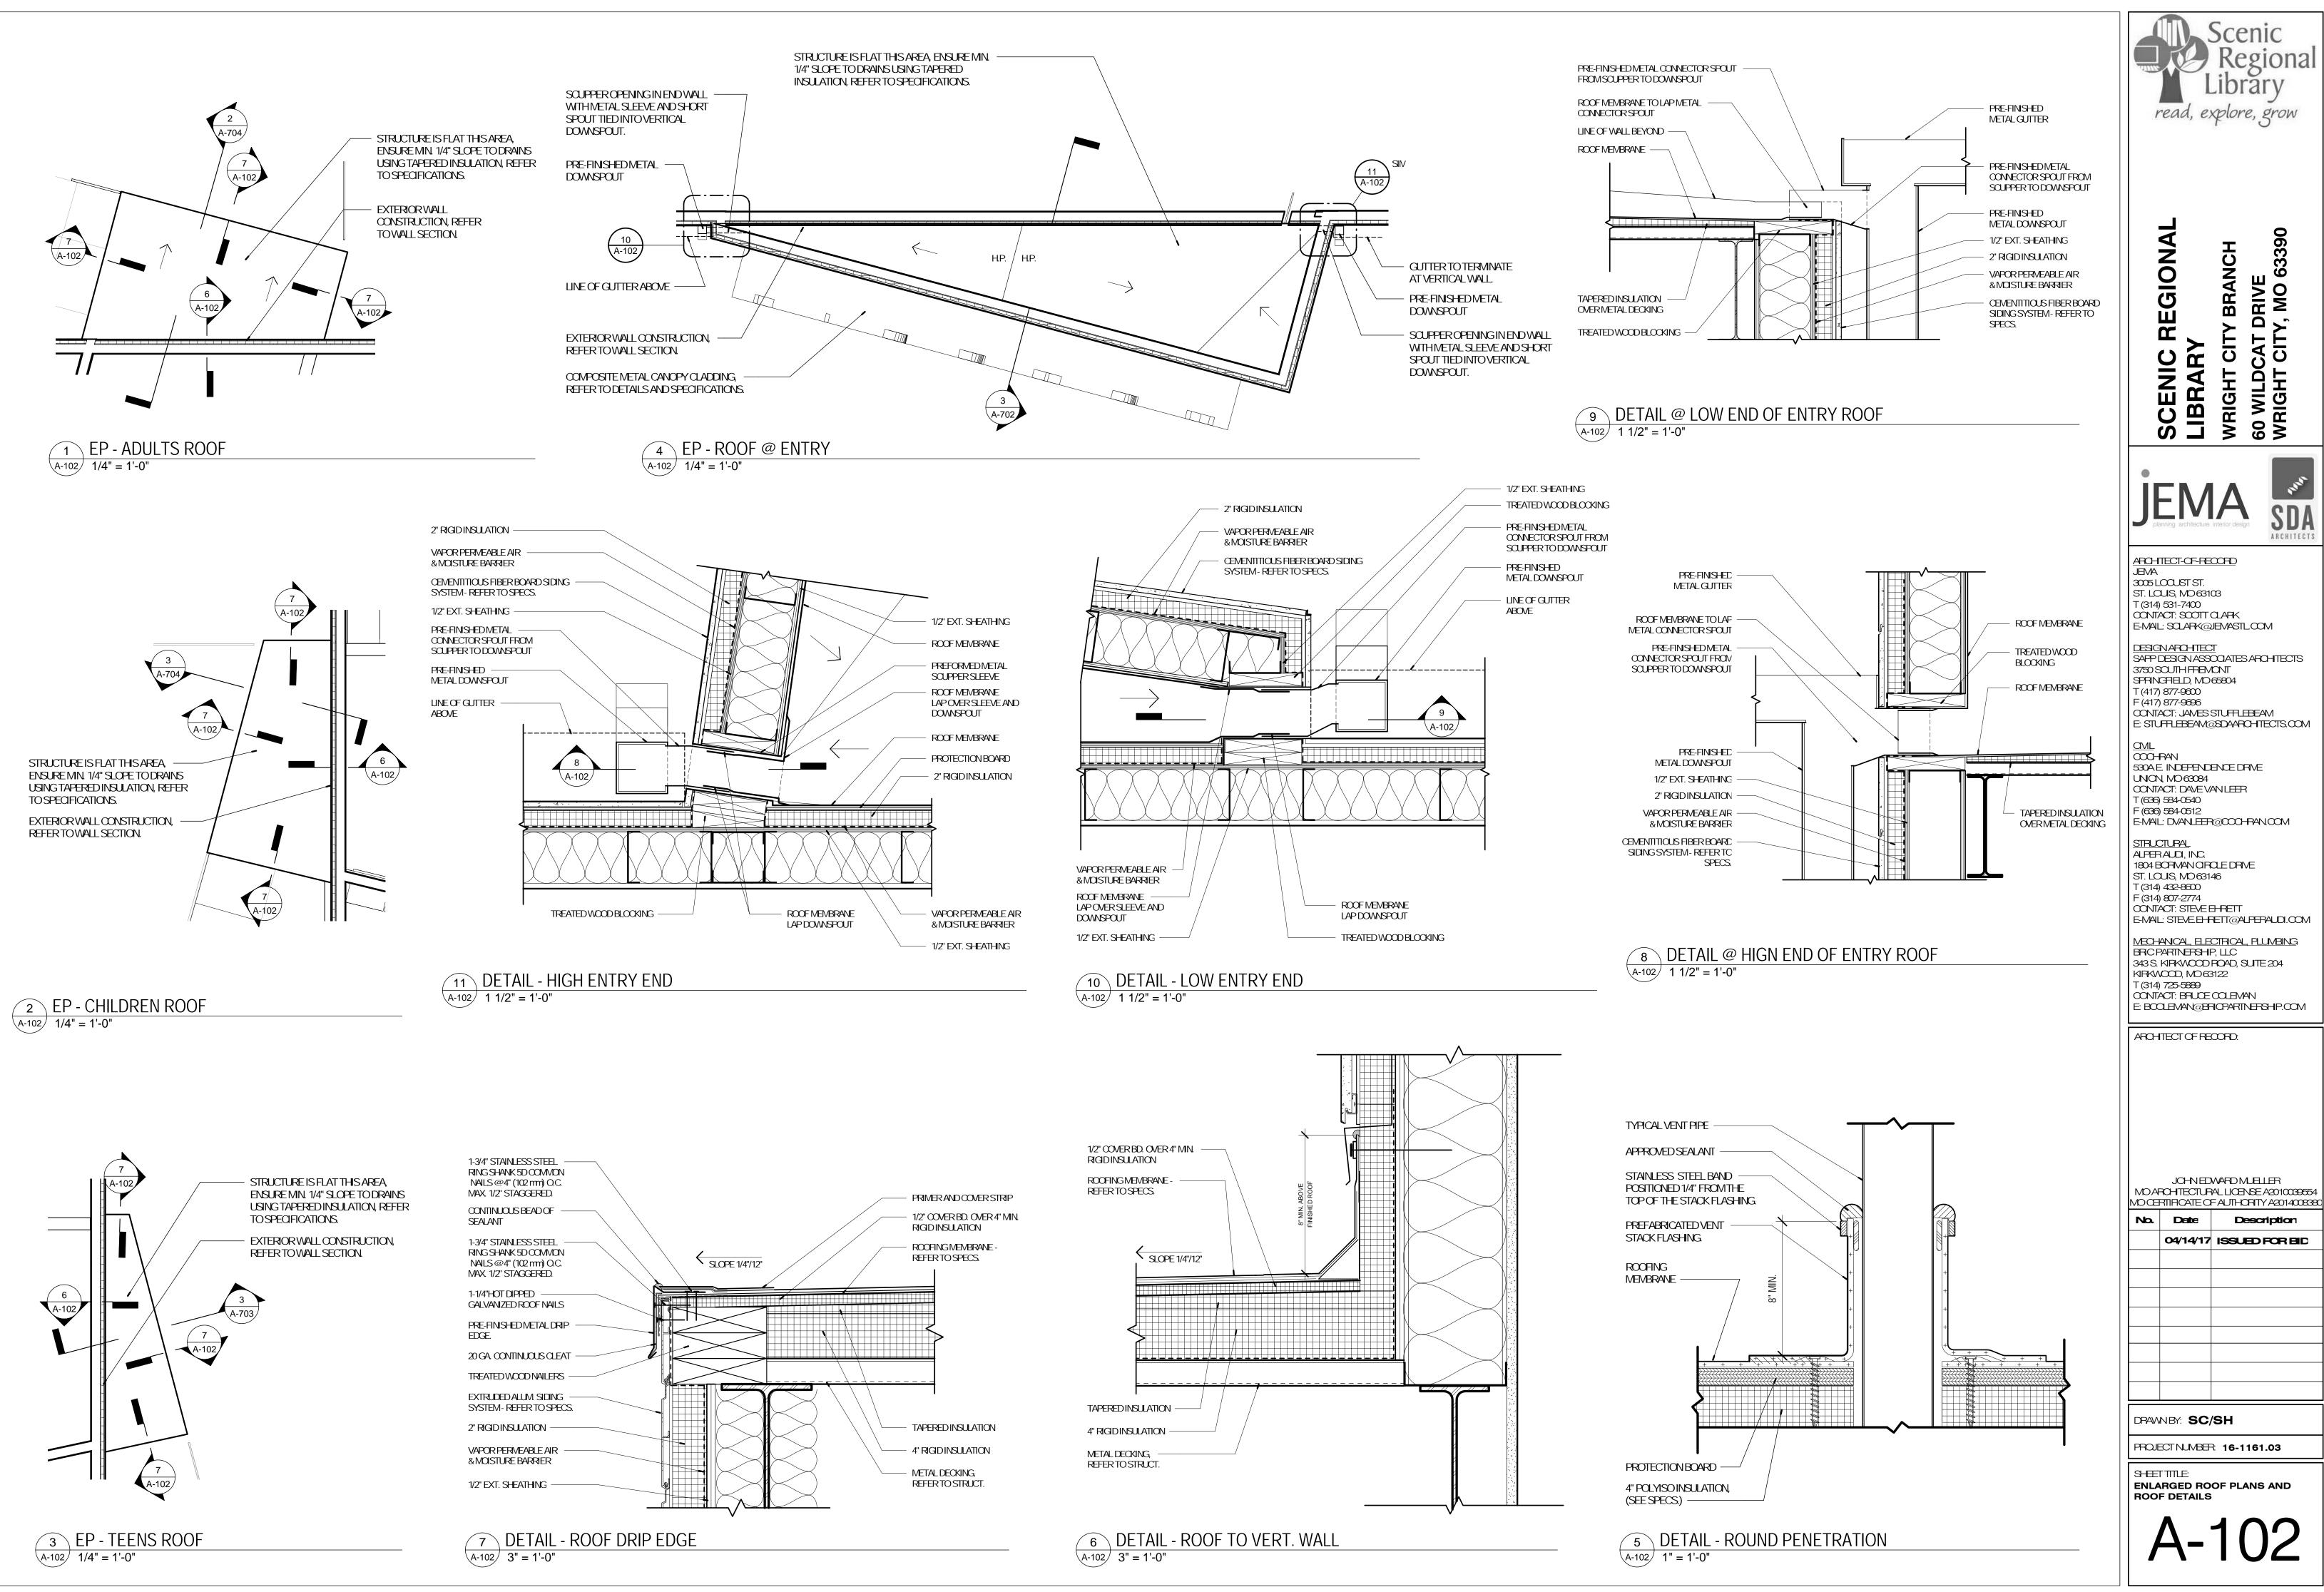
JOHNEDWARD MUELLER
MO ARCHTECTURAL LICENSE A2010039554
MO CERTIRCATE OF AUTHORITY A2014008380

No.	Date	Description
	04/14/17	ISSUED FOR BID

DRAWNBY: SC/SH

PROJECT NUMBER: 16-1161.03

SHEET TITLE:
ARCHITECTURAL SITE PLAN



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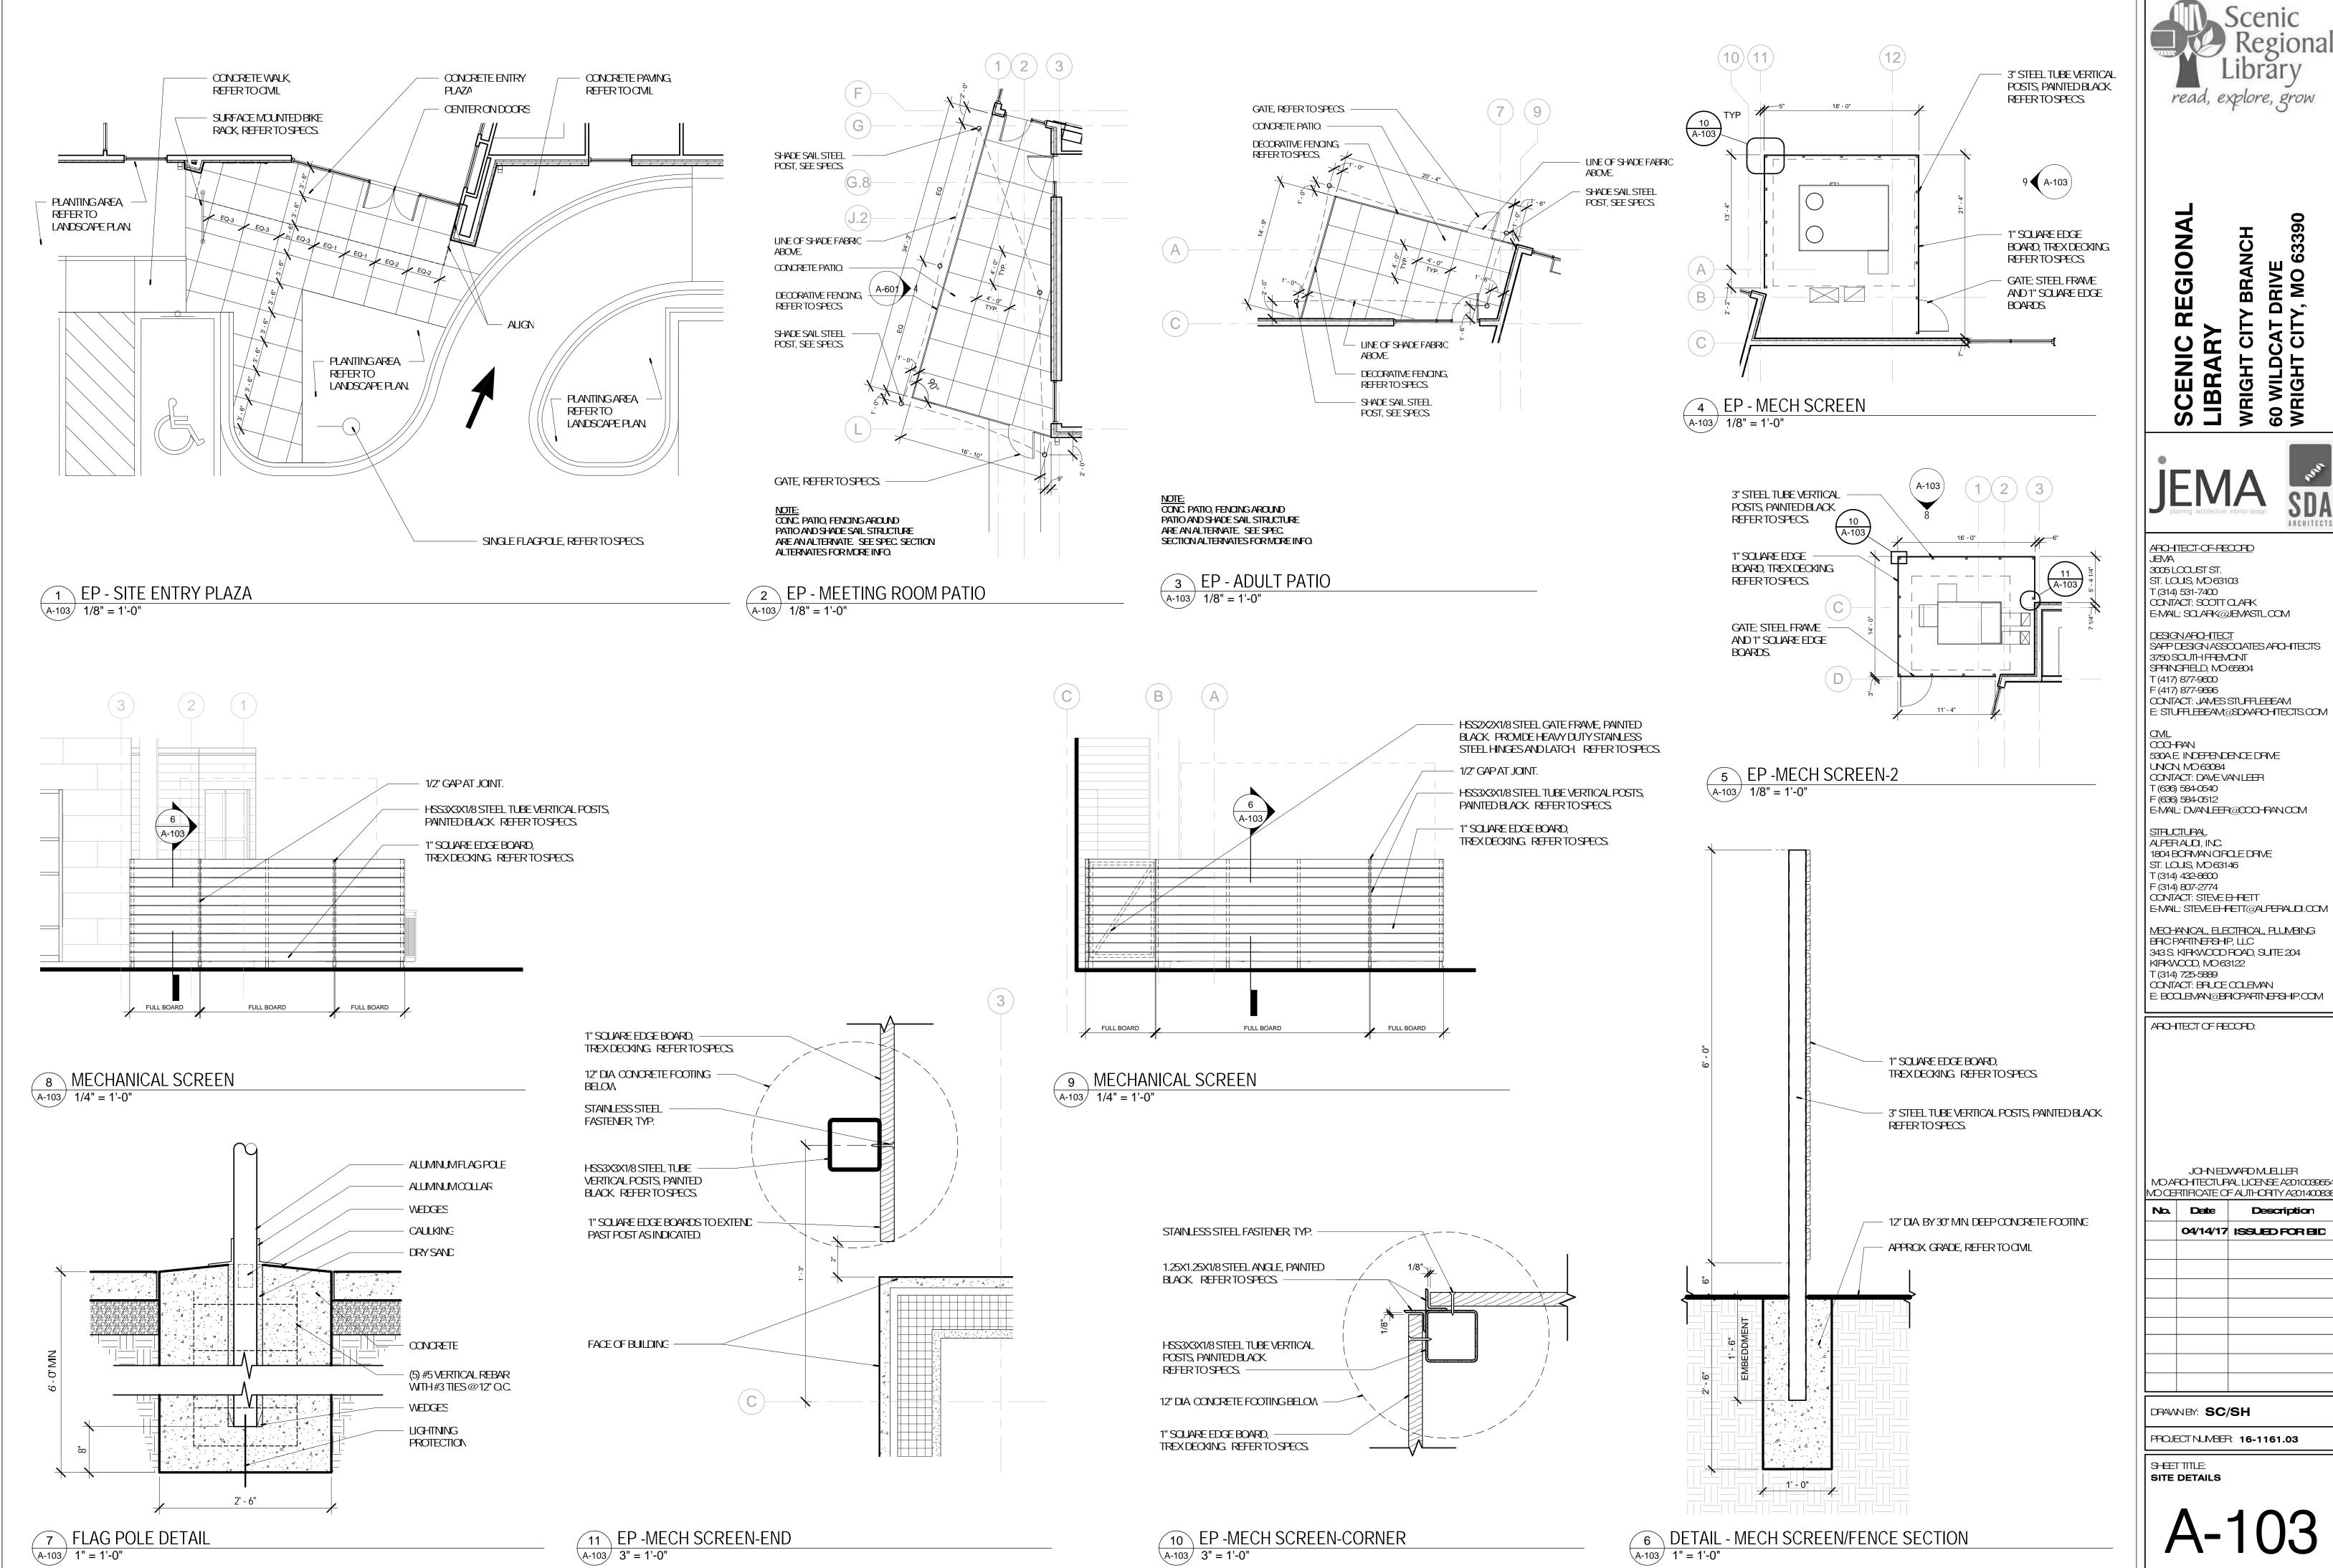
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No. Date Description 04/14/17 ISSUED FOR BID

DRAWNBY: SC/SH

PROJECT NUMBER: 16-1161.03 SHEET TITLE:



read, explore, grow

63390

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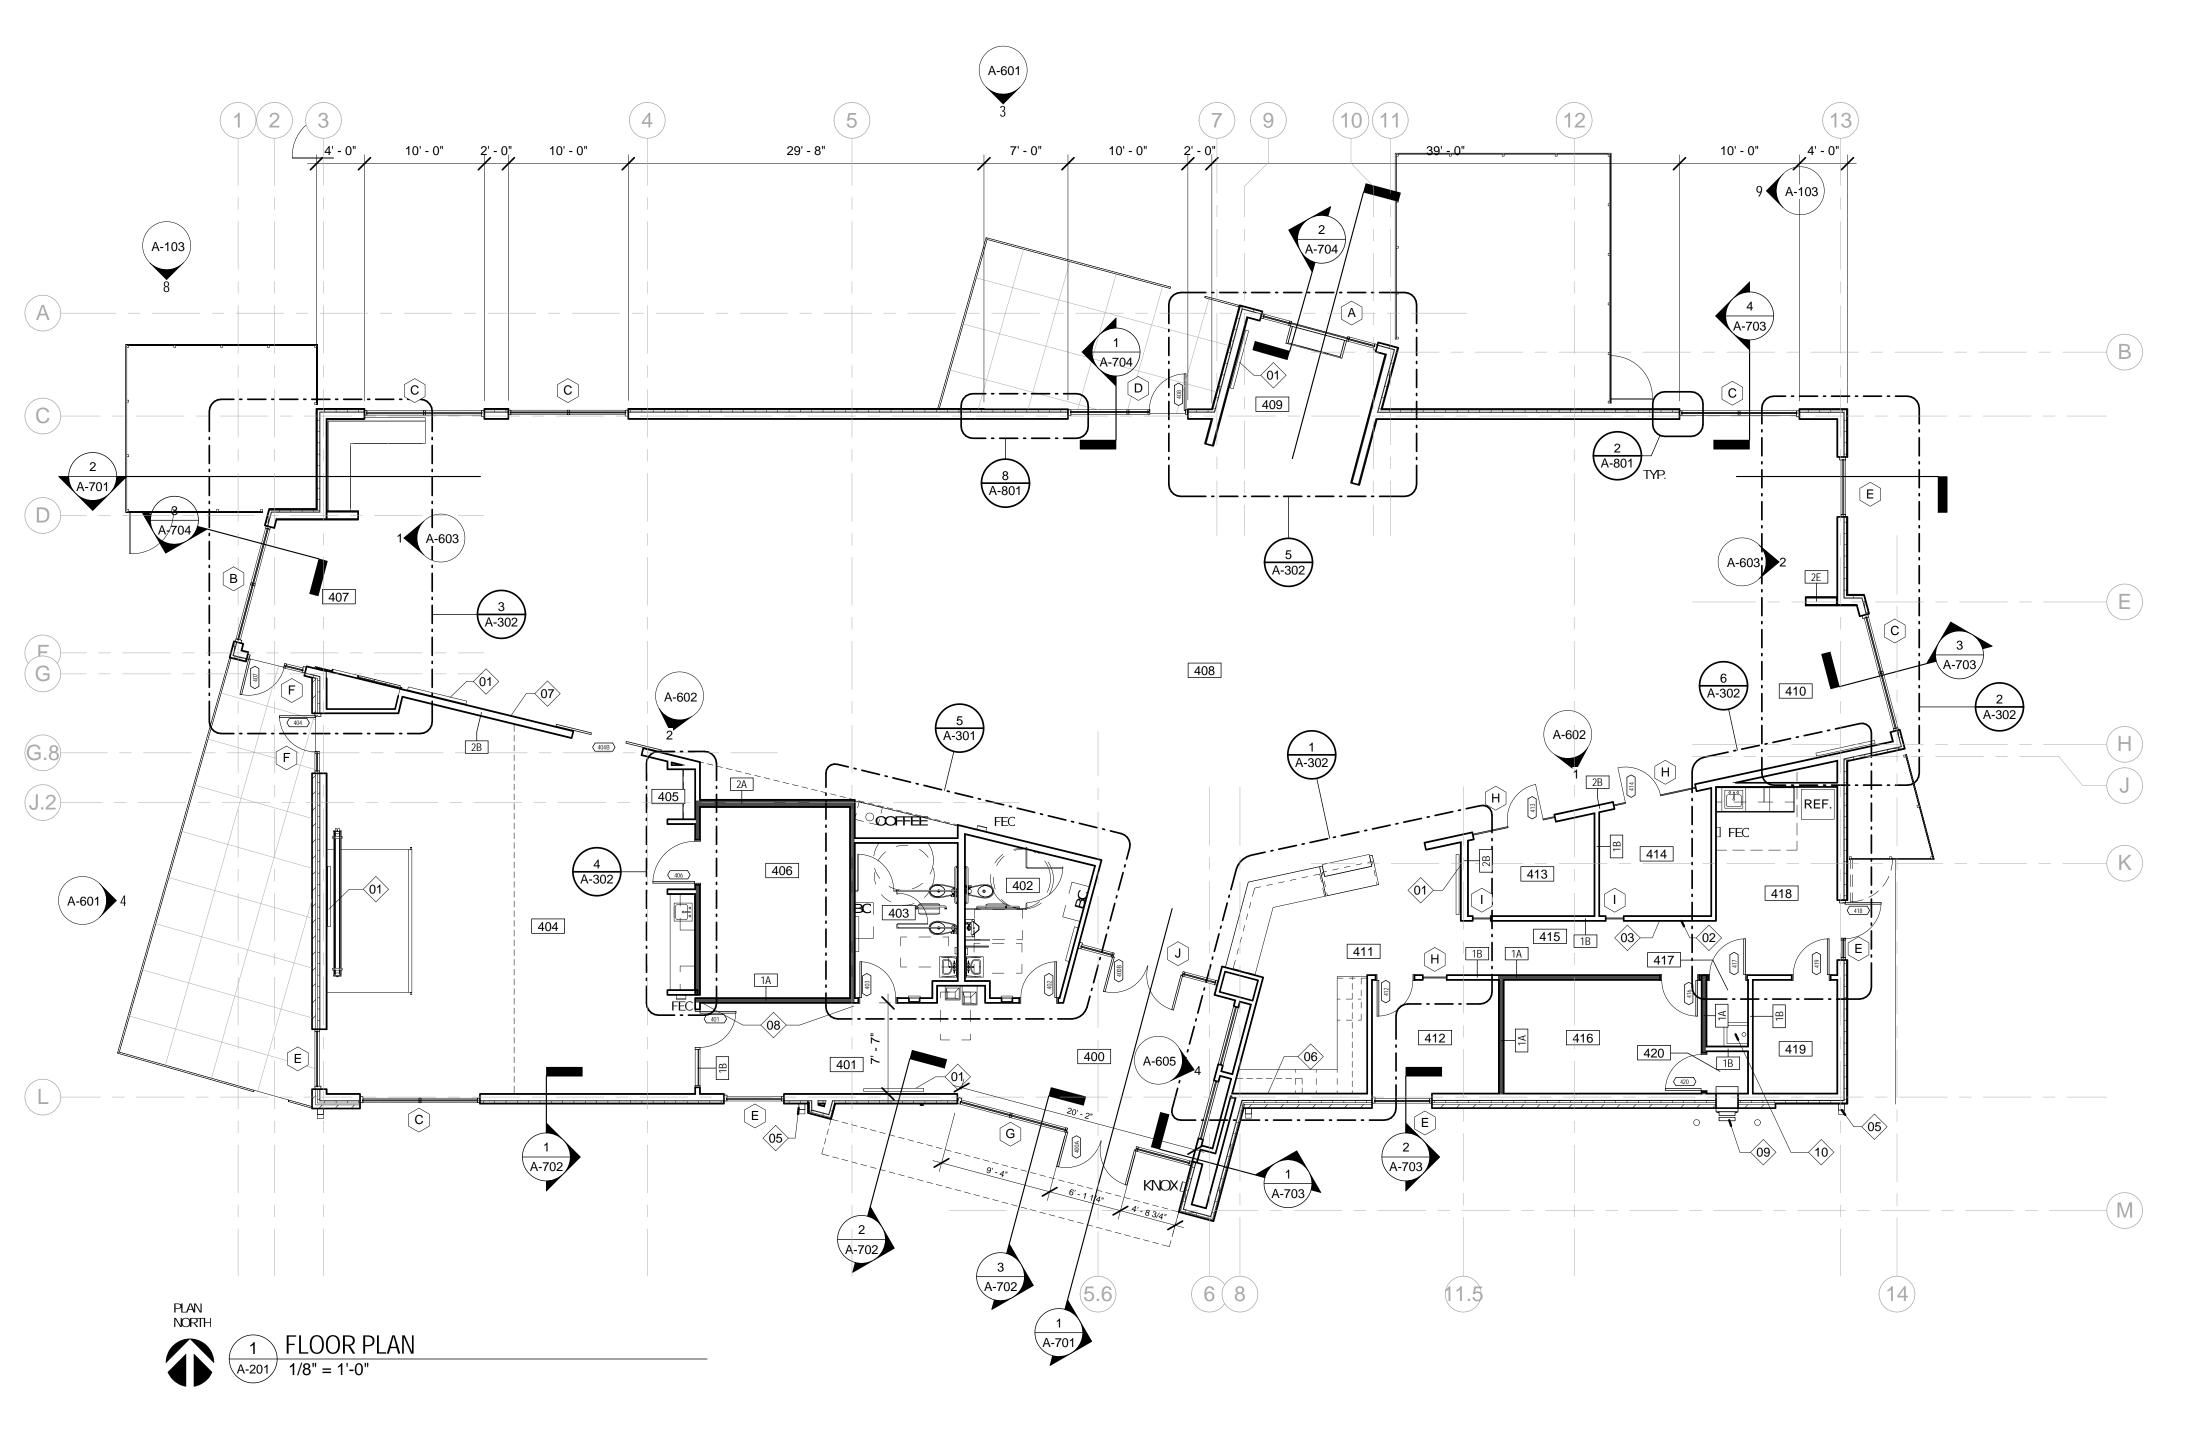
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04/14/17 ISSUED FOR BID



GENERAL NOTES - FLOOR PLAN

1. REFER TO SHEET A-001 FOR FLOOR PLAN GENERAL NOTES

	KEYED NOTES - FLOOR PLAN
Keynote	
Number	Description
01	PROVIDE BLOCKING IN WALL FOR WALL-MOUNTED DISPLAY
02	PROVIDE BLOCKING IN WALL FOR COAT HOOKS
03	PROVIDE BLOCKING IN WALL FOR LOCKERS
05	DOWN SPOUT LOCATION - REFER TO ARCHITECTURAL SITE PLAN AND CIVIL DWGS.
06	PROVIDE BLOCKING IN WALL FOR WALL-HUNG SHELVING
07	PROVIDE BLOCKING IN WALL FOR BULLETIN BOARD, C.F.C.I.
08	PROVIDE BLOCKING IN WALL FOR DONOR WALL, O.F.O.I.
09	IN-WALL BOOK DROP UNIT, REFER TO DETAILS AND SPECIFICATIONS.
10	JANITOR'S MOP SINK, REFER TO PLUMBING DRAWINGS AND SPECIFICATIONS.
	1



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ARCHITECT OF RECORD:

JOHNEDWARD MUELLER
MO ARCHITECTURAL LICENSE A2010039554
MO CERTIRICATE OF AUTHORITY A2014008380

	No.	Date	Description
ROOM SCHEDULE		04/14/17	ISSUED FOR BID
Name			
,			
VESTIBULE			
CORRIDOR			
MENS			
WOMENS			
MEETING ROOM			
COATS			
STORAGE			
CHILDREN AREA			
CIRCULATION			
ADULT AREA	DRAW	NBY: SC	/SH
TEEN AREA			


PROJECT NUMBER 16-1161.03

SHEETTITLE: FLOOR PLAN - FIRST FLOOR

A-201


ROOM SCHEDULE		
Number	Name	
400	VESTIBULE	
401	CORRIDOR	
402	MENS	
403	WOMENS	
404	MEETING ROOM	
405	COATS	
406	STORAGE	
407	CHILDREN AREA	
408	CIRCULATION	
409	ADULT AREA	
410	TEEN AREA	
411	WORK ROOM	
412	OFFICE	
413	STUDY	
414	STUDY	
415	CORRIDOR	
416	STORAGE	
417	JANITORS CLOSET	
418	BREAK ROOM	
419	MECH / ELEC	

420 BOOK DROP

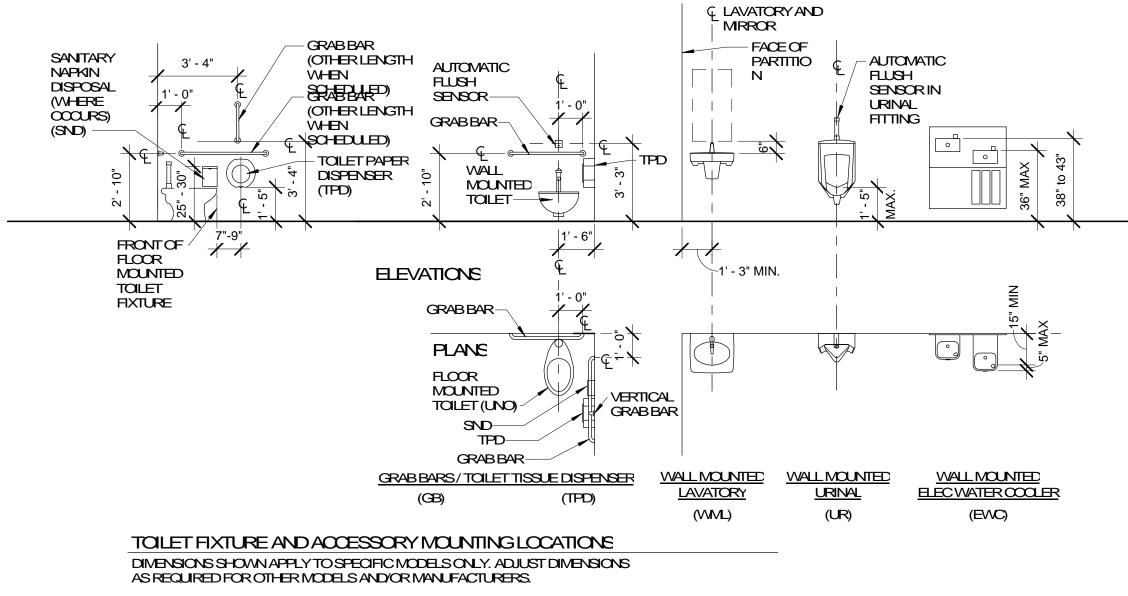

MOUNTING LOCATIONS - PLUMBING FIXTURES

1/4" = 1'-0"

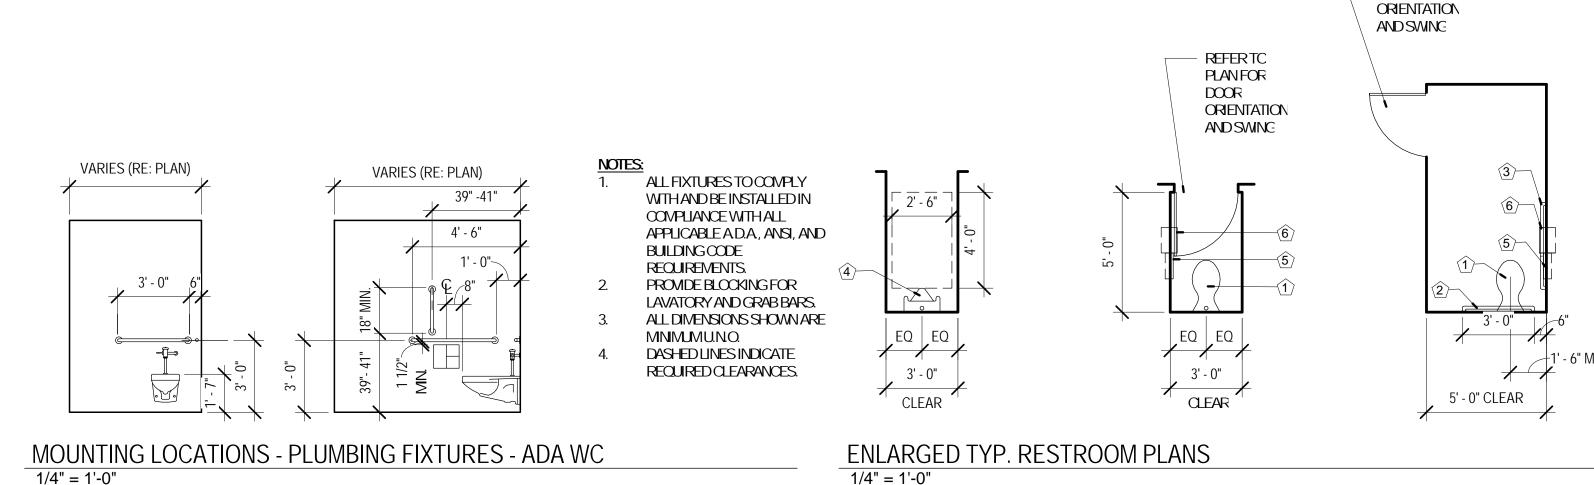

1/4" = 1'-0"

PLUMBING FIXTURES AND ACCESSORIES LEGEND.

ALL FIXTURES, ACCESSORIES, AND INSTALLATIONS TO BE ACCESSIBLE AND IN FULL COMPLIANCE WITH ICC/ANSI 117.1. NUMBERS IN BRACKETS REFER TO ICC/ANSI 117.1 SECTION.


1 FLOOR-MOUNTED TOILET: SEE PLUMBING SPECS.

J.2


- 2 GRAB BAR: BOBRICK #E-5806 X 36 HORIZONTAL GRAB BAR WITH CONCEALED MOUNTING, SATIN FINISH STAINLESS STEEL-PROMDE NECESSARY BLOCKING IN WALL FOR MOUNTING
- GRAB BAR: BOBRICK #E-5806 X 42 HORIZONTAL GRAB BAR WITH CONCEALED MOUNTING, SATIN FINISH STAINLESS STEEL
- (4) **GRAB BAR:** 18" GRAB BAR BOBRICK MODEL #B6086 VERTICAL GRAB BAR WITH CONCEALED MOUNTING, SATIN FINISH STAINLESS STEEL
- TOLET TISSUE DISPENSER: BOBRICK #E-2888 CLASSIC SERIES MULTI-ROLL TOILET TISSUE DISPENSER, SURFACE-MOUNTED
- **CHANGING STATION:** KOALA KARE PRODUCTS#KB-200, SURFACE-MOUNTED SERIES - PROMDE NECESSARY BLOCKING IN WALL FOR MOUNTING

- RECESSED AUTOMATIC HAND DRYER: BOBRICK #B-3725, TRIMLINE SERIES, SEM-RECESSED, SATINFINISH STAINLESS STEEL -PROMDE NECESSARY BLOCKING IN WALL FOR MOUNTING
- WALL-MOUNTED LAVATORY: SEE PLUMBING SPECS.
- DRINKING FOUNTAIN: BI-LEVEL ADA COVPLIANT, SEE PLUMBING SPECS.
- 10 SOAP DISPENSER: BOBRICK #E-2111 CLASSIC SERIES SURFACE-MOUNTED, SATIN-FINISH STAINLESS STEEL - PROMDE NECESSARY BLOCKING IN WALL FOR MOUNTING
- (1) SANITARY DISPOSAL: BOBRICK #E-354 CLASSIC SERIES PARTITION-MOUNTED DUAL SIDED, SATINFINISH STAINLESS STEEL (WOMEN'S RESTROOMS ONLY)
- 12 MRROR: BOBRICK #E-165-2448, SERIES CHANNEL-FRAVED MIRROR 24"X48"
- 13 WALL-MOUNTED URINAL: SEE PLUMBING SPECS.

- 14 TOLET PARTITION: SEE SPECIFICATIONS
- (15) URINAL SCREEN: SEE SPECIFICATIONS
- 16 UTILITY SHELF W/BROOMHOLDER: BOBRICK #E-224 UTILITY SHELF WITH MOP/BROOM HOLDERS AND RAG HOOKS
- (17) COAT HOOKS: BOBRICK #E-2116 HEAVY-DUTY CLOTHES HOOK WITH CONCEALED MOUNTING.

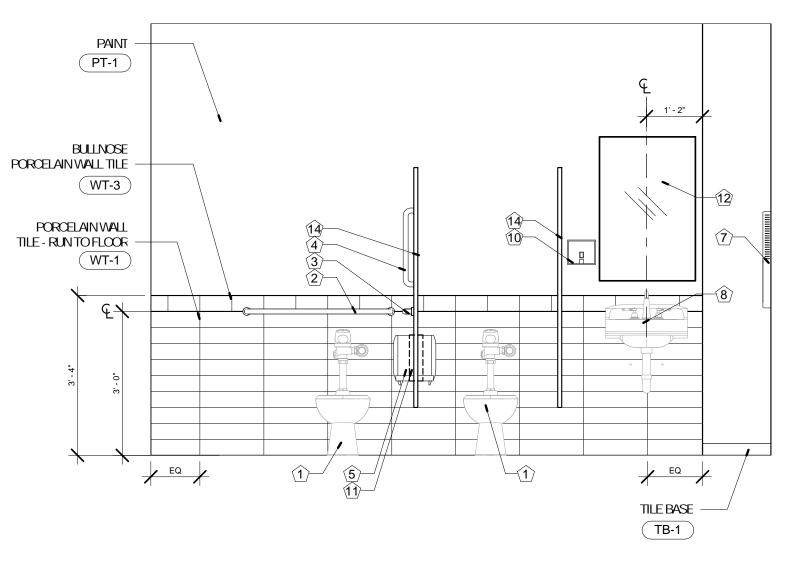

7 ELEVATION @ WOMENS RESTROOM A-301 1/2" = 1'-0"

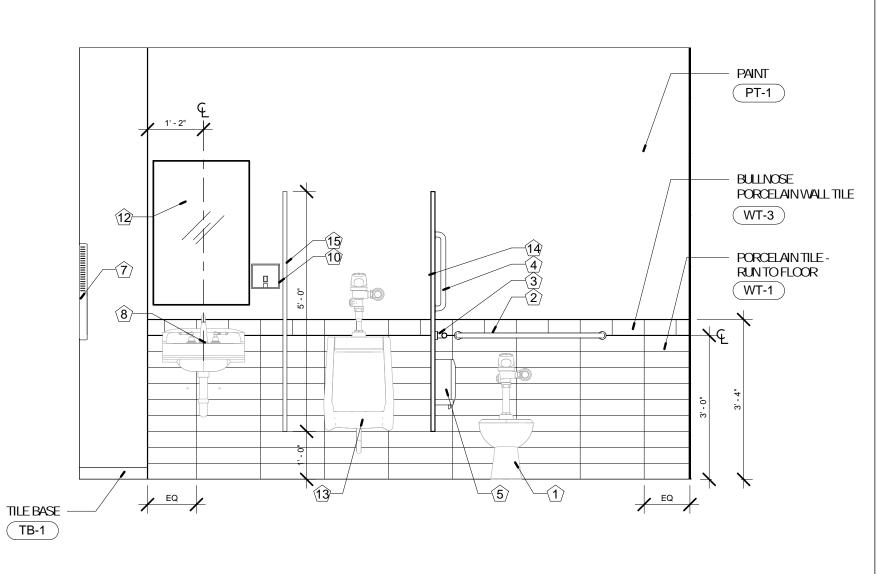

6 ELEVATION @ MENS RESTROOM A-301 1/2" = 1'-0"

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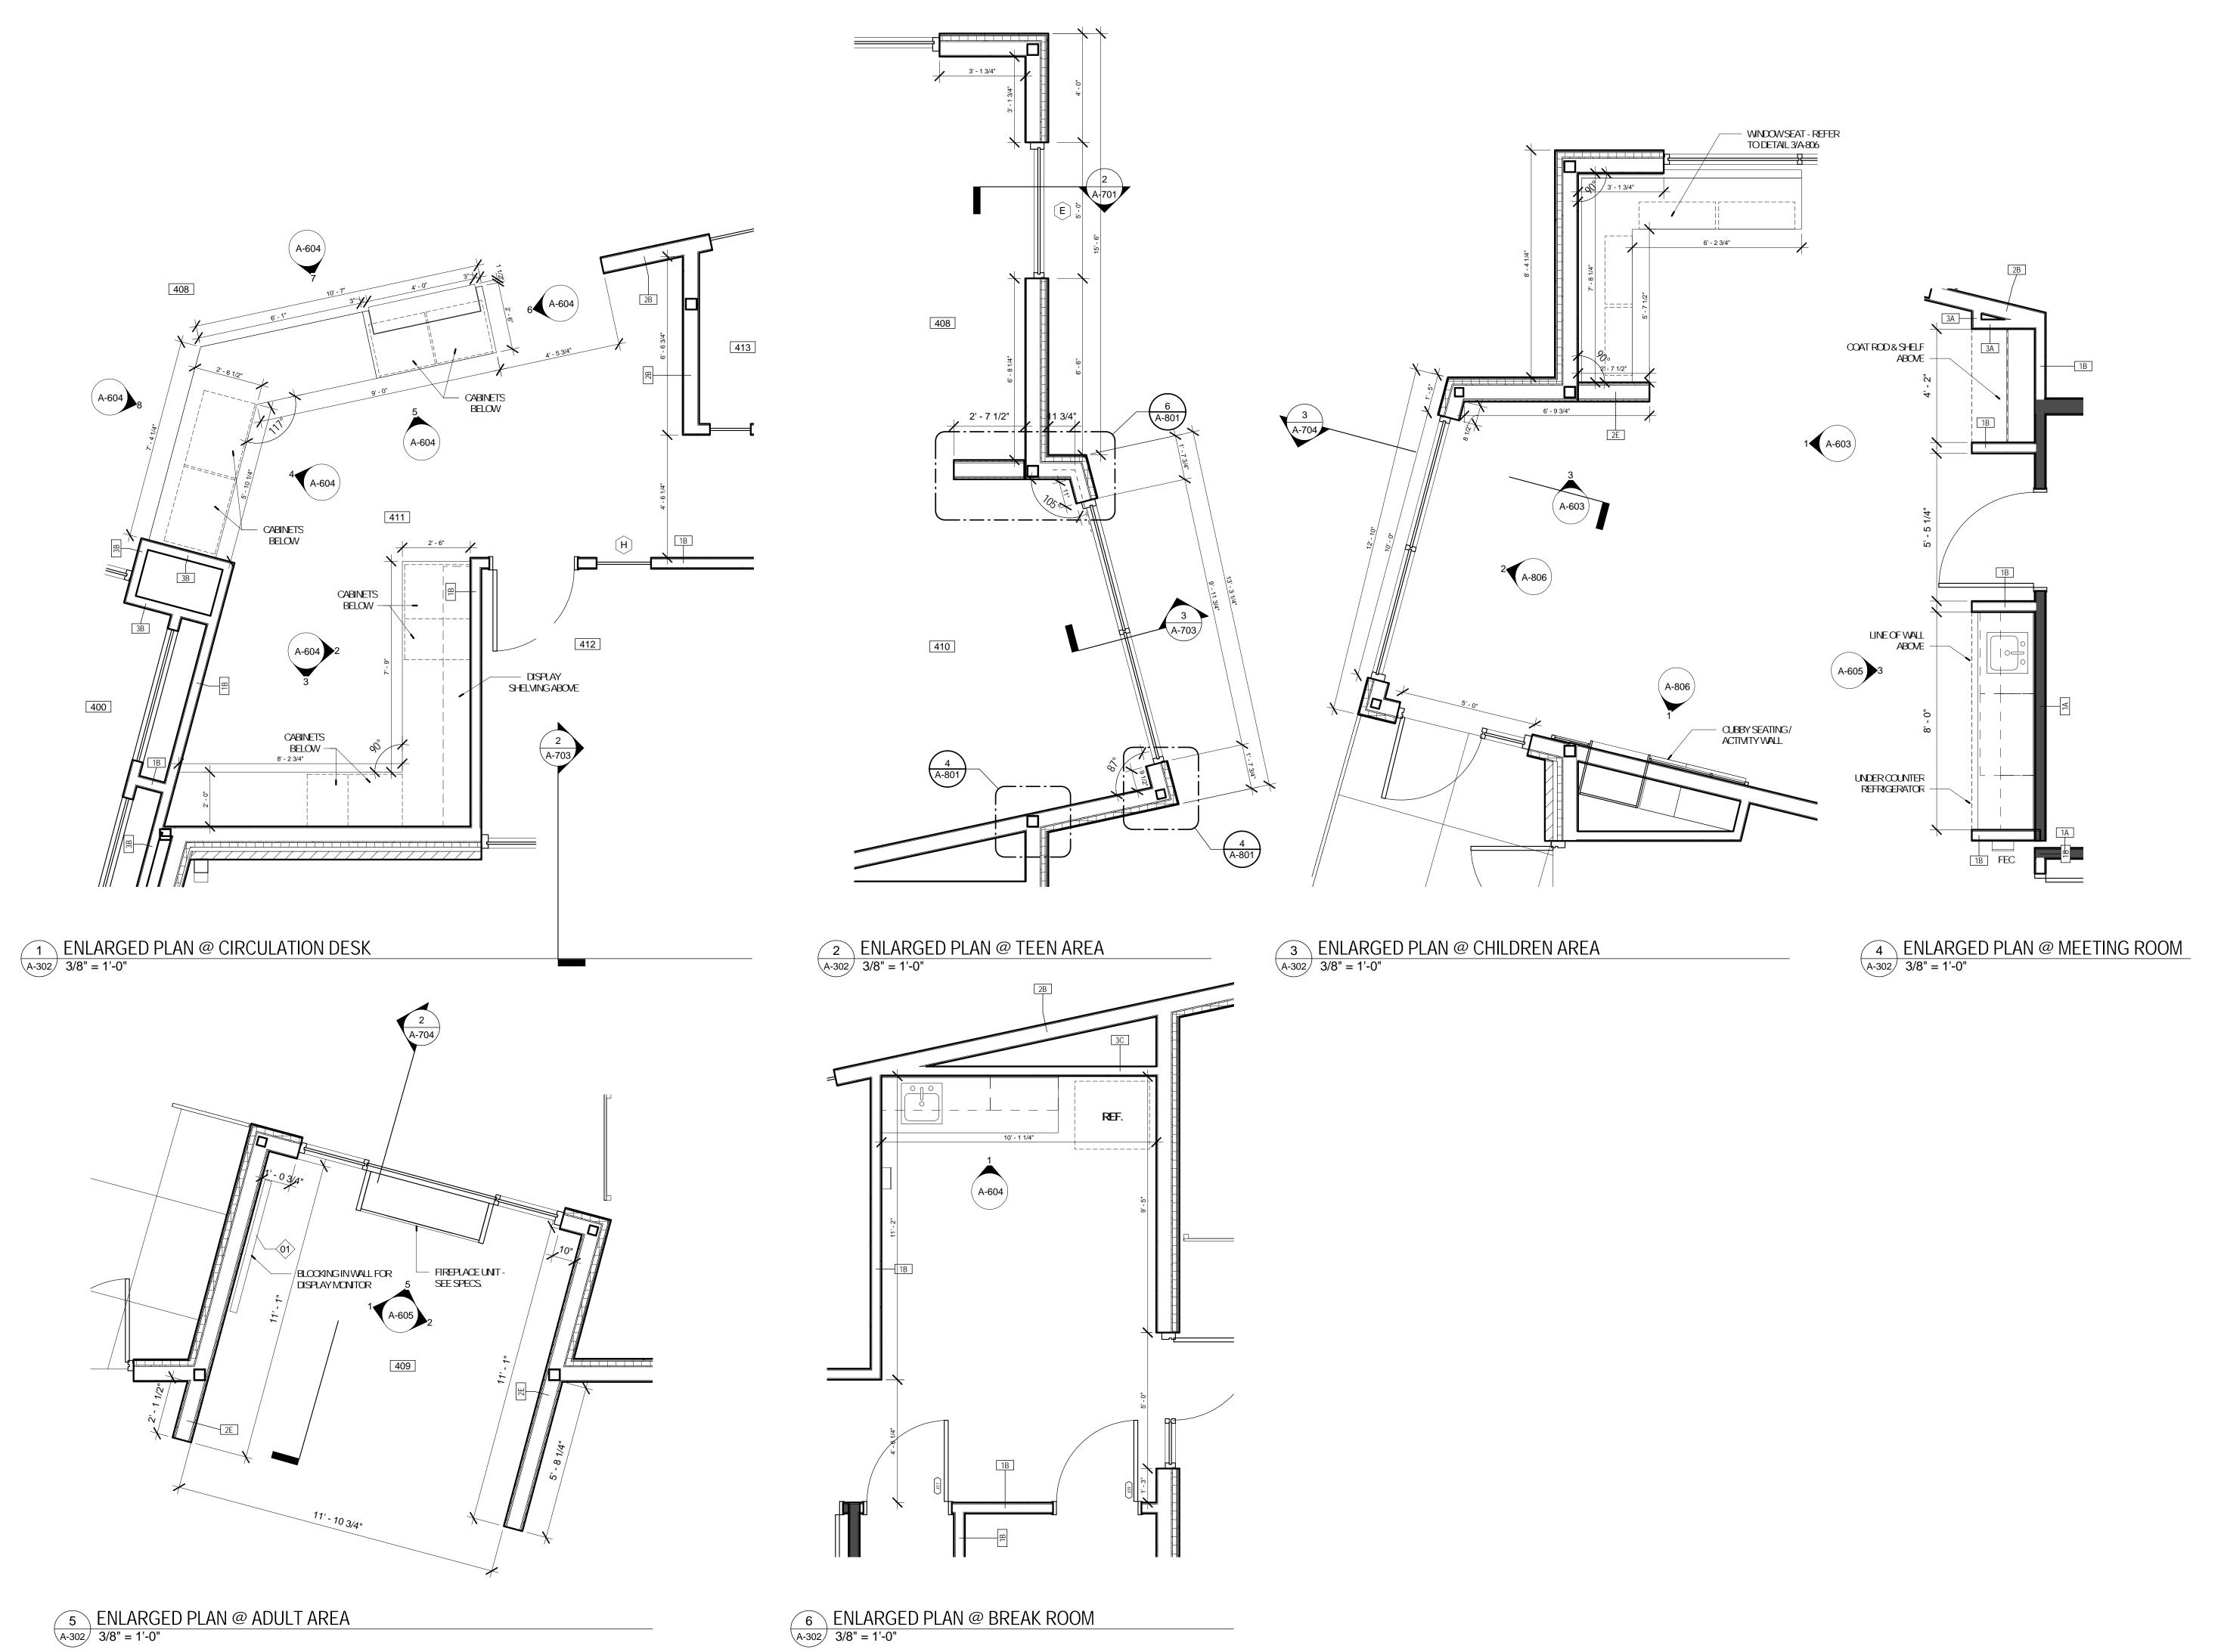
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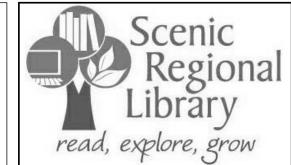
No.	Date	Description
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DRAWNBY: SC/SH

PROJECT NUMBER: 16-1161.03

SHEET TITLE: **ENLARGED FLOOR PLANS**





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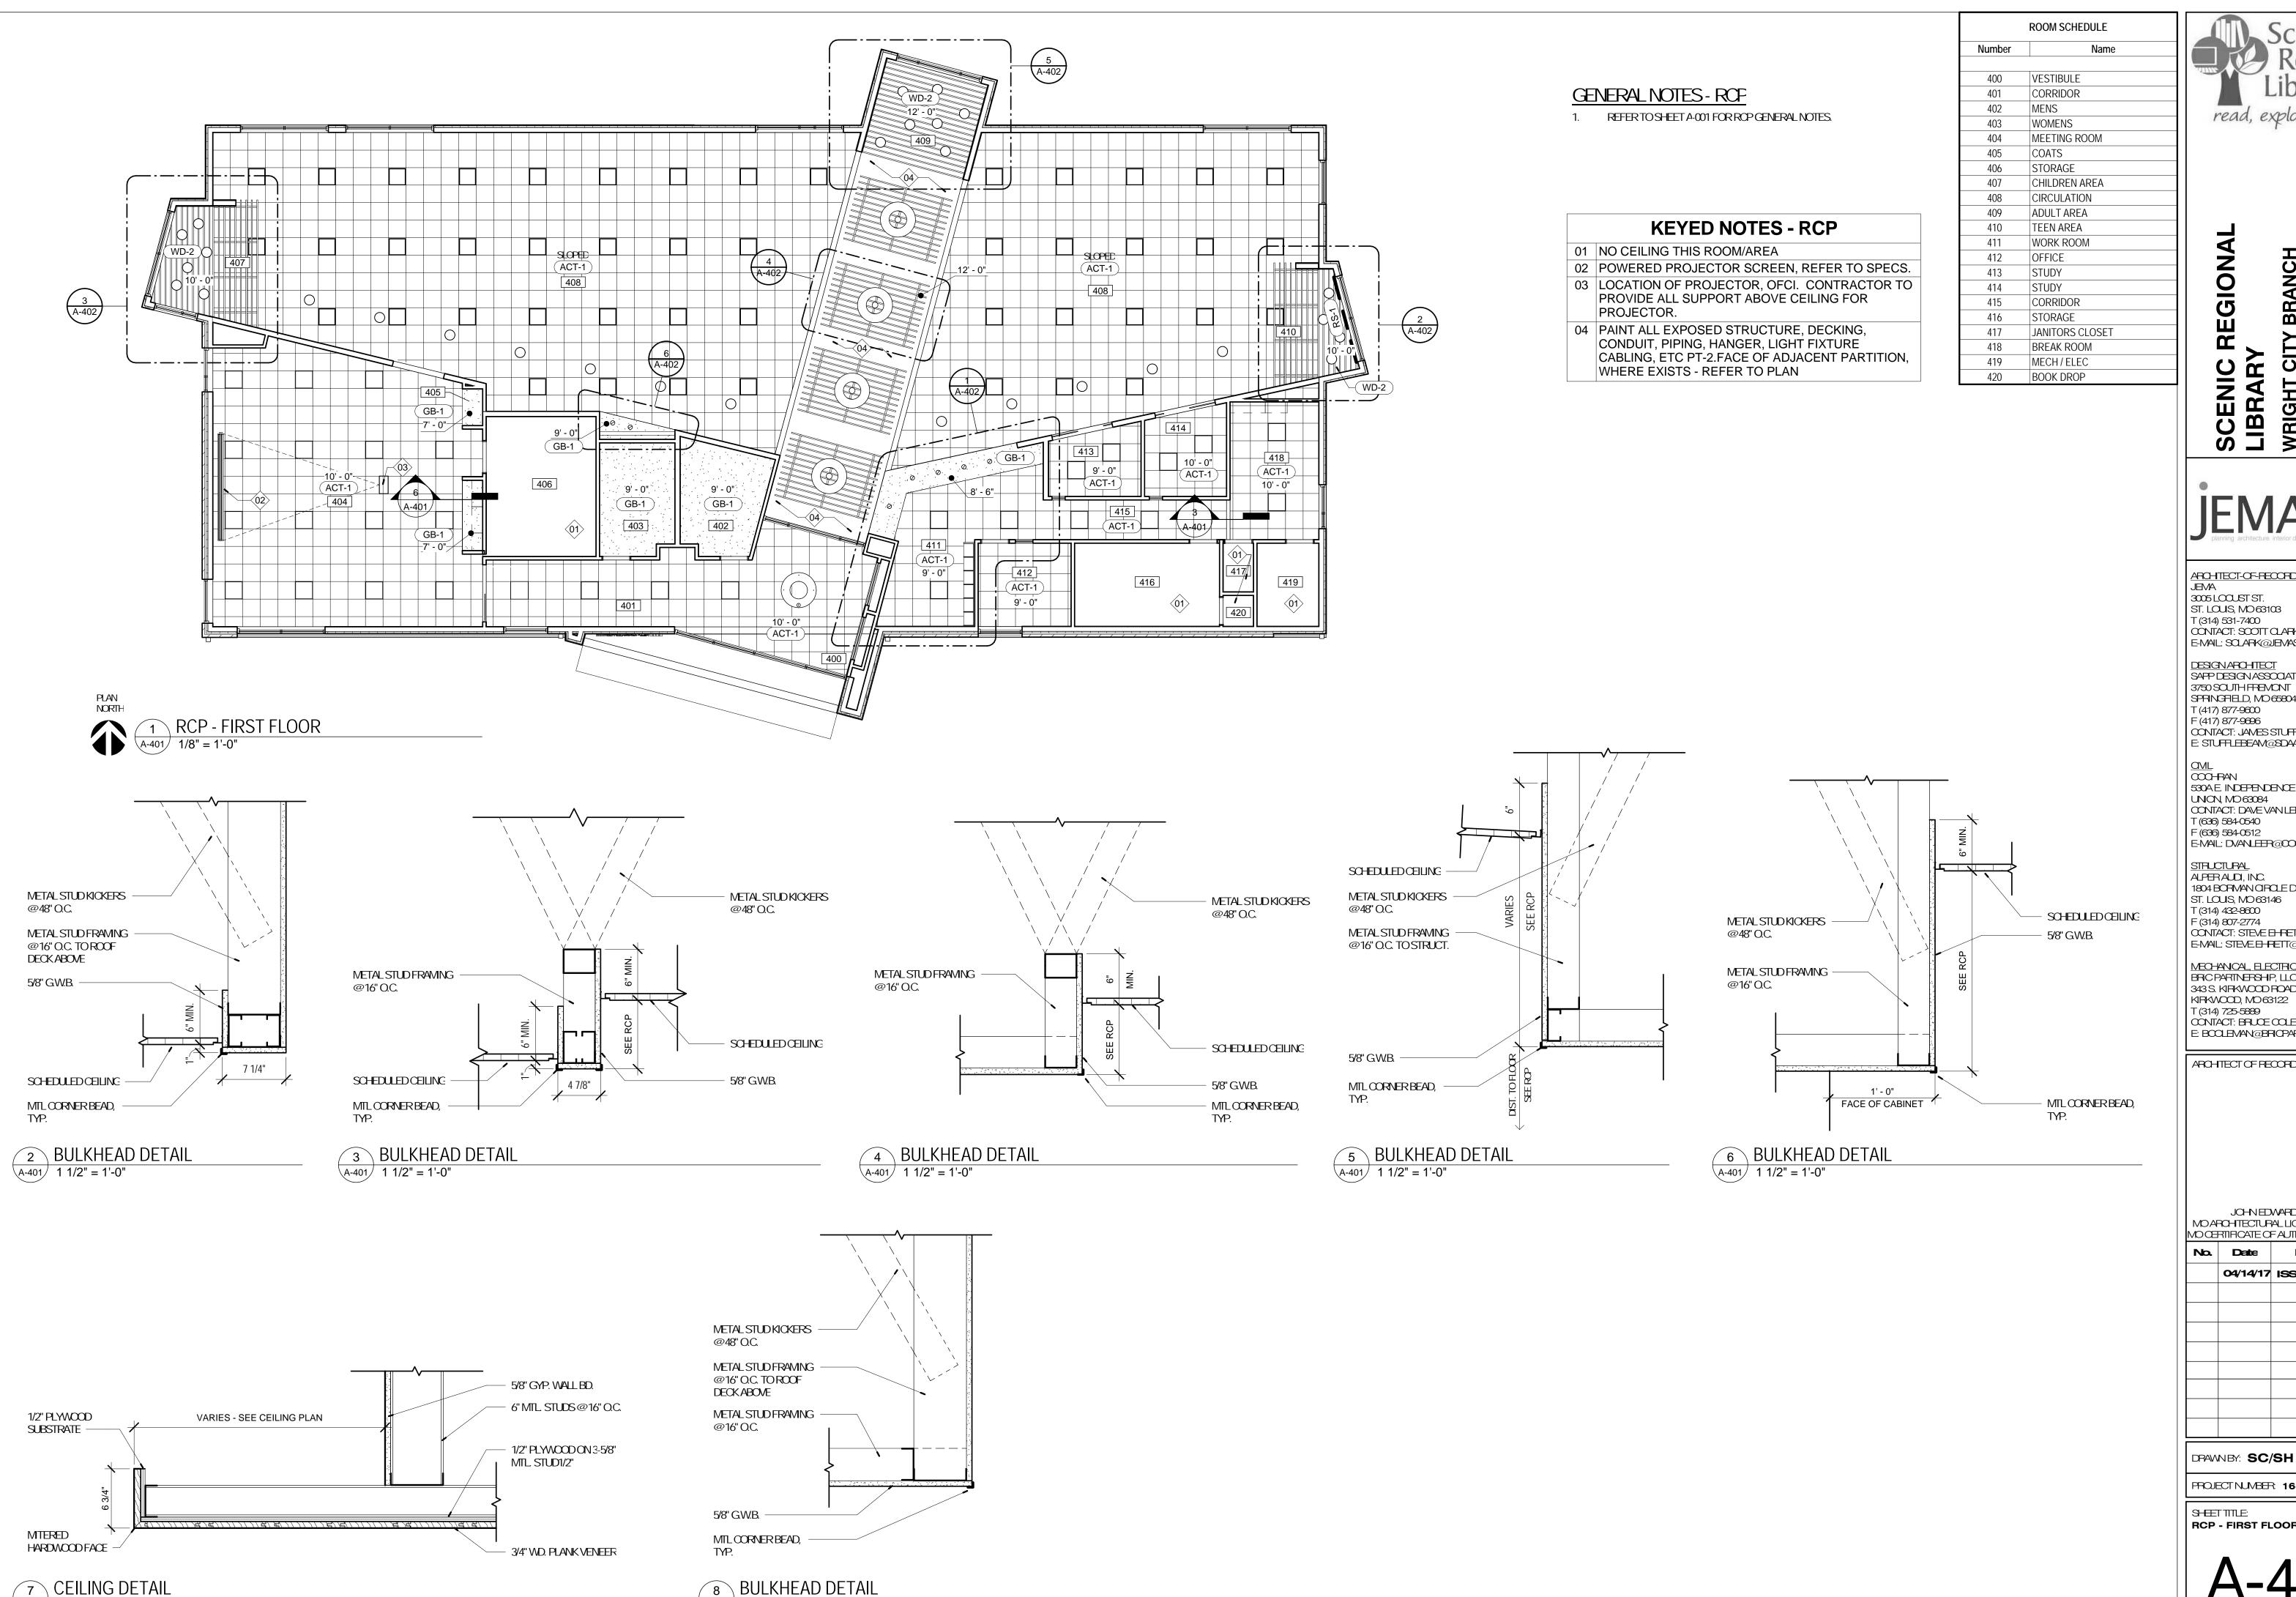
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MDG	RIIHCAIEC	FAUIHURITY A2014008380.				
No.	Date	Description				
	04/14/17	ISSUED FOR BID				

DRAWNBY: SC/SH

PROJECT NUMBER: 16-1161.03

SHEETTITLE: ENLARGED FLOOR PLANS



A-401 1 1/2" = 1'-0"

A-401 1 1/2" = 1'-0"



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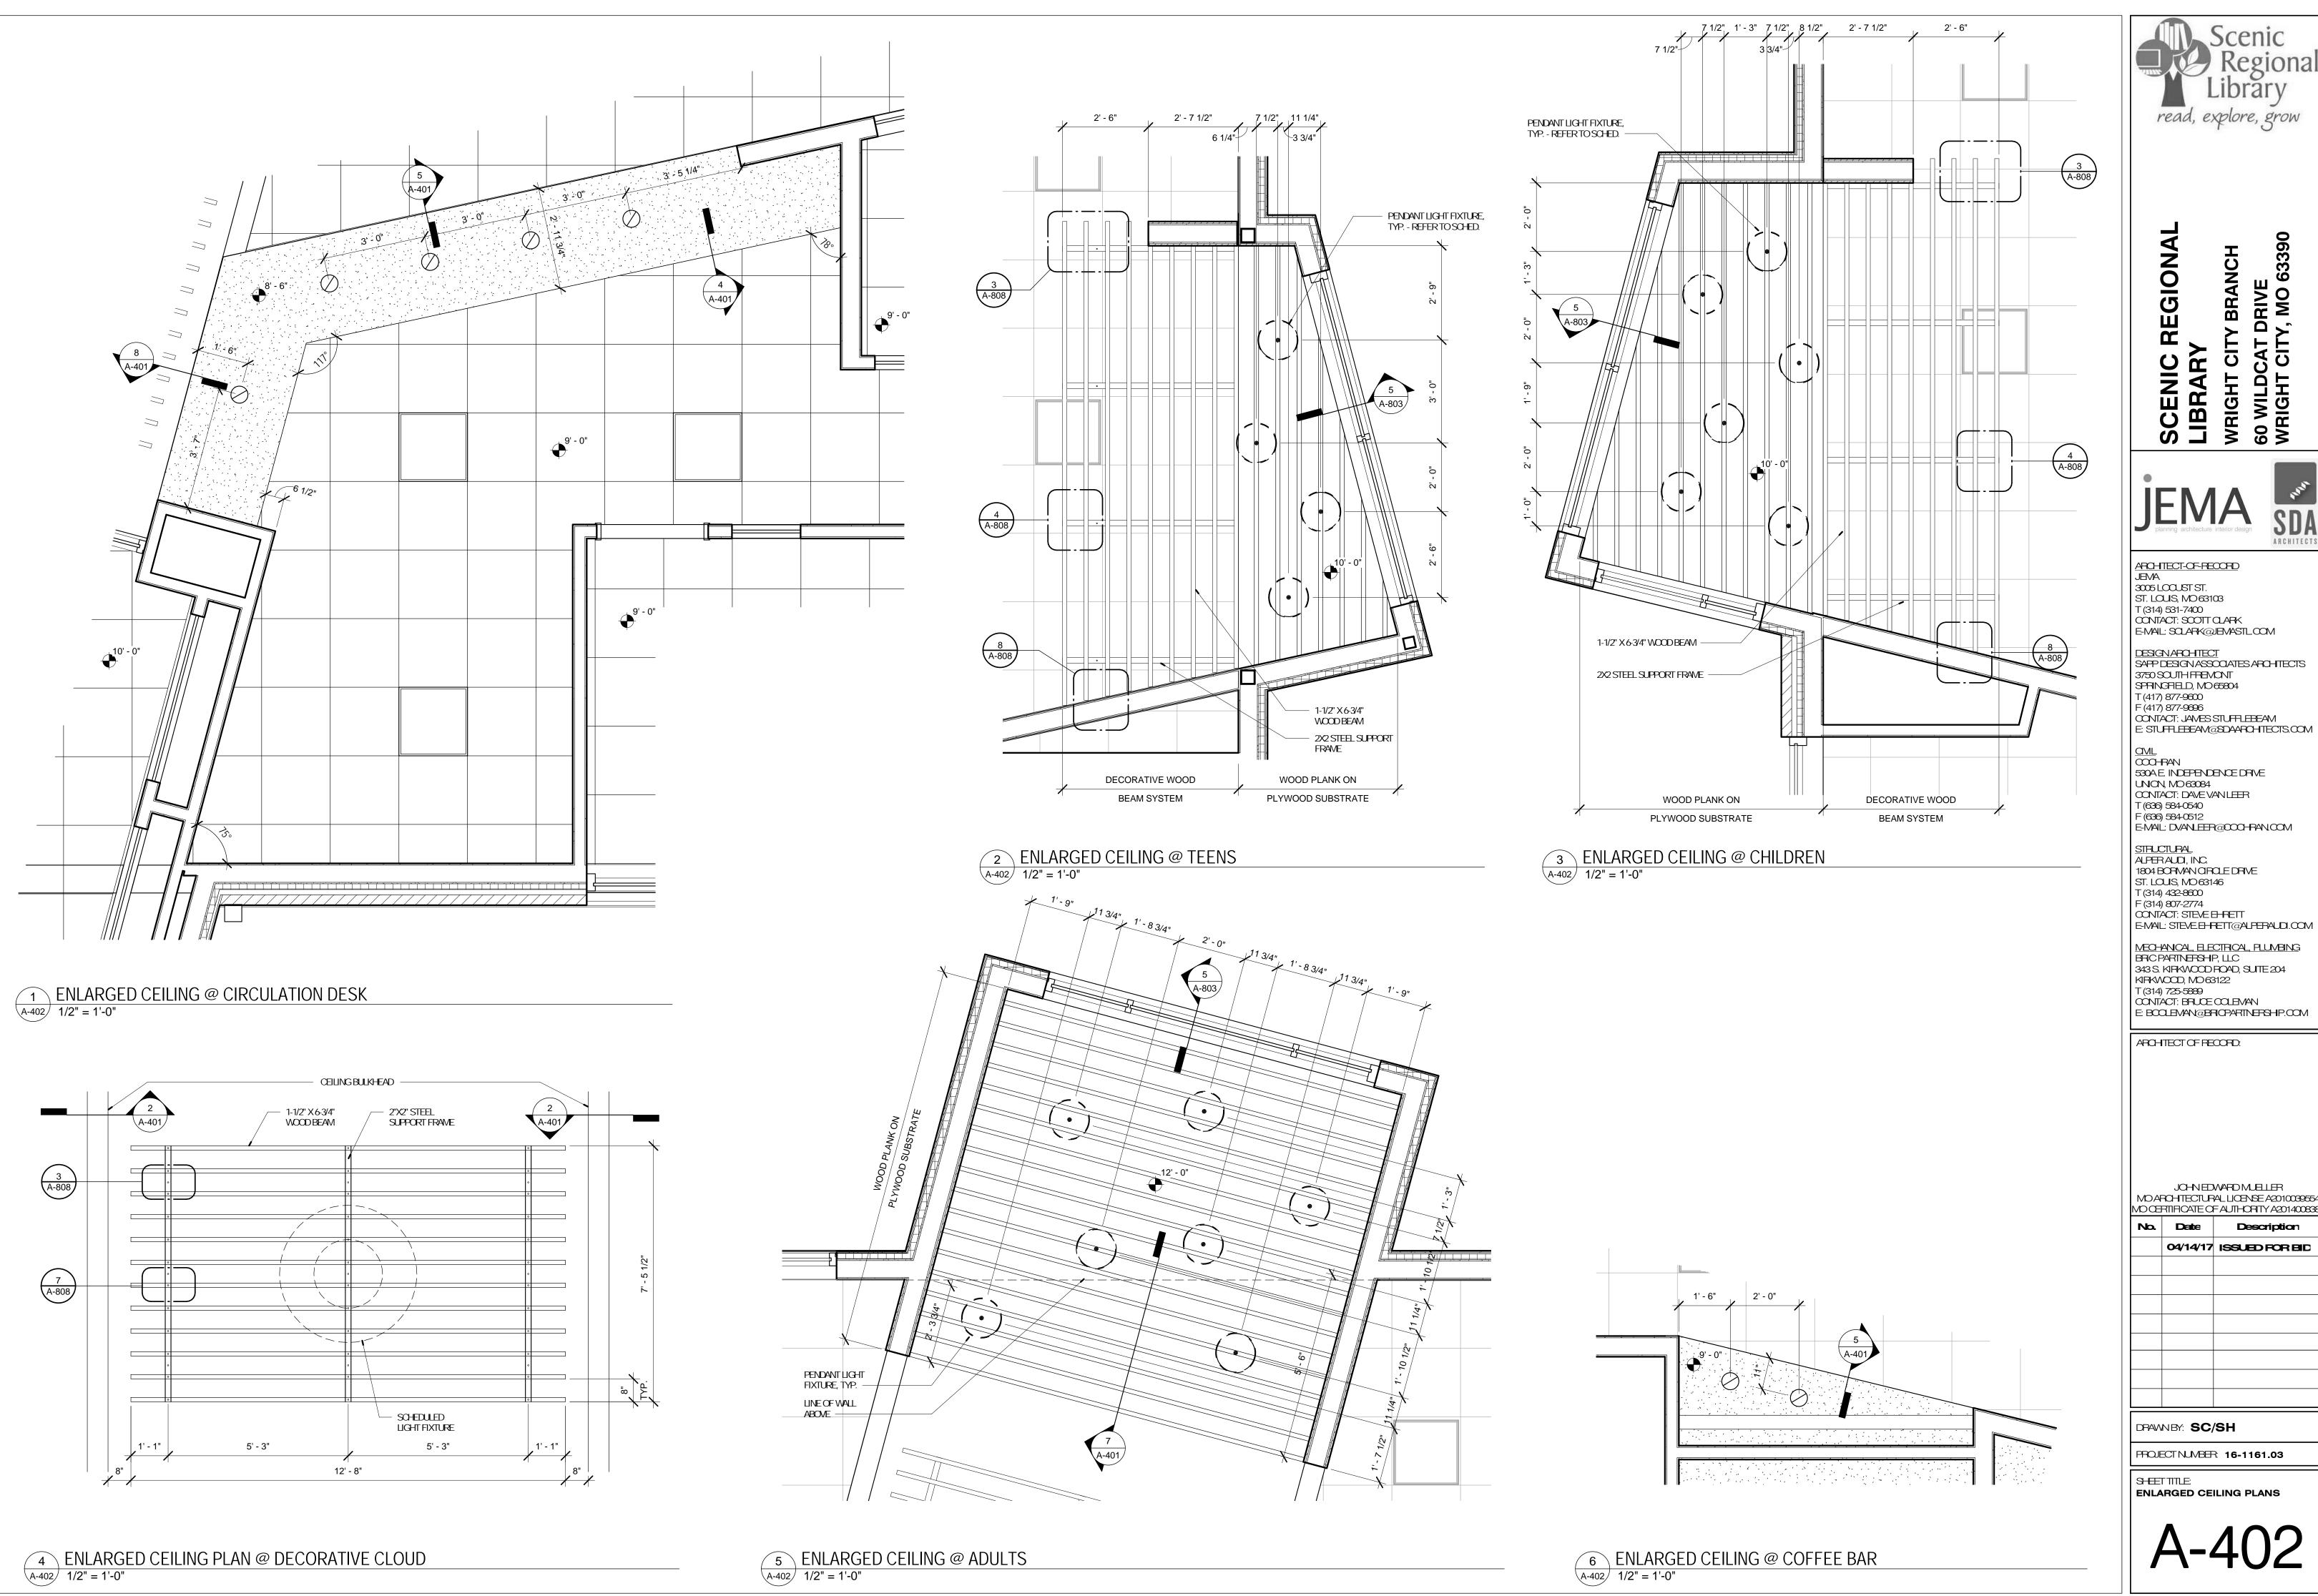
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No.	Date	Description
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PROJECT NUMBER: 16-1161.03

SHEETTITLE: RCP - FIRST FLOOR





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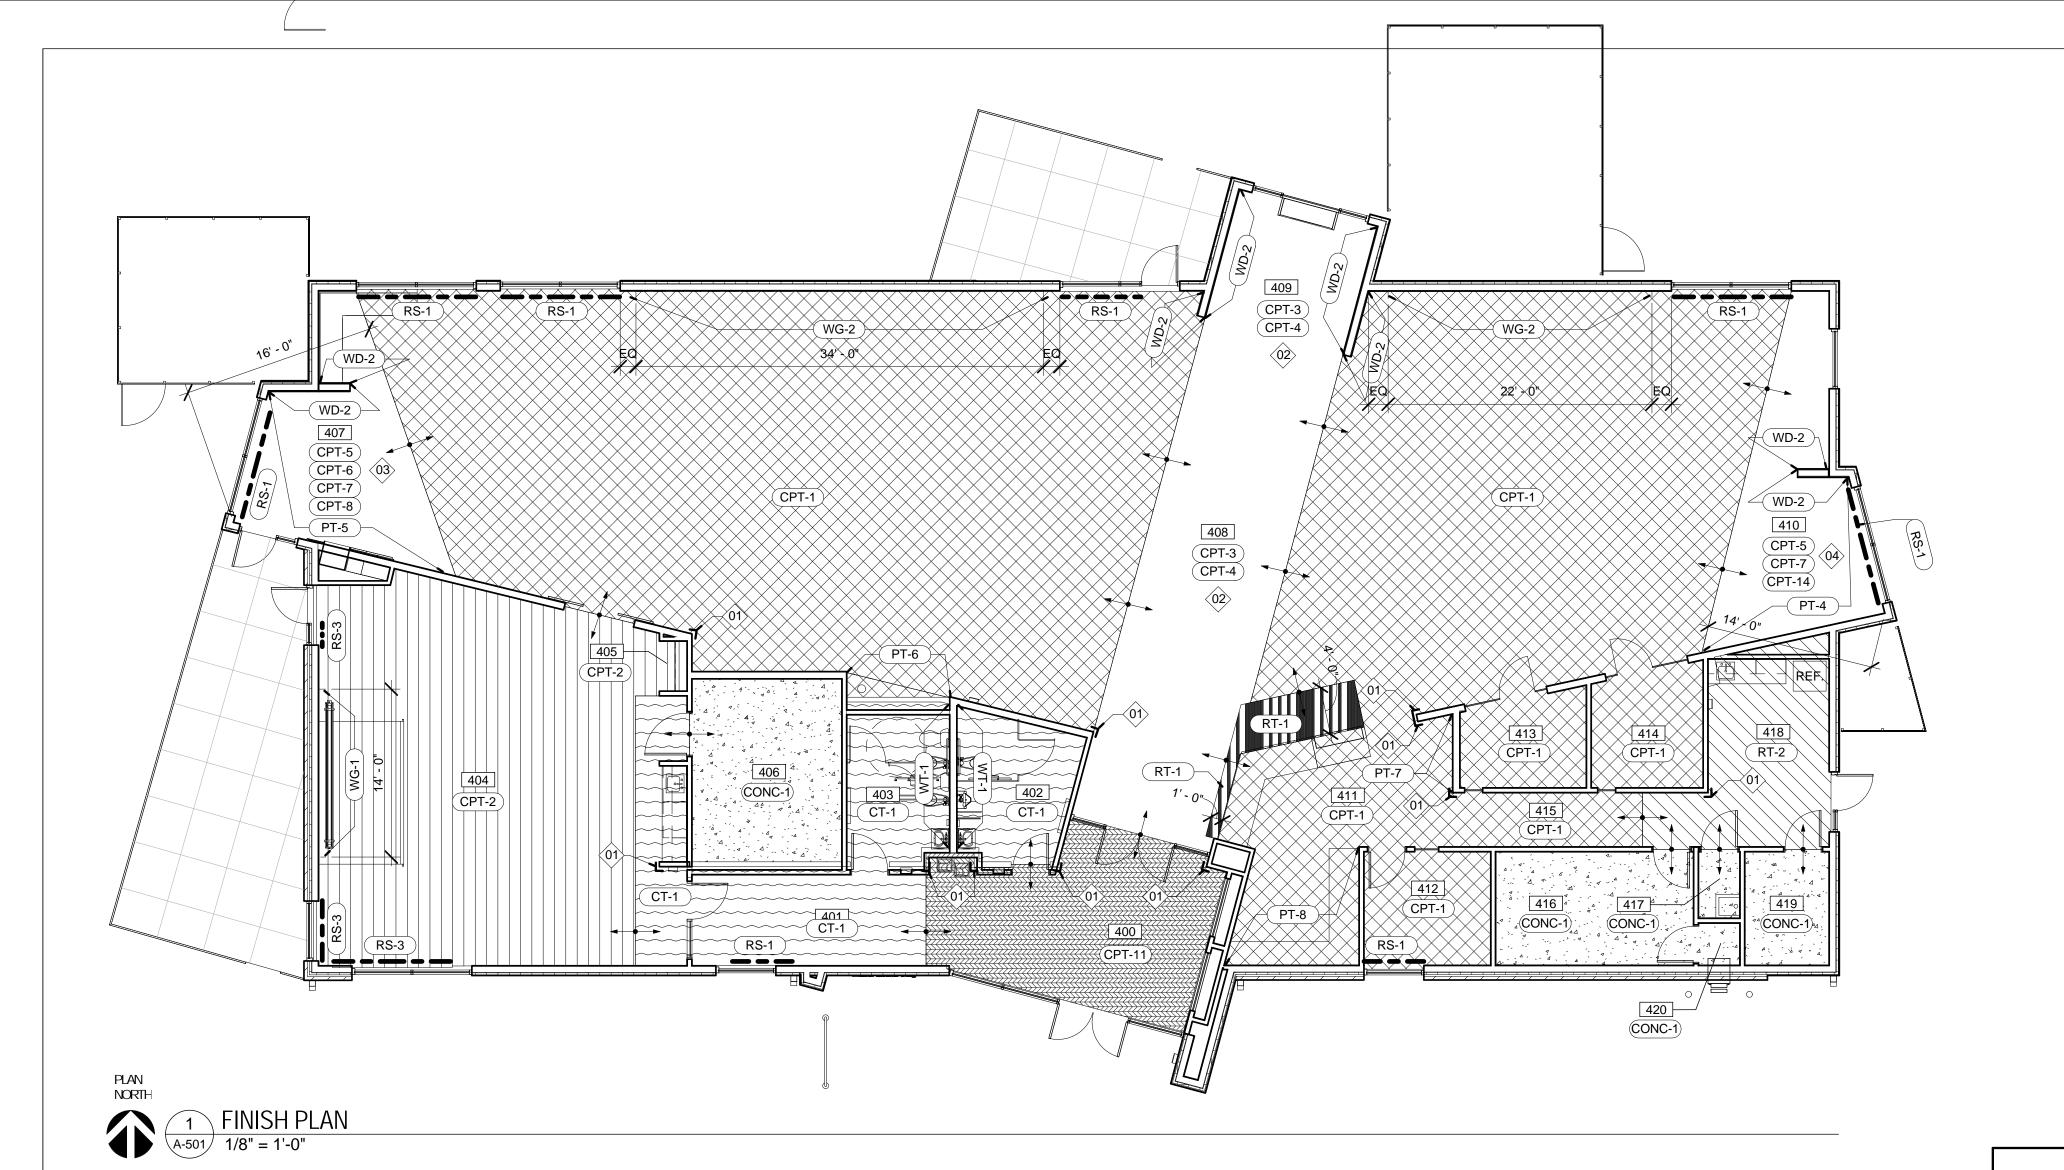
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No.	Date	Description
	04/14/17	ISSUED FOR BID

DRAWNBY: SC/SH

SHEETTITLE: ENLARGED CEILING PLANS



GENERAL NOTES - FINISH PLAN

1. FINISHPLANGENERAL NOTE

ROOM FINISH SCHEDULE - 1ST FLOOR

SOUTH

NORTH

WALL

PT-1

WALLS

PT-1

PT-1

WALL EAST WALL WALL CEILING FINISH

PT-1

PT-1

ACT-1

ACT-1

ACT-1

ACT-1

N/A

N/A

ACT-1

N/A

N/A

Number

401

402

403

404

405

406

407

408

409

410

411

412

413

414

415

416

417

418

KEYED NOTES - FINISH PLAN								
Keynote Number	Description							
01	PROVIDE CORNER GUARD THIS LOCATION, SEE SPECS.							
02	COMBINATION OF CPT-3 AND CPT-4 THIS AREA.							
03	COMBINATION OF CPT-5, CPT-6, CPT-7 AND CPT-8 THIS AREA.							
04	COMBINATION OF CPT-5, CPT-7 AND CPT-14 THIS AREA.							



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REMARKS

ROOM SCHEDULE

VESTIBULE

MENS

CORRIDOR

WOMENS

COATS

STORAGE

MEETING ROOM

CHILDREN AREA

CIRCULATION

ADULT AREA

TEEN AREA

WORK ROOM

OFFICE

STUDY

STUDY

419 MECH / ELEC

420 BOOK DROP

CORRIDOR

STORAGE

BREAK ROOM

JANITORS CLOSET

Name

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No. Date Description

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	04/14/17	ISSUED FOR BID

DRAWNBY: SC/SH PROJECT NUMBER: 16-1161.03

SHEETTITLE: FINISH PLAN / LEGEND

									0 0						02.20	
FINISH LEGENC NOTE: NOT ALL FINISHES LISTED BELOWAPPLY TO THIS BRANCH. REFER TO DRAWINGS FOR ALL FINISH LOCATIONS.																
		NOTO TO LETTING TEOCHTONIC.					400	VESTIBULE	CPT-11	RB-1	PT-1	PT-1	PT-1	PT-1	ACT-1	
(CPT-1) DESC: MODULAR CARPET TILE (18X36)	(CPT-9) DESC: MODULAR CARPET TILE (24X24)	RT-2 DESCRIPTION: LUXURY VINYL TILE	GL-2	DESCRIPTION: 1/4" CLEAR TEMPERED GLASS	PT-9	MNF: SHERWIN-WILLIAVS	401	CORRIDOR	CT-1	TB-1	PT-1	PT-1	PT-1	PT-1	ACT-1	
MNF: TANDUS CENTIVA	MNF: SHAWCONTRACT GROUP	MNF: SHAWHARD SURFACE	GL-3	DESCRIPTION: 1/2" CLEAR TEMPERED GLASS		COLOR TBC	402	MENS	CT-1	TB-1	PT-1	PT-1	PT-1	WT-1	GB-1	NO TB-1 ON WET WALL, REF
STYLE: EVANESCE 04617	STYLE: COLOR FORV	STYLE: GRAIN+PIGMENT COLOR: BONE 65515	OL-3	DESCRIPTION 1/2 CHANTEN ENDOLAS		LOCATION: EXT. METAL DOORS										ELEVATION
COLOR SPACE GREY 73702	COLOR PUZZLE 81991	LOCATION: BREAKROOV	GL-4	DESCRIPTION: 1" IG UNIT, SPANDREL GLASS	RB-1	DESCRIPTION: 4" VINYL BASE	403	WOMENS	CT-1	TB-1	PT-1	PT-1	WT-1	PT-1	GB-1	NO TB-1 ON WET WALL, REF
INSTALLATION: HERRINGBONE	INSTALLATION: 1/4 TURN	TB-1 DESCRIPTION: 3X24 PORCELAIN TILE BASE		MNF: PPG, STYLE: SOLARBAN 60 + OPACI-COAT-3	300	MNF: JOHNSONITE										ELEVATION
SIZE: 18" X 36"	SIZE: 24" X 24"	MNF: TRENDS IN TILE, EURO COLLECTION		COLOR CLEAR + CLEAR GLASS, MEDIUM GRAY		SIZE: 4" HIGH STRAIGHT BASE	404	MEETING ROOM	CPT-2	RB-1	PT-1	PT-1	PT-1	PT-1/WG-1	ACT-1	GB-1 SOFFIT AT COUNTER
(CPT-2) DESC: MODULAR CARPET TILE (24X24)	(CPT-10) DESC: MODULAR CARPET TILE (24X24)	STYLE: ERAVOSA COLORSILVER		SURFACE: MEDIUMGRAY, SURFACE #3		COLOR 63 BURNT UMBER	405	COATS	CPT-2	RB-1	PT-1	PT-1	PT-1	N/A	GB-1	1
MNF: TANDUS CENTIVA	MNF: SHAWCONTRACT GROUP	SIZE: 3" X 24" GROUT: MAPEI 02 PEWTER	ACT-1	DISC: 2X2ACOUSTICAL CEILING TILE	PL-1	MNF: FORMCA	406	STORAGE	CONC-1	RB-1	PT-1	PT-1	PT-1	PT-1	N/A	
STYLE: EVANESCE 04617	STYLE: MEW	OR LATICRETE 90 LIGHT PEWIER		MNF: ARIVISTRONG		COLOR: 5886-43 SORREL CHERRY	407	CHILDREN AREA	CPT-5,6,7,8	RB-1	WD-2	PT-5	N/A	PT-5	WD-2/ACT-1	ACT-1 ON UPPER CEILING
COLOR SPACE GREY 73702	COLOR SPACE 78500	(RB-1) DESCRIPTION: 4" MNML BASE		STYLE: ULTIMA BEVELED TEGULAR #1942		FINISH, ARTISAN	408	CIRCULATION	CPT-1	RB-1	PT-1/WG-	2 PT-1/PT-6	PT-1	PT-1	ACT-1	
INSTALLATION: VERTICAL ASHLAR SIZE: 24" X 24"	INSTALLATION: 1/4 TURN	MNF: JOHNSONITE	/DEC	SIZE: 24" X24" COLOR WHITE		LOCATION: CIRCULATION DESK/	409	ADULT AREA	CPT-3, CPT-4	RB-1	PT-1	N/A	WD-2	WD-2	WD-2/ACT-1	ACT-1 ON UPPER CEILING
	SIZE: 24" X 24"	STYLE: 4" STRAIGHT BASE COLOR: 63 BURNT UV	/BEK	GRID 9/16"		COFFEE, FIREPLACE VERTICAL SURFACES.	410	TEEN AREA	CPT-5,7,14	RB-1	WD-2	PT-4	PT-4	N/A	WD-2/ACT-1	ACT-1 ON UPPER CEILING
(CPT-3) DESC: MODULAR CARPETTILE (24X24)	(CPT-11) DESC: MODULAR CARPET TILE (24X24)	(FB-1A) DESCRIPTION: CHLDREN'S CUSHON	GB-1	DISC: 1/2" GYPSUMBOARD	PL-2	MNF: LAMN-ART	411	WORK ROOM	CPT-1	RB-1	PT-1	PT-8	PT-1/PT-7	PT-1	ACT-1	
MNF: TANDUS CENTIVA	MNF: TANDUS CENTIVA	MNF: ARC-COM STM F: AXIS		COLOR PT-2		COLOR 3057-VT	412	OFFICE	CDT 1	DD 1	DT 1	DT 1	DT 1	DT 1	ACT 1	

COLOR: 3057-VT FINISH: VELVA-TEX LOCATION: WORK RM/MTG, RM/BREAK RM CUT: PLAIN-SLICED VENEER VERTICAL SURFACES.

> (PL-3) MNF: FORMCA COLOR 961-58 FOG FINISH: MATTE LOCATION: WORK RM/BREAK RM TOPS

(PL-4) MNF: FORMCA COLOR M2178 BRUSHED STAINLESS STEEL LOCATION: CIRCULATION DESKAND FIREPLACE BASE

PL-5 MNF: FORMCA COLOR STOP RED 839-58 FINISH: MATTE FINISH

MNF: FORMCA COLOR MBRANT GREEN 6901-58 FINISH: MATTE FINISH

MNF: FORMCA COLOR SPECTRUMBLUE 851-AN FINISH: INFINITI FINISH

SS-1 MNF: AVONITE COLOR NORDIC F1-9119 LOCATION: CIRCULATION COUNTER INSET, MTG. RM/COFFEE TOPS

MNF: DOUGMOCKETT&COMPANY, INC. STYLE: DP105/3 SERIES SQUARE PULL COLOR STAINLESS STEEL SIZE: 627/32 X 9/16 SQUARE PULL

DESCRIPTION: WINYLWALL GRAPHIC MNF: SIZE: SEE PLAN AND ELEVATION

DESCRIPTION: CUSTOM DIGITAL WALL IMAGE MNF: ARC-COV TYPE II VINYL, CUSTOMIMAGE TO BE DETERMINED. SIZE: (1) 28-0" WIDE BY 8-0" TALL, BOT. AT 6'-0" AFF (1) 35-0" WIDE BY 8-0" TALL, BOT. AT 6-0" AFF.

REP CONTACT: AFTEN ZURLIENE, 314-465-2257

AZURLIENE@ARC-COMCOV

JANITORS CLOSET CONC-1

CPT-1

CPT-1

CPT-1

CPT-1/RT-2

CONC-1

RT-2

CONC-1

CONC-1

RB-1

RB-1

RB-1

RB-1

RB-1

RB-1

RB-1

FLOOR FINISH

NUMBER

OFFICE

STUDY

STUDY

CORRIDOR

BREAK ROOM

MECH / ELEC

BOOK DROP

OPENNESS: 10%

STORAGE

DESCRIPTION: SINGLE MANUAL ROLLER SHADE MNF: SWF CONTRACT FABRIC COLOR PEARL GRAY, SHEARWEAVE 2360

DESCRIPTION: SINGLE MANUAL BLACK-OUT SHADE MNF: SWF CONTRACT OPENNESS: FULL BLACK-OUT, BLACK DUPLEX R6039

DESCRIPTION: DUEL MANUAL BLACK-OUT/FABRIC SHADE MNF: SWF CONTRACT FABRIC COLOR PEARL GRAY, SHEARWEAVE 2360

OPENNESS: 10% OPENNESS: FULL BLACK-OUT, BLACK DUPLEX R6039

	MNF: SHAWCONTRACT GROUP STYLE: MEW COLOR OVERLOOK 78436		STYLE: ERAWOSA COLORSILVER SIZE: 6" X 24" INSTALLATION: 1/3 OFFSET GROUT: MAPEL 02 PEWTER OR LATICRETE		SIZE: 6" X 24" INSTALLATION: SEE DETAILS GROUT: MAPEI 02 PEWTER OR LATICRETE 90 LIGHT PEWTER		
	INSTALLATION: 1/4 TURN SIZE: 24" X 24"		90 LIGHT PEWIER	WT-3	DESCRIPTION: WALLTILE - BULLNOSE		
CPT-8	DESC: MODULAR CARPET TILE (24X24) MNF: SHAWCONTRACT GROUF STYLE: VIEW	CONC-1	DESCRIPTION: SEALED CONCRETE COLOR: CLEARMATTE FINISH		MNF: ISC SURFACES ANATOLIA TILE SERIES: SOHO SIZE: 4" X 8" COLOR TAUPE GLOSSY GROUT: MAPEL 02 PEWTER OR LATICRETE 90 LI		
	COLOR GLIMPSE 78855 INSTALLATION: 1/4 TURN	RT-1	DESCRIPTION: LUXURY VINYL TILE		PEWTER LOCATION: RESTROOMWET WALLS @PERIMET		

MNF: SHAWHARD SURFACE

MNF: TANDUS CENTIVA

SIZE: 24" X 24"

STYLE: MEW

SIZE: 24" X 24"

STYLE: MEW

SIZE: 24" X 24"

STYLE: MEW

SIZE: 24" X 24"

COLOR: CHARCOAL 19100

(CPT-12) DESC: MODULAR CARPET TILE (24X24)

COLOR: LANDSCAPE 78675

INSTALLATION: 1/4 TURN

(CPT-13) DESC: MODULAR CARPET TILE (24X24)

COLOR: EMBER 81870

COLOR PLACE 78210

INSTALLATION: 1/4 TURN

(CT-1) DESCRIPTION: 6X24 PORCELAINTILE

MNF: TRENDS IN TILE, EURO COLLECTION

INSTALLATION: 1/4 TURN

(CPT-14) DESC: MODULAR CARPET TILE (24X24)

MNF: SHAWCONTRACT GROUP

MNF: SHAWCONTRACT GROUP

MNF: SHAWCONTRACT GROUP

INSTALLATION: MONOLITHIC

STYLE: ABRESIVE ACTION 02578

3A STYLE: EVANESCE 04617

COLOR OPEN OCEAN 73706

(CPT-4) DESC: MODULAR CARPET TILE (24X24)

COLOR BLUE GRANITE 20421

MNF: SHAWCONTRACT GROUP

DESC: MODULAR CARPET TILE (24X24)

MNF: TANDUS CENTIVA

3B STYLE: ROCK SOLID II

INSTALLATION: 1/4 TURN

INSTALLATION: 1/4 TURN

SIZE: 24" X 24"

SIZE: 24" X 24"

STYLE: MEW

SIZE: 24" X 24"

SIZE: 24" X 24"

SIZE: 24" X 24"

COLOR GAZE 78530

STYLE: COLOR FORV

COLOR IMAGINE 81375

INSTALLATION: 1/4 TURN

(CPT-7) DESC: MODULAR CARPET TILE (24X24)

INSTALLATION: 1/4 TURN

(CPT-6) DESC: MODULAR CARPET TILE (24X24)

MNF: SHAWCONTRACT GROUP

ШNOSE PT-6 MNF: SHERWIN-WILLIAMS ATILE VALLS@PERIMETER EDGE STYLE: GRAIN+PIGVENT COLOR GREEN 65326 (GL-1) DESCRIPTION: 1" IG UNIT, LOW-E INSUL. GLASS MNF: PPG, STYLE: SOLARBAN 60 LOCATION: CIRCULATION DESK FRONT

MNF: ARC-COM, STYLE: AXIS

(FB-1B) DESCRIPTION: CHLDREN'S CUSHON

(FB-1C) DESCRIPTION: CHLDREN'S CUSHON

(FB-1D) DESCRIPTION: CHLDREN'S CUSHON

MNF: ARC-COM, STYLE: AXIS

MNF: ARC-COM STYLE: AXIS

MNF: ARC-COM, STYLE: AXIS

MNF: ARC-COM, STYLE: AXIS

SERIES: SOHO SIZE: 4" X 16"

DESCRIPTION: WALL TILE

COLOR TAUPE GLOSSY

LIGHT PEWTER

NUMBER: AC-61346, COLOR: CHILLI #7

NUVBER: AC-61345, COLOR PUVPKIN#6

NUVBER AC-61349, COLOR LIME #10

DESCRIPTION: CHILDREN'S CUSHON

MNF: ISC SURFACES ANATOLIA TILE

LOCATION: RESTROOMWET WALLS

DESCRIPTION: 6X24 PORCELAINTILE

STYLE: ERAVOSA COLORSILVER

NUMBER AC-61352, COLOR OCEAN#13

GROUT: MAPEL 02 PEWTER OR LATTCRETE 90

MNF: TRENDS IN TILE, EURO COLLECTION

NUMBER AC-61340, COLOR SEAGLASS#1

COLOR TBD RLATICRETE 90 LIGHT PT-7 MNF: SHERWIN-WILLIAMS COLOR OPTIGRAY + CLEAR

LOCATION: ACCENT PAINT COFFEE COLOR TBD LOCATION: ACCENT PAINT CIRCULATION MNF: SHERWIN-WILLIAMS COLOR TBD LOCATION: ACCENT PAINT WORK ROOV

COLOR PT-2

SPECIES: REDOAK

CHOCOLATE, CH15

SPECIES: WHITE MAPLE

FINISH: CLEAR SATIN

PT-1 MNF: SHERWIN-WILLIAMS

COLOR: TBD

PT-2 MNF: SHERWIN-WILLIAMS

COLOR TBD

PT-3 MNF: SHERWIN-WILLIAMS

COLOR TBD

PT-4 MNF: SHERWIN-WILLIAMS

COLOR TBD

PT-5 MNF: SHERWIN-WILLIAVS

COLOR TBD

CUT: PLAIN-SLICED VENEER

MATCH: SLIF-MATCHEC

FINISH: MATCH VT INDUSTRIES

LOOCATION: ALL INTERIOR DOORS

LOOCATION: CEILING AND WALLS


LOCATION: GENERAL WALL COLOR

LOCATION: GENERAL CLG. COLOR

LOCATION: DOOR FRAME COLOR

LOCATION: ACCENT PAINT TEENS

LOCATION: ACCENT PAINT CHILDRENS

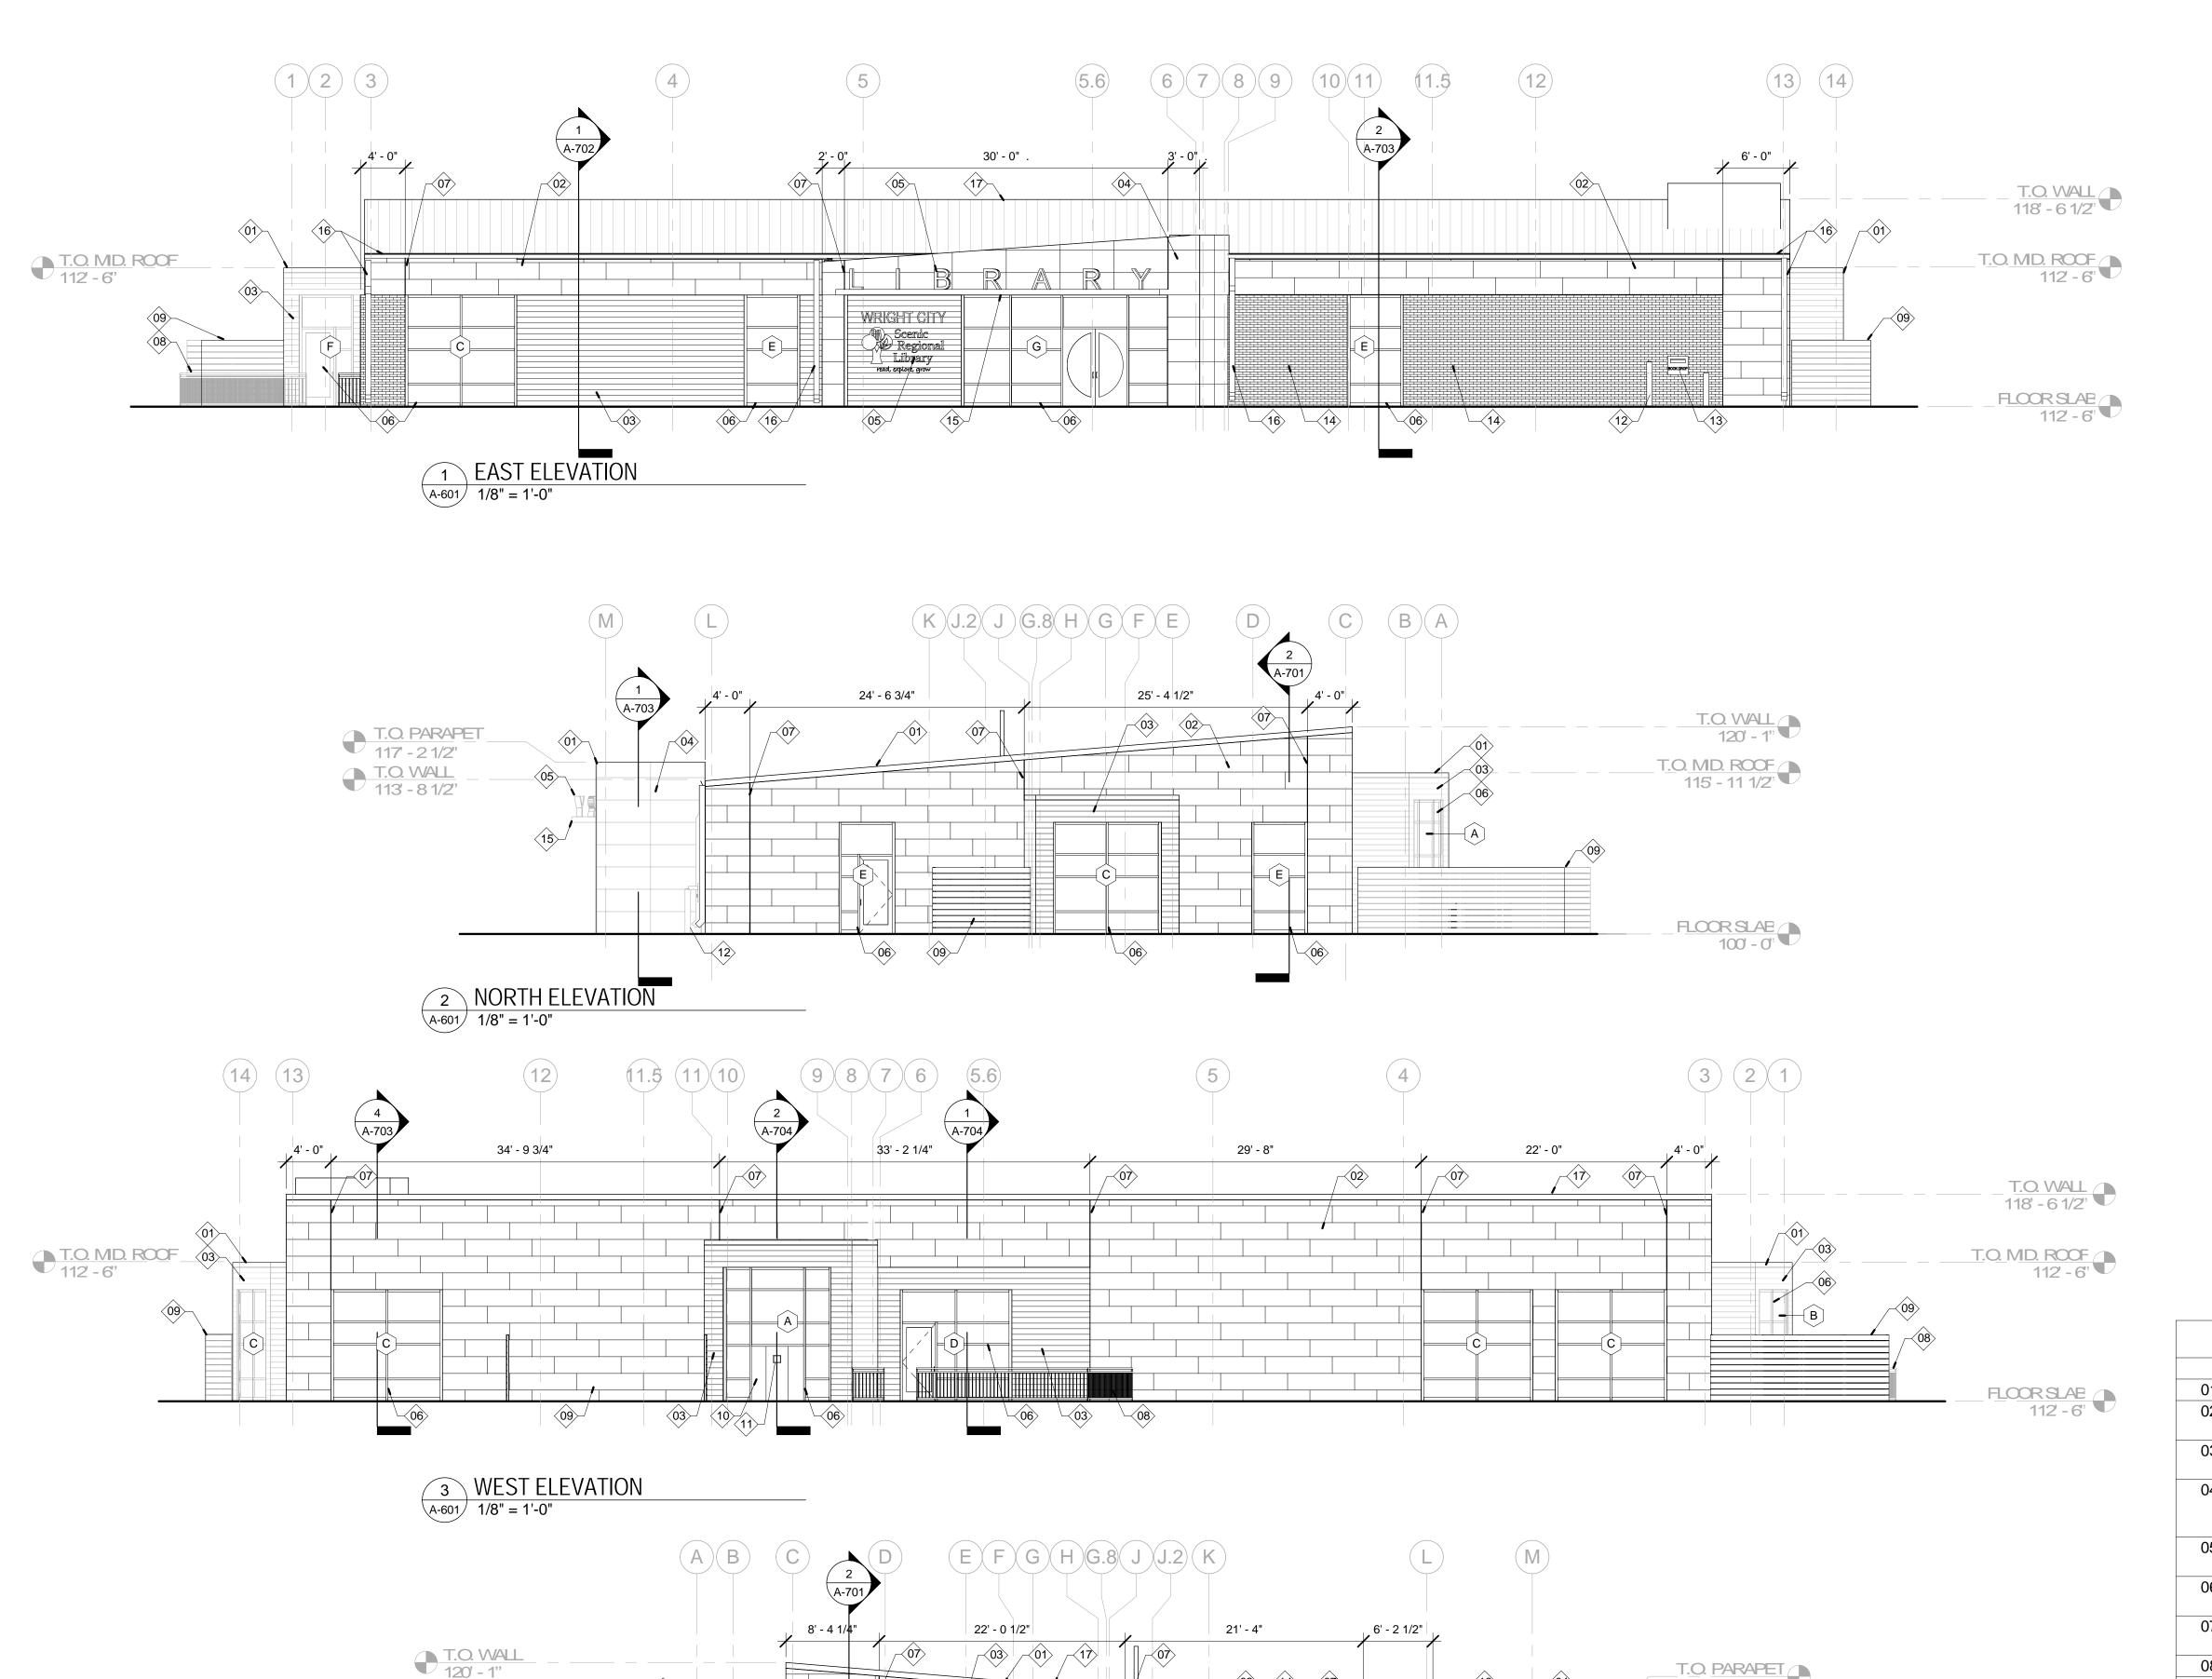


(08)

T.O. MD. ROOF 115 - 11 1/2"

A-601 1/8" = 1'-0"

4 SOUTH ELEVATION

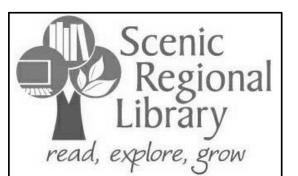

SCENIC REGIONAL
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WRIGHT CITY, MO 63390

EIVA planning architecture interior design

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JOHNEDWARD MUELLER
MO ARCHTECTURAL LICENSE A2010039554
MO CERTIRICATE OF AUTHORITY A2014008380

	No.	Date	Description
		04/14/17	ISSUED FOR BID
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)			
<i>,</i>			

DRAWNBY: SC/SH

PROJECT NUMBER: 16-1161.03

SHEET TITLE:
ELEVATIONS - EXTERIOR

A-601

KEYED NOTES - EXTERIOR ELEVATIONS1

PRE-FINISHED METAL COPING
HORIZONTAL CEMENT FIBER BOARD PANEL W/ 1/3 OFFSET

- LAYOUT REFER TO SPECIFICATIONS

 03 PRE-FINISHED EXTRUDED ALUMINUM SIDING REFER TO SPECIFICATIONS
- SPECIFICATIONS

 04 HORIZONTAL CEMENT FIBER BOARD PANEL W/ STACK BOND
- LAYOUT. VERTICAL SEAMS TO BE CONSTRUCTED SIM. TO VERT. CONTROL JOINTS REFER TO SPECIFICATIONS

 BUILDING SIGNAGE REFER TO SPECS. FOR MORE
- INFORMATION

 06 PRE-FINISHED ALUM. STOREFRONT REFER TO
- SPECIFICATIONS FOR MORE INFORMATION

 VERTICAL CONTR JOINT REFER TO SPECIFICATIONS FOR

117' - 2 1/2'

FLOOR SLAB

100 - 0'

T.O. WALL 113' - 8 1/2'

- MORE INFORMATION

 08 PRE-FINISHED ALUM. FENCE REFER TO SPECIFICATIONS

 09 MECHANICAL SCREEN FENCING REFER TO SPECIFICATIONS
- AND DETAILS


 10 VERTICAL CEMENT FIBER BOARD PANEL LAYOUT REFER TO
- SPECIFICATIONS

 11 GAS FIREDI ACE VENT CAP REFER TO SPECIFICATIONS
- 11 GAS FIREPLACE VENT CAP REFER TO SPECIFICATIONS
 12 TRAFFIC CONTROL BOLLARDS REFER TO CIVIL DWGS. FOR
- MORE INFORMATION

 13 THROUGH-WALL BOOK RETURN UNIT REFER TO SPECIFICATIONS

SPECIFICATIONS

- 14 3-5/8" BRICK VENEER REFER TO SPECIFICATIONS
 15 COMPOSITE METAL PANEL WRAPPED CANOPY REFER TO
- 16 PRE-FINISHED METAL GUTTER & DOWNSPOUT, REFER TO CIVIL DRAWINGS.
- 17 PRE-FINISHED STANDING SEAM METAL ROOFING REFER TO SPECIFICATIONS

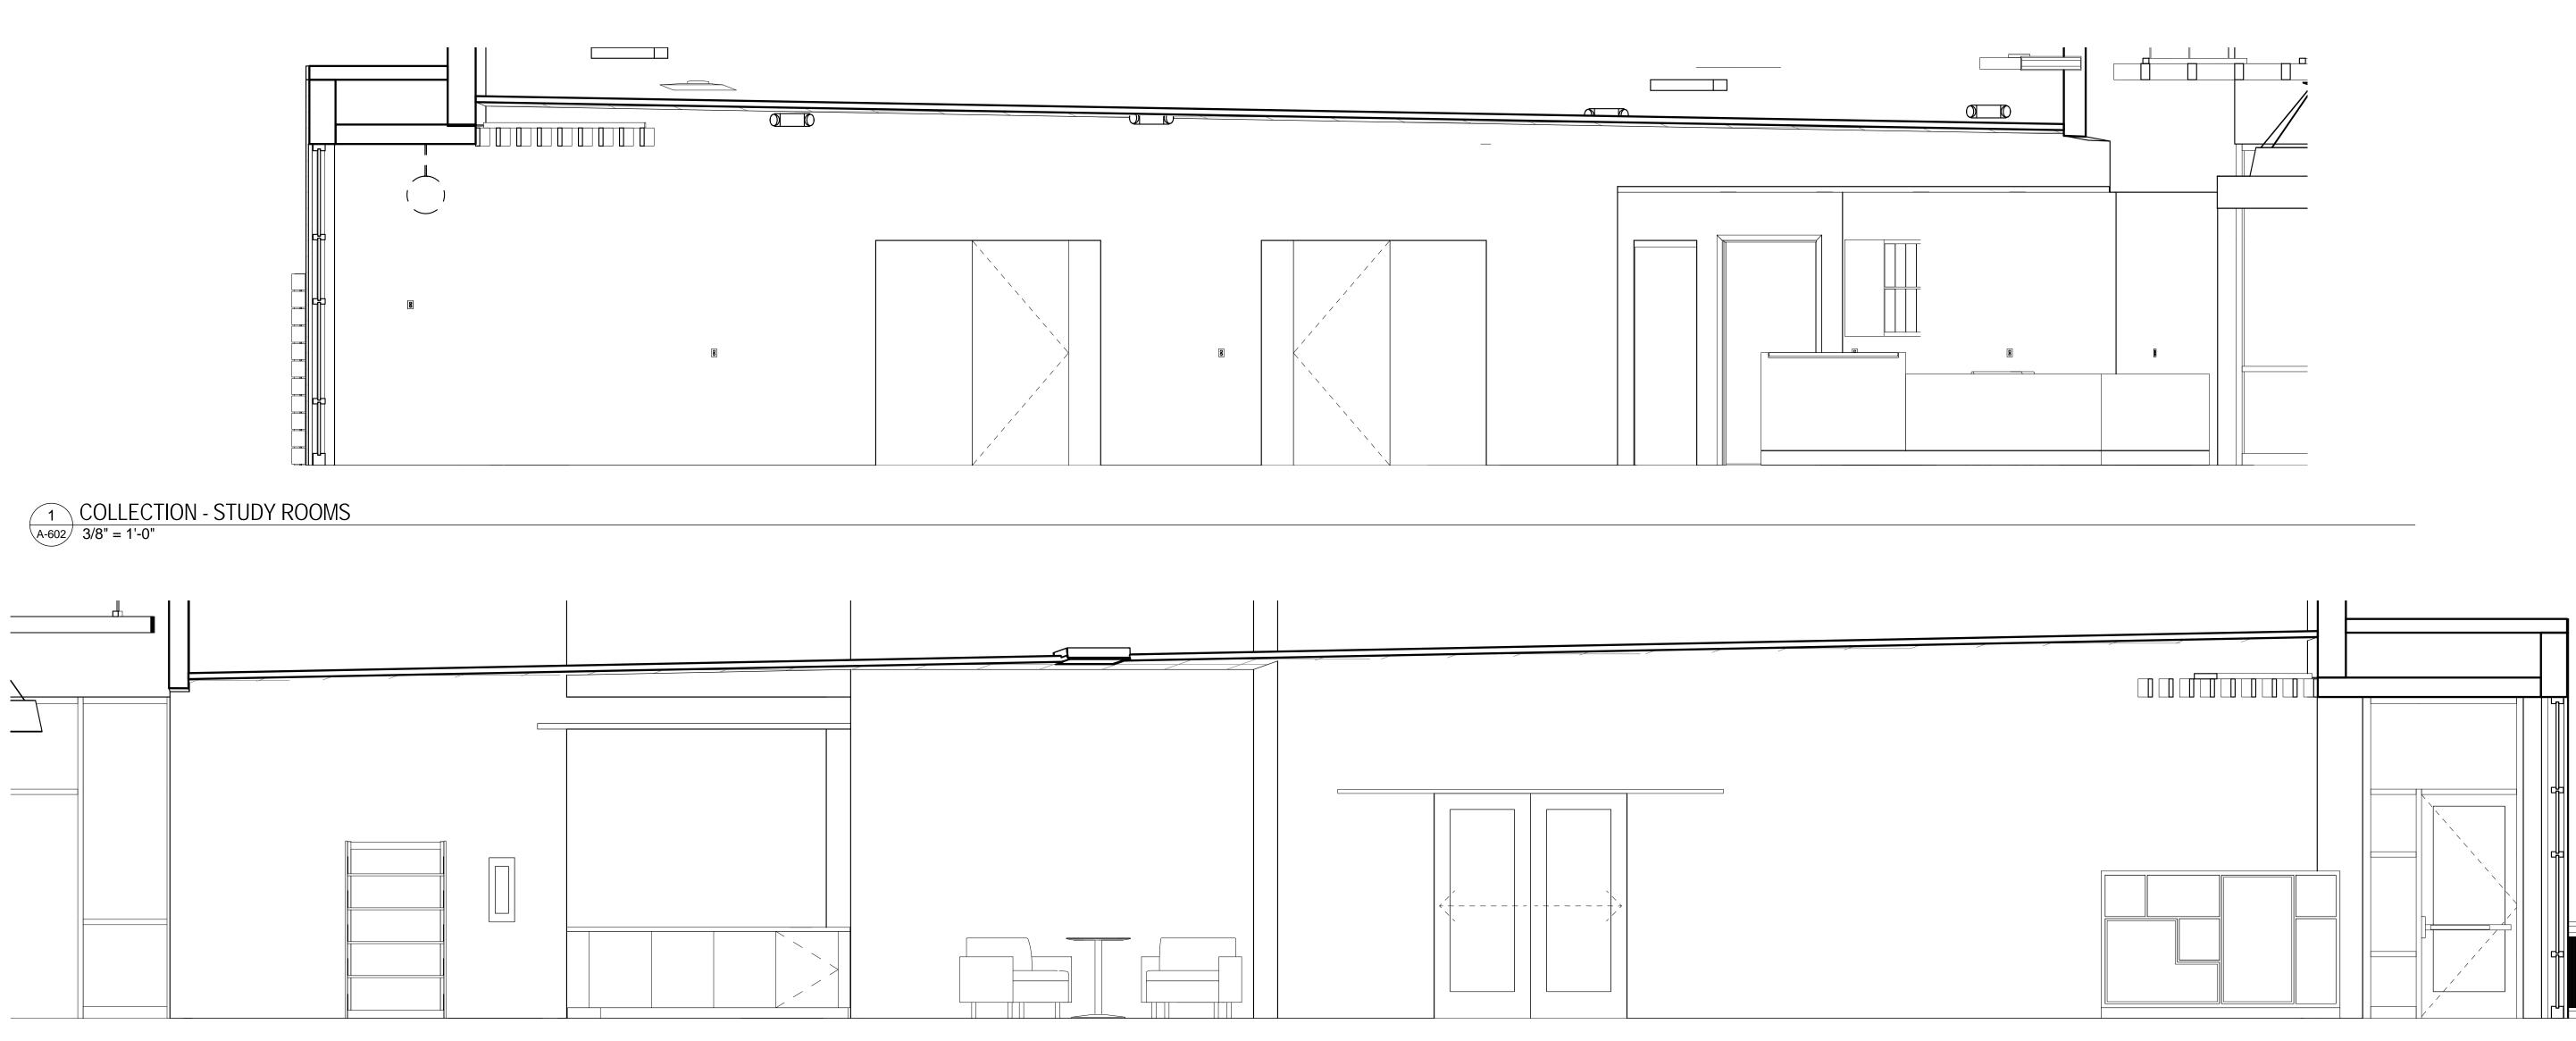

2 COLLECTION - CHILDREN A-602 3/8" = 1'-0"

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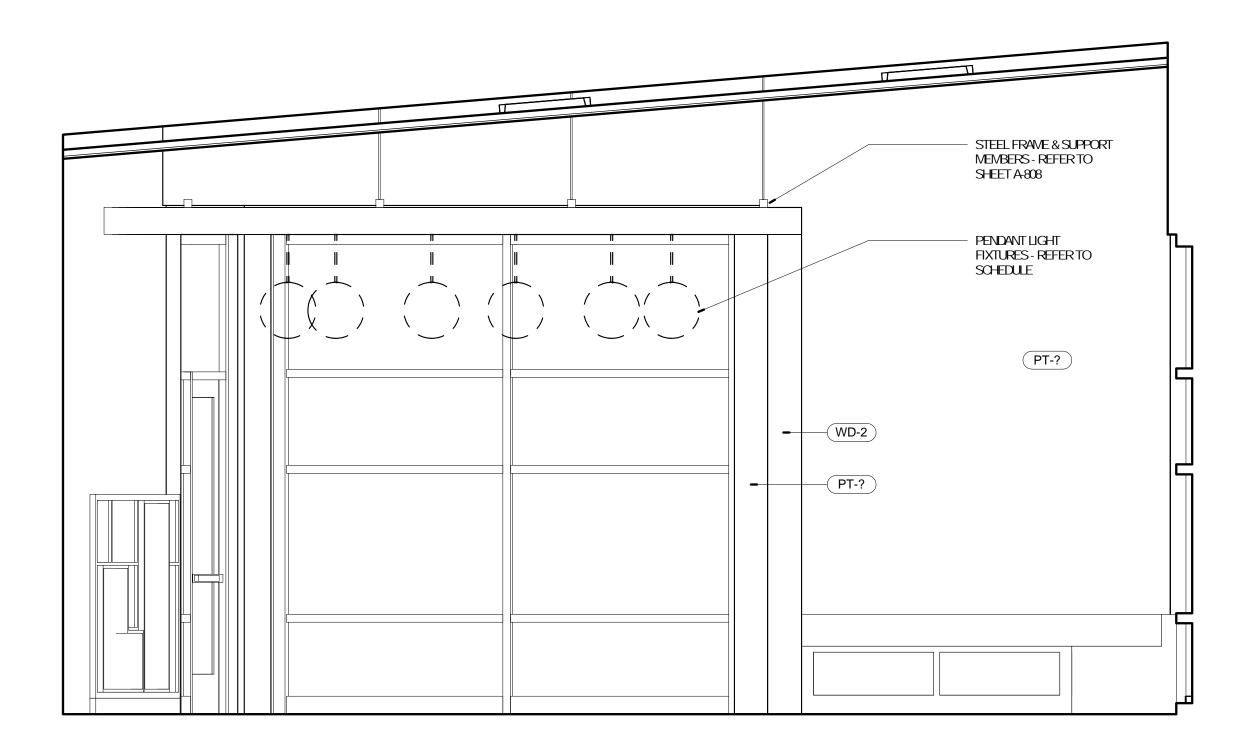
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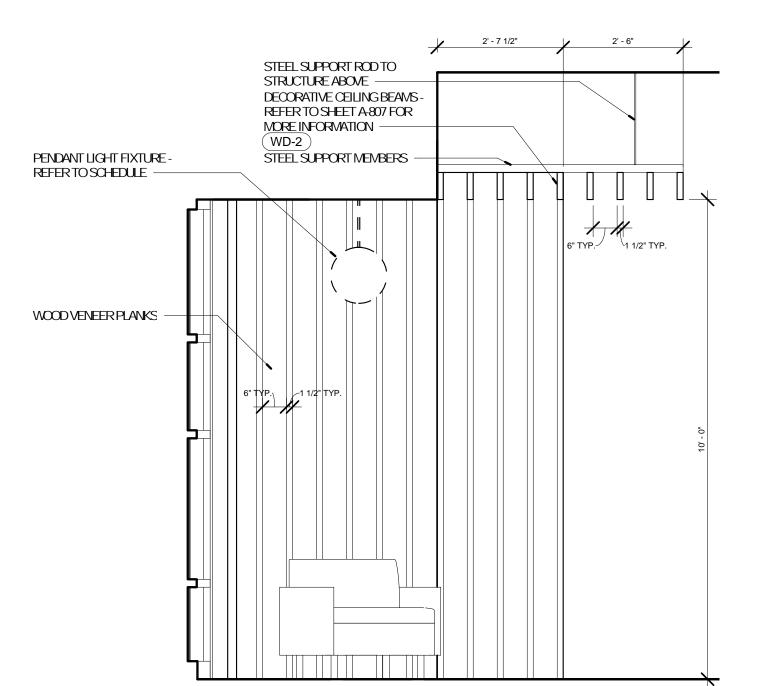
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PROJECT NUMBER: 16-1161.03


SHEET TITLE: ELEVATIONS - INTERIOR




1 ELEVATION @ COLLECTION A-603 1/2" = 1'-0"



3 ELEVATION @ CHILDREN A-603 1/2" = 1'-0"

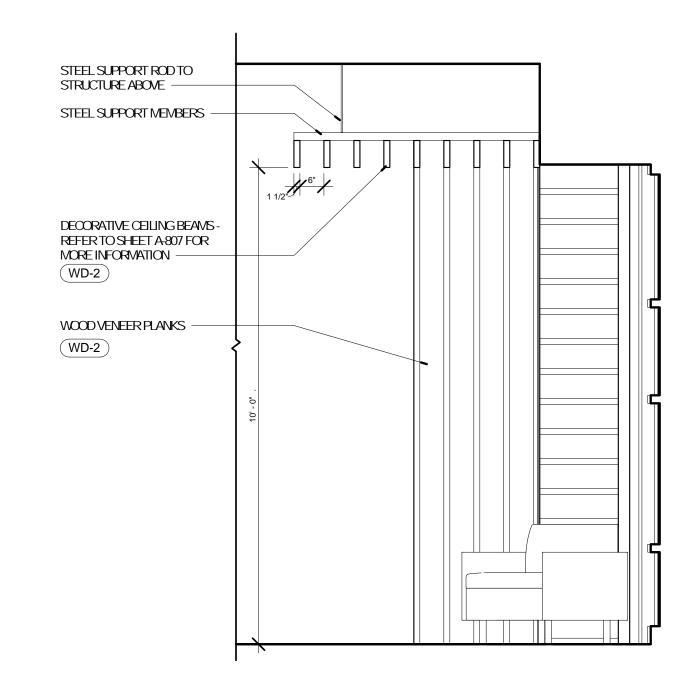

4 ELEVATION @ CHILDREN A-603 1/2" = 1'-0"

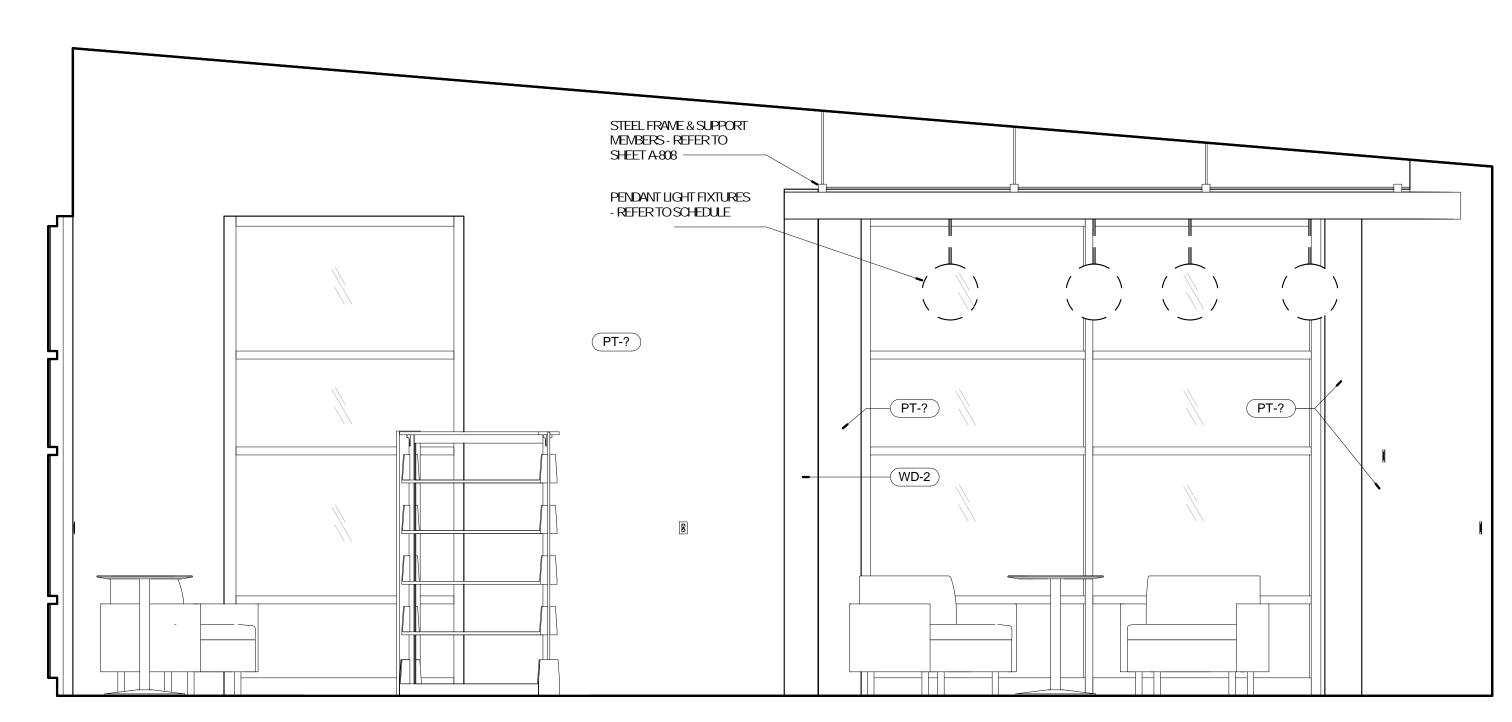

2 ELEVATION @ COLLECTION A-603 1/2" = 1'-0"

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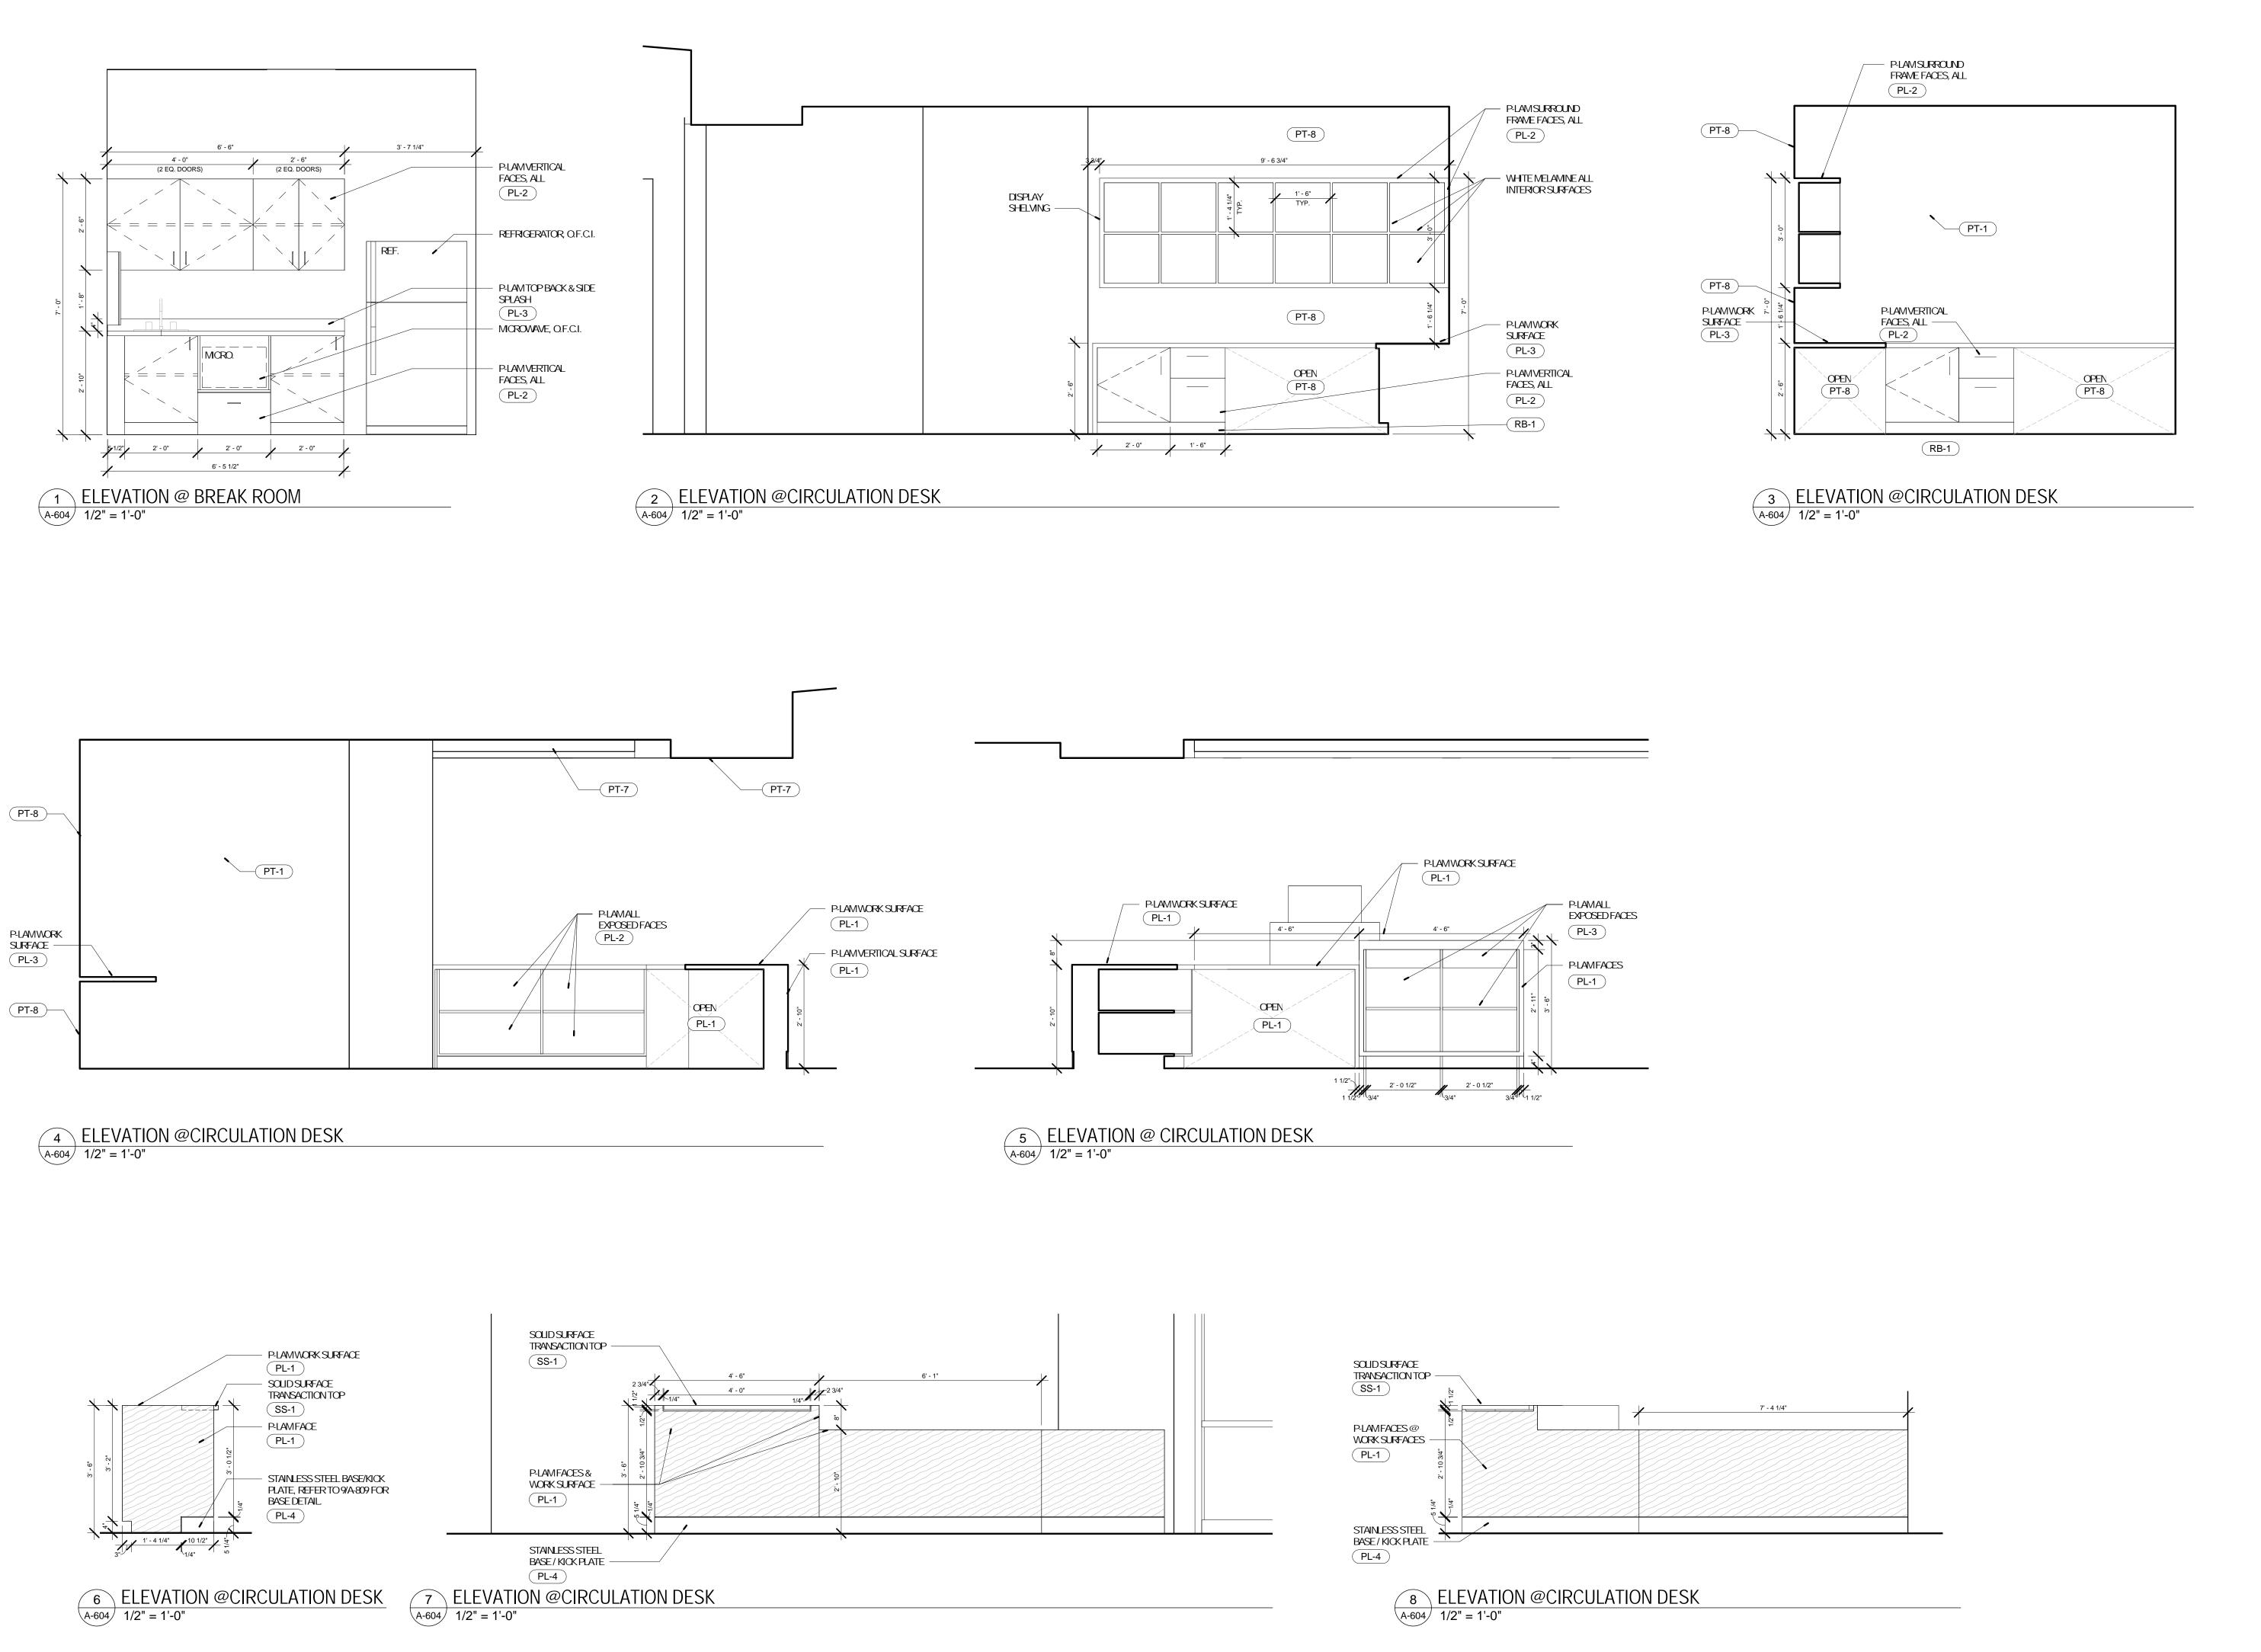
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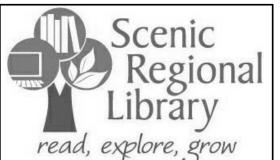
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DRAWNBY: SC/SH

PROJECT NUMBER: 16-1161.03

SHEETTITLE: ELEVATIONS - INTERIOR





read, explore, grow

REGIONAL 63390 BRANCH WRIGHT

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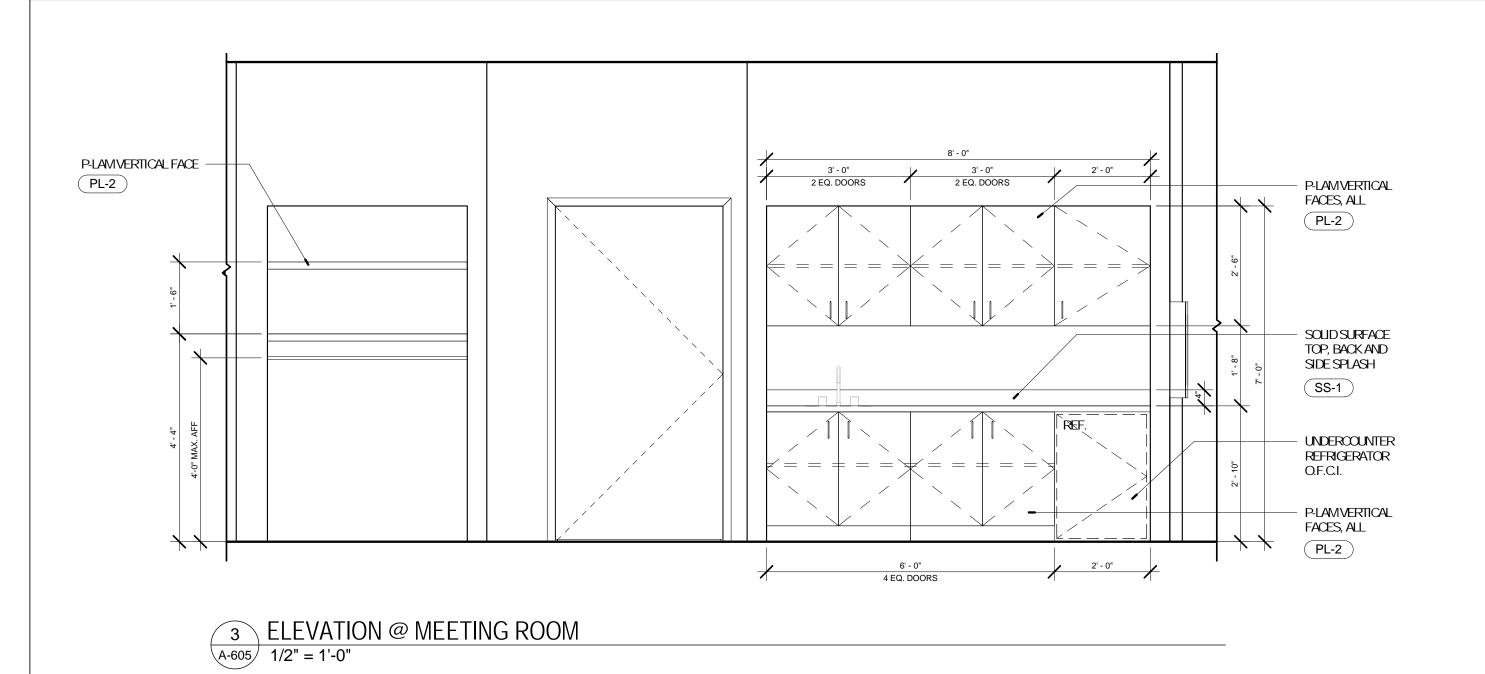
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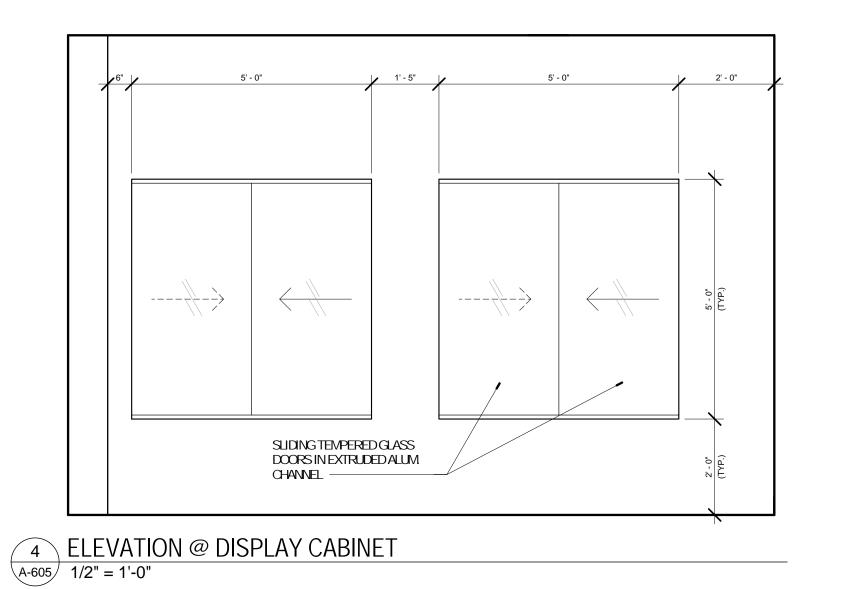
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	04/14/17	ISSUED FOR BID

DRAWNBY: SC/SH

PROJECT NUMBER: 16-1161.03

SHEETTITLE: **ELEVATIONS - INTERIOR**





PENDATUGHT FIXTURESREFER TO SCHEDUE

S-6-127


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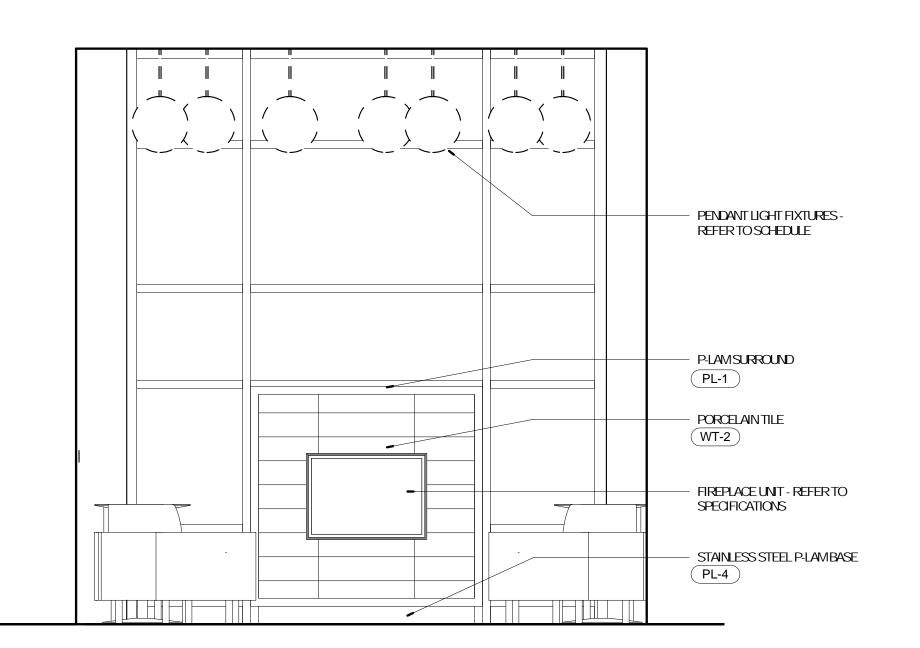
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WOODVENEER PLANS

WD-2

1 ELEVATION @ ADULTS SIDE WALL
A-605 1/2" = 1'-0"



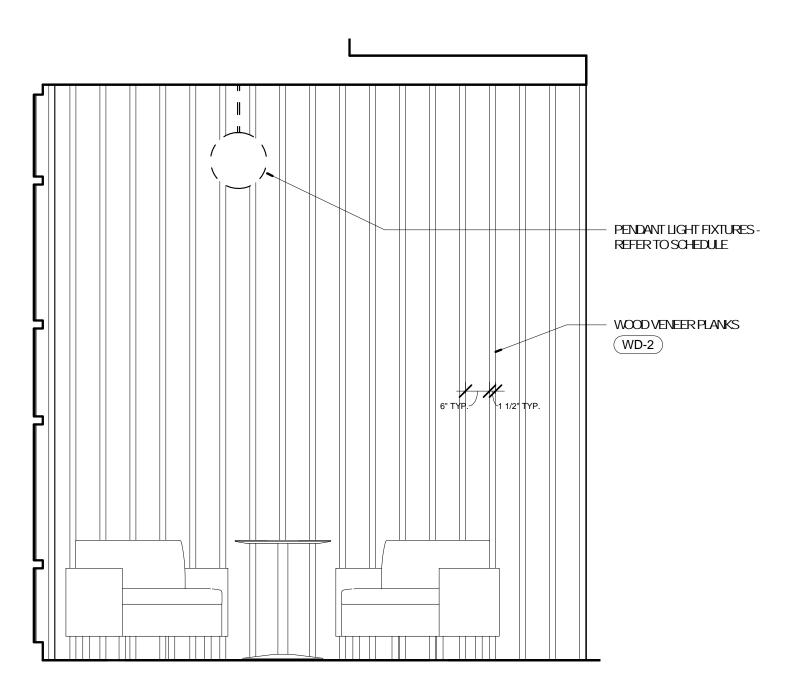

2 ELEVATION @ ADULTS SIDE WALL

A-605 1/2" = 1'-0"

5 ELEVATION @ FIREPLACE
A-605 1/2" = 1'-0"



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60 WILDCAT DRIVE
WRIGHT CITY, MO 63390



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ARCHITECT OF RECORD:

JOHNEDWARD MUELLER

MO ARCHTECTURAL LICENSE A2010039554


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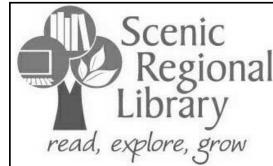
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STRUCTURAL ALPERAUD, INC. 1804 BORWAN GROLE DRIVE ST. LOUS, MO 63146 T (314) 432-8600 F (314) 807-2774 CONTACT: STEVE B-RETT

E-MAIL: STEVE.EI-PETT@ALPERAUDI.COM MECHANICAL, ELECTRICAL, PLUMBING BRIC PARTINERSHIP, LLC 343 S. KIRKWOOD ROAD, SUITE 204 KIRKWOOD, MO 63122 T (314) 725-5889 CONTACT: BRUCE COLEMAN E: BOOLEMAN@BRICPARTINERSHIP.COM

ARCHITECT OF RECORD:


JOHN EDWARD MUELLER MO ARCHITECTURAL LICENSE A2010039554 MO CERTIRICATE OF AUTHORITY A2014008380

No.	Date	Description
	04/14/17	ISSUED FOR BID

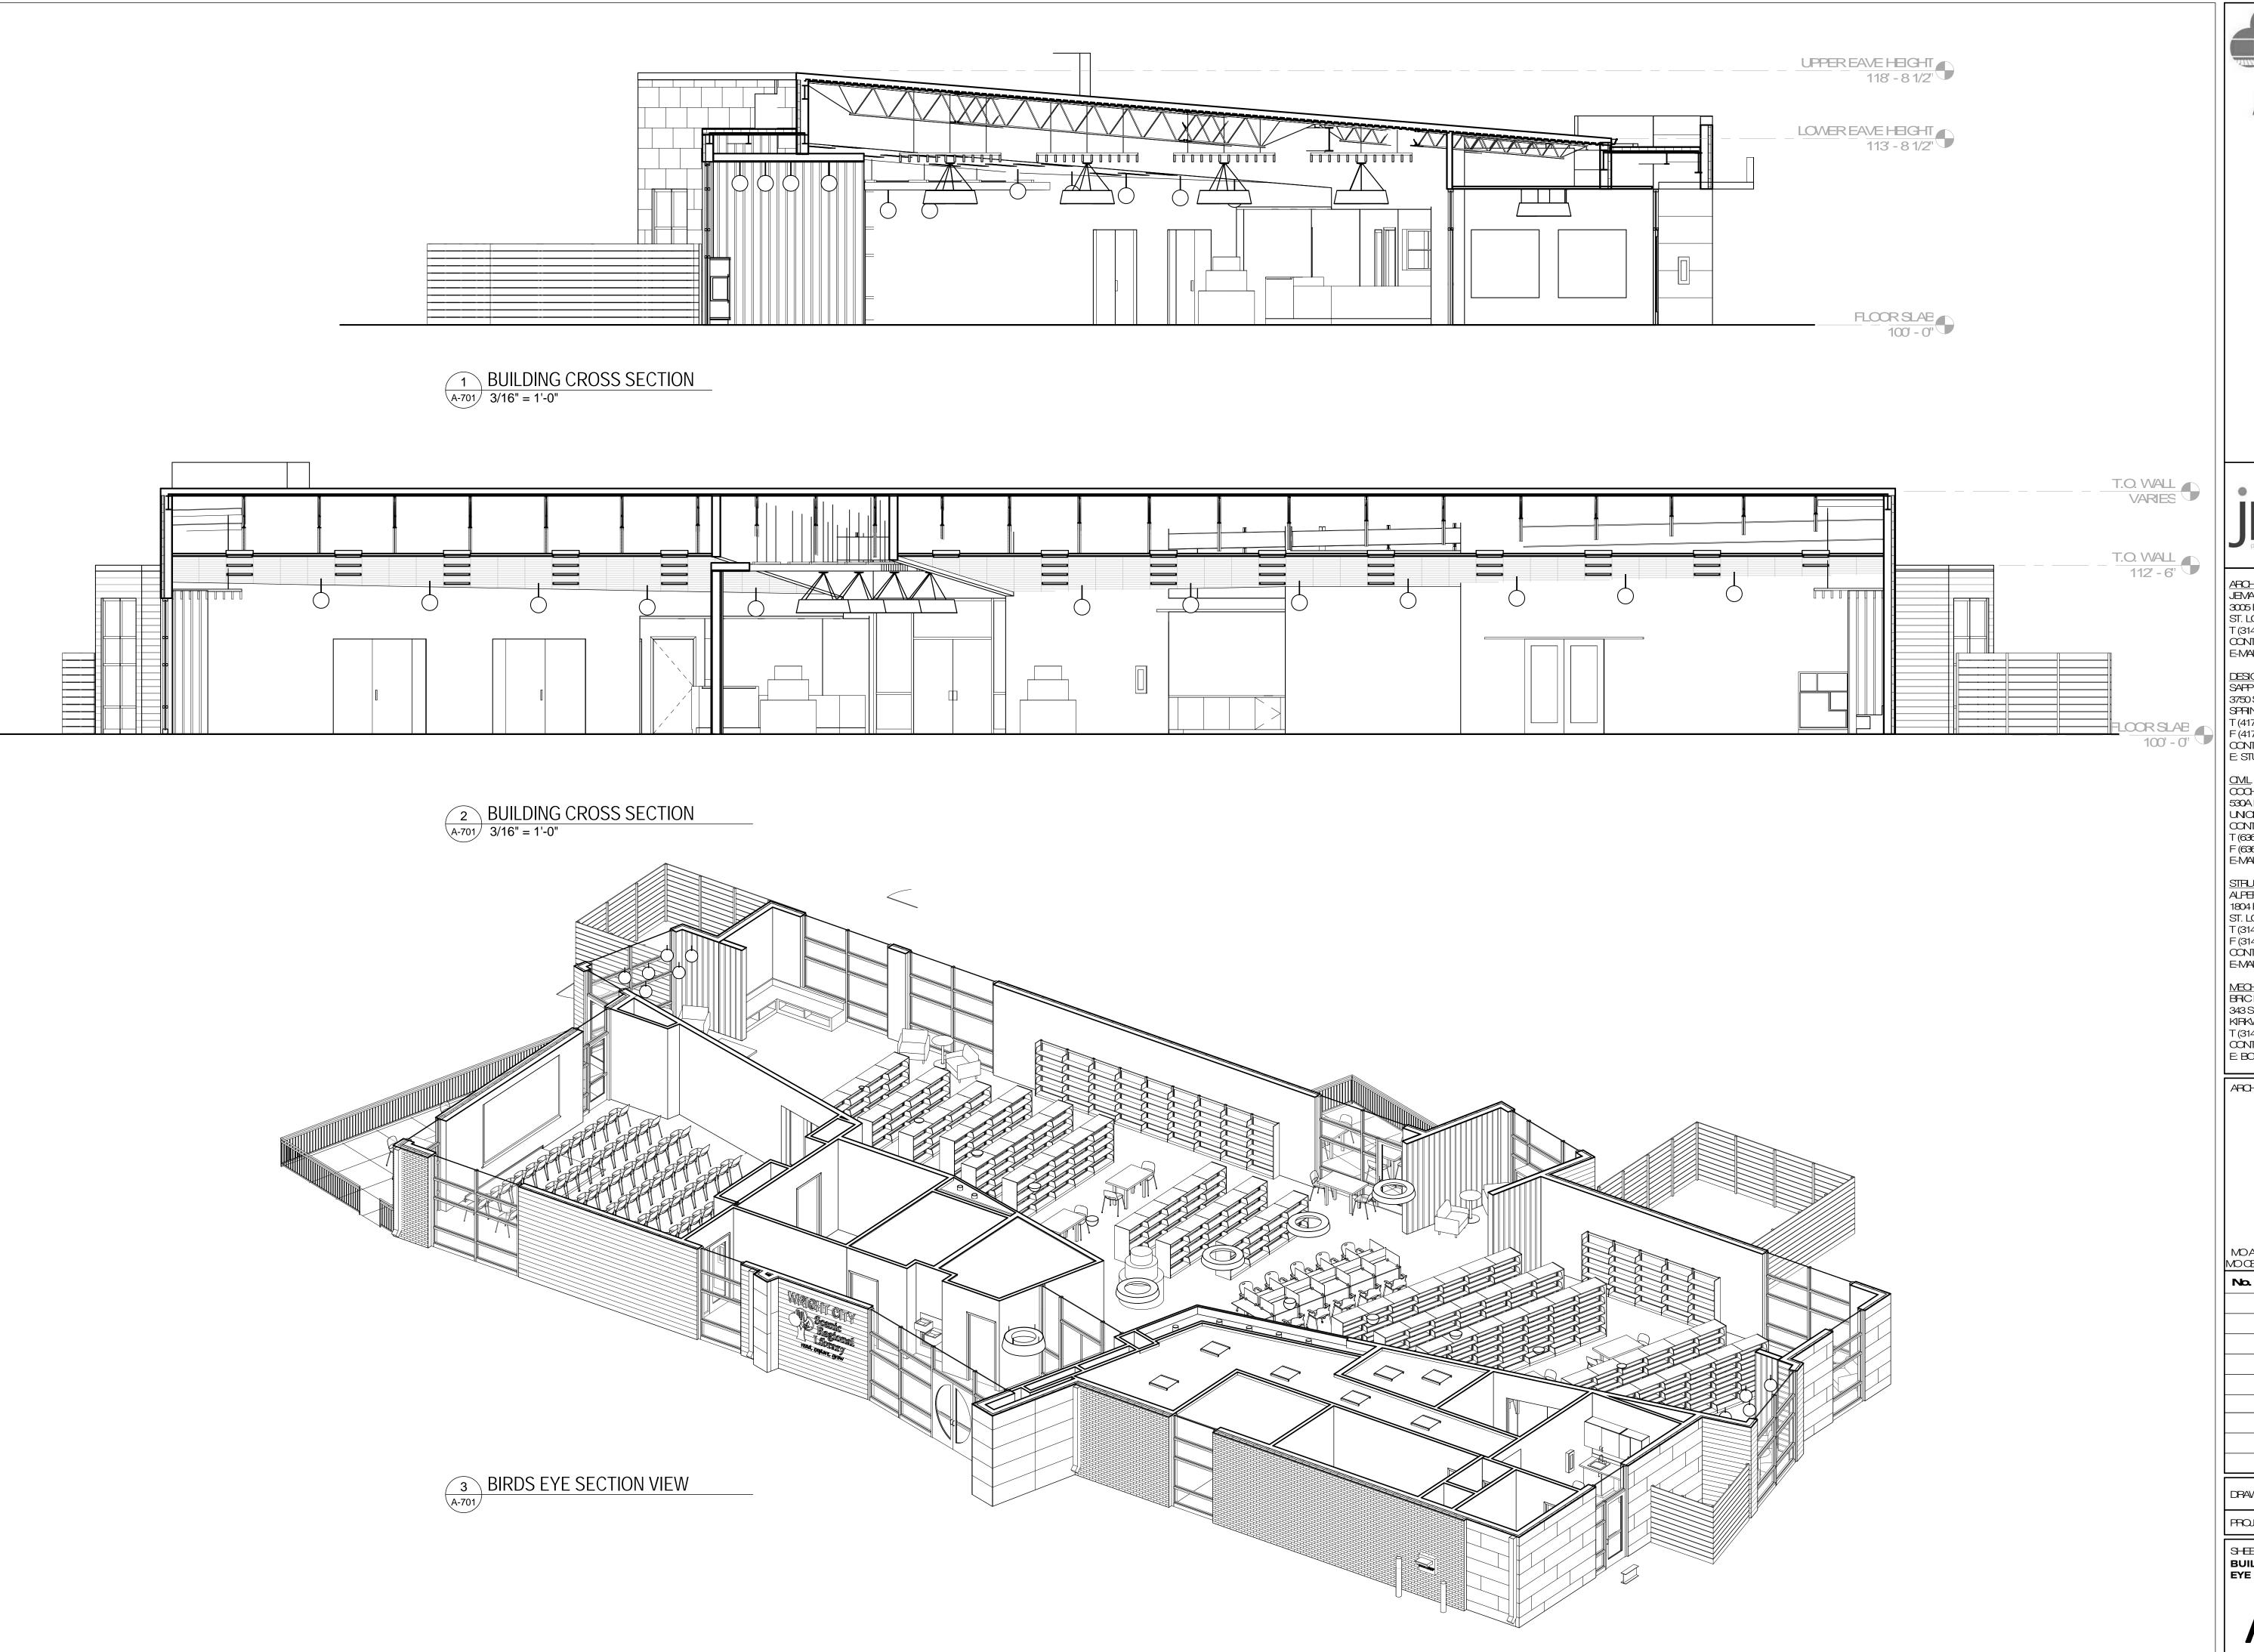
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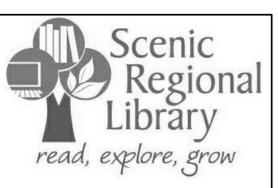
PROJECT NUMBER: 16-1161.03

SHEETTITLE:
BUILDING SECTIONS & BIRDS
EYE SECTION VIEW

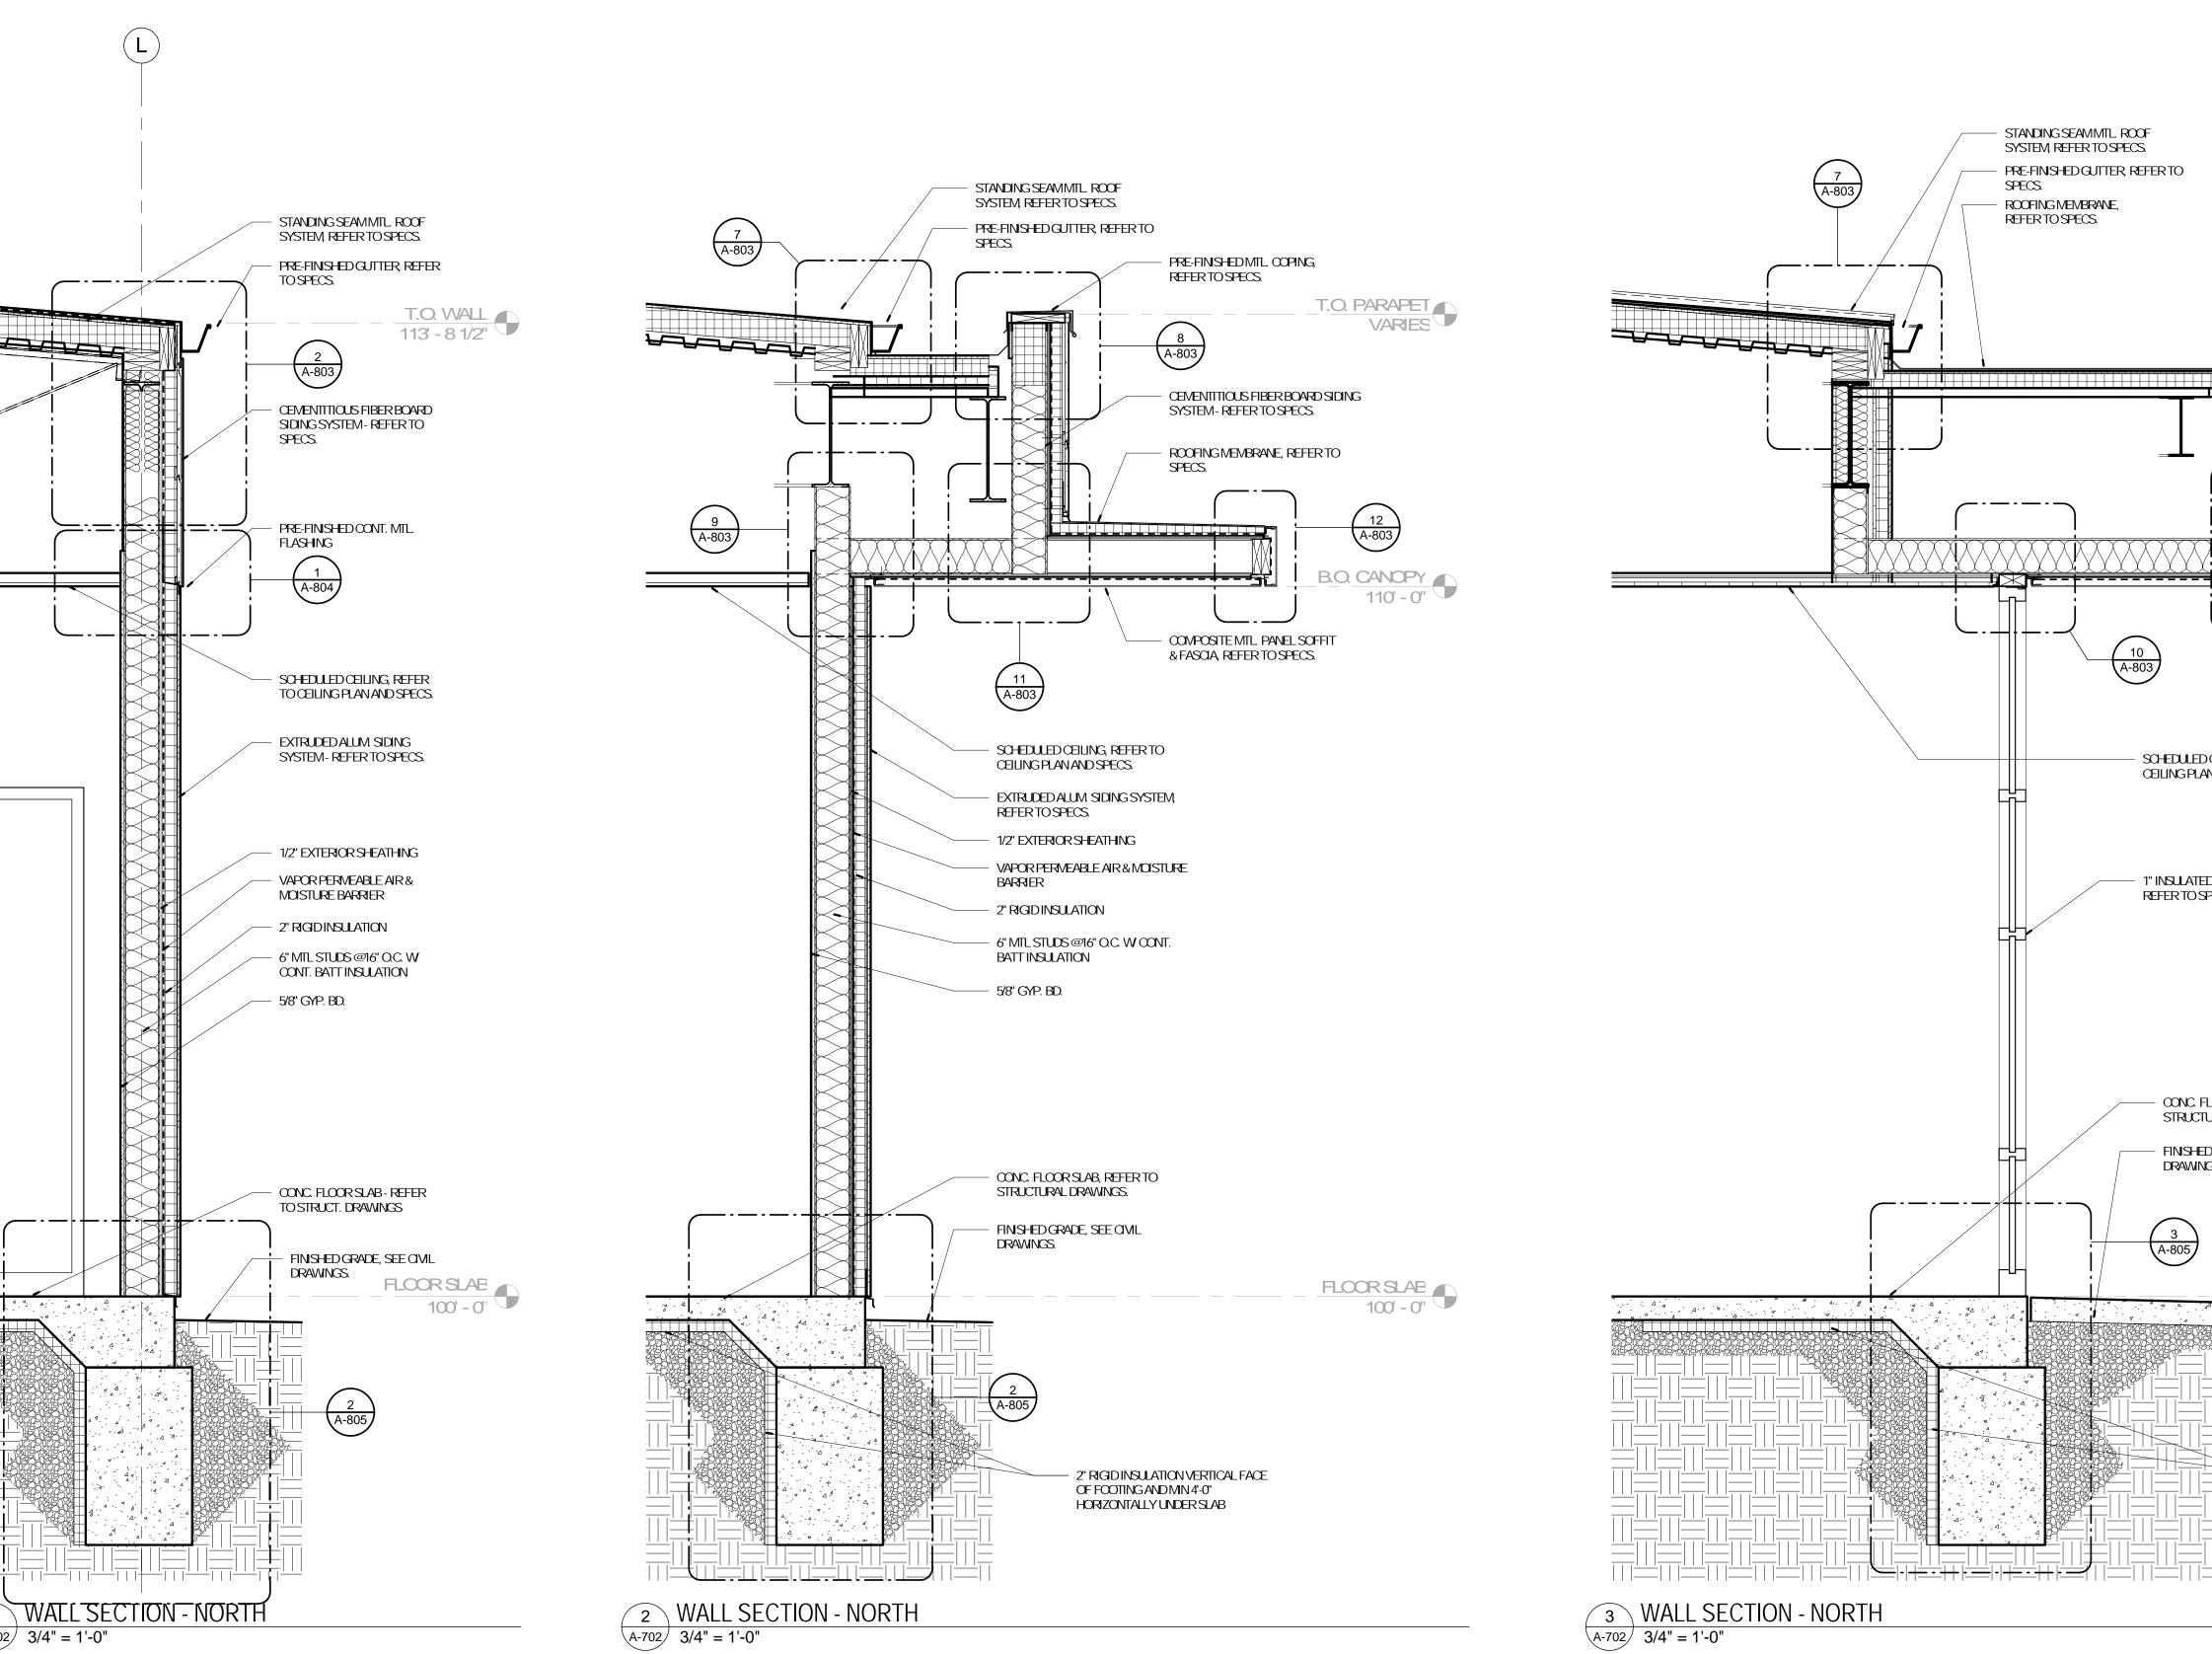

A-702 3/4" = 1'-0"



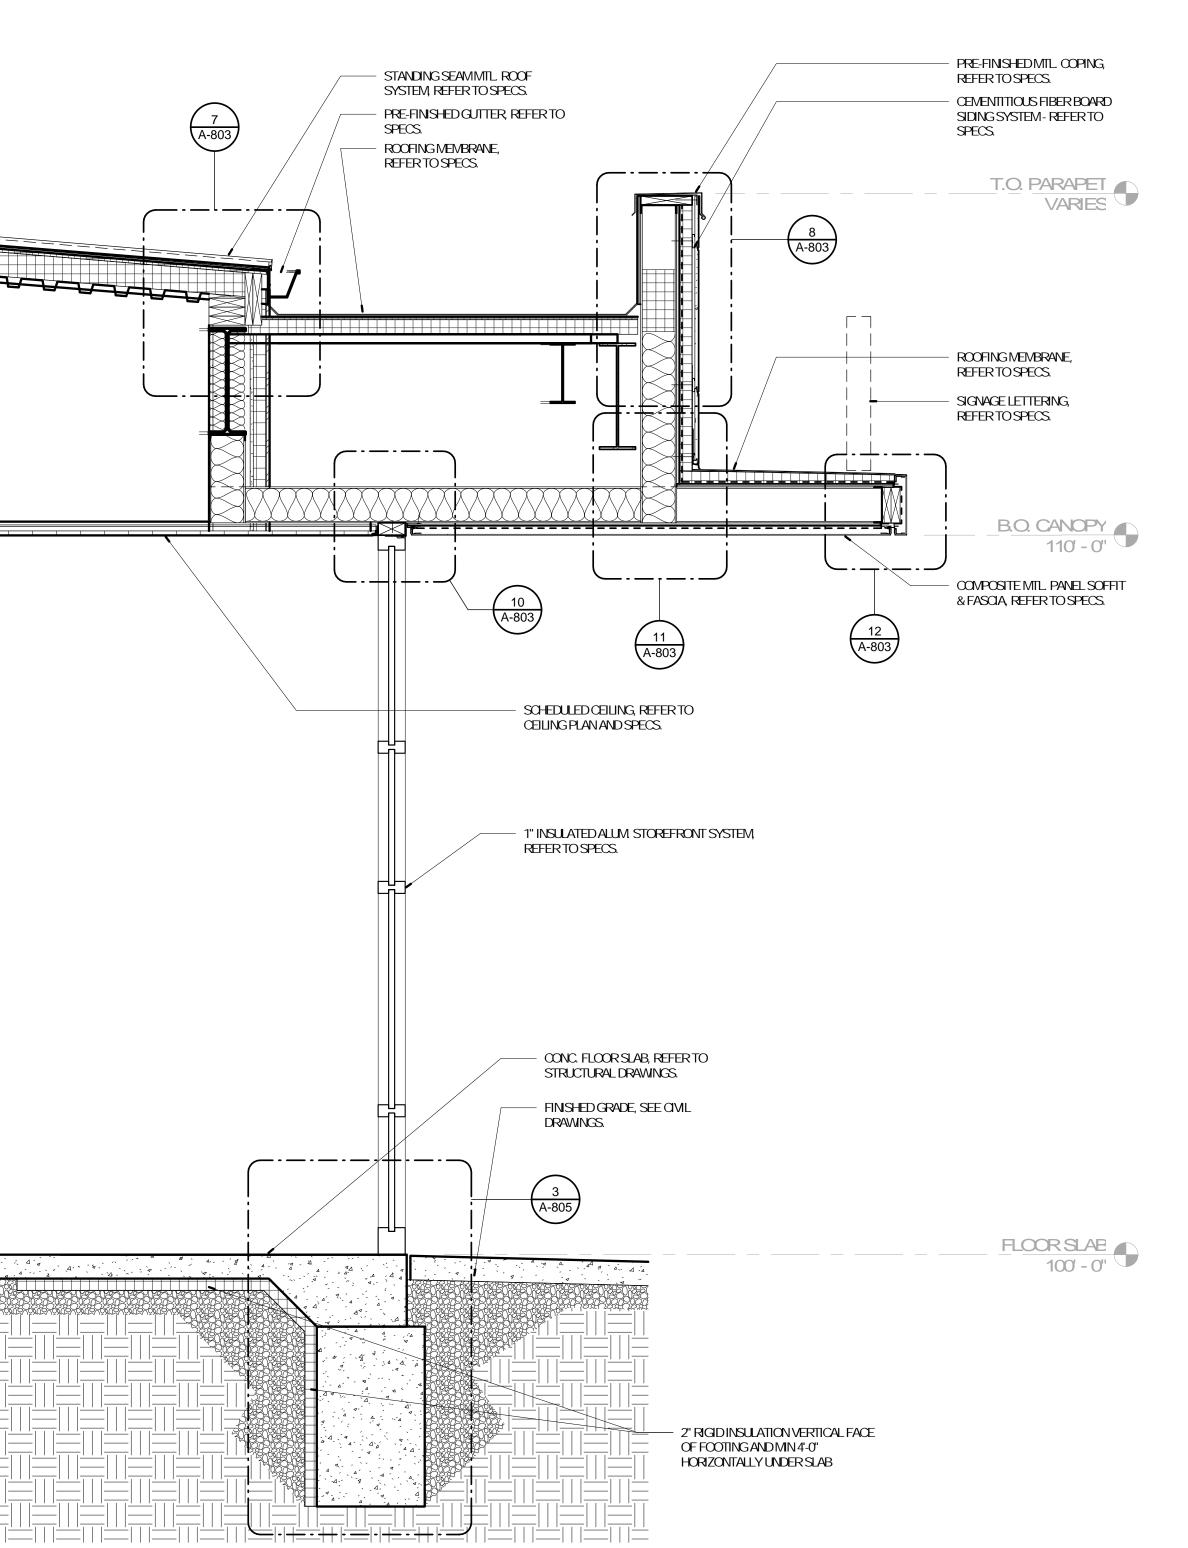

ARCHITECT-OF-RECORD

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E-MAIL: STEVE.B-RETT@ALPERAUDI.COM MECHANICAL, ELECTRICAL, PLUMBING BRIC PARTINERSHP, LLC 343 S. KIRKWOOD ROAD, SUITE 204 KIRKWOOD, M063122 T (314) 725-5889 CONTACT: BRUCE COLEMAN
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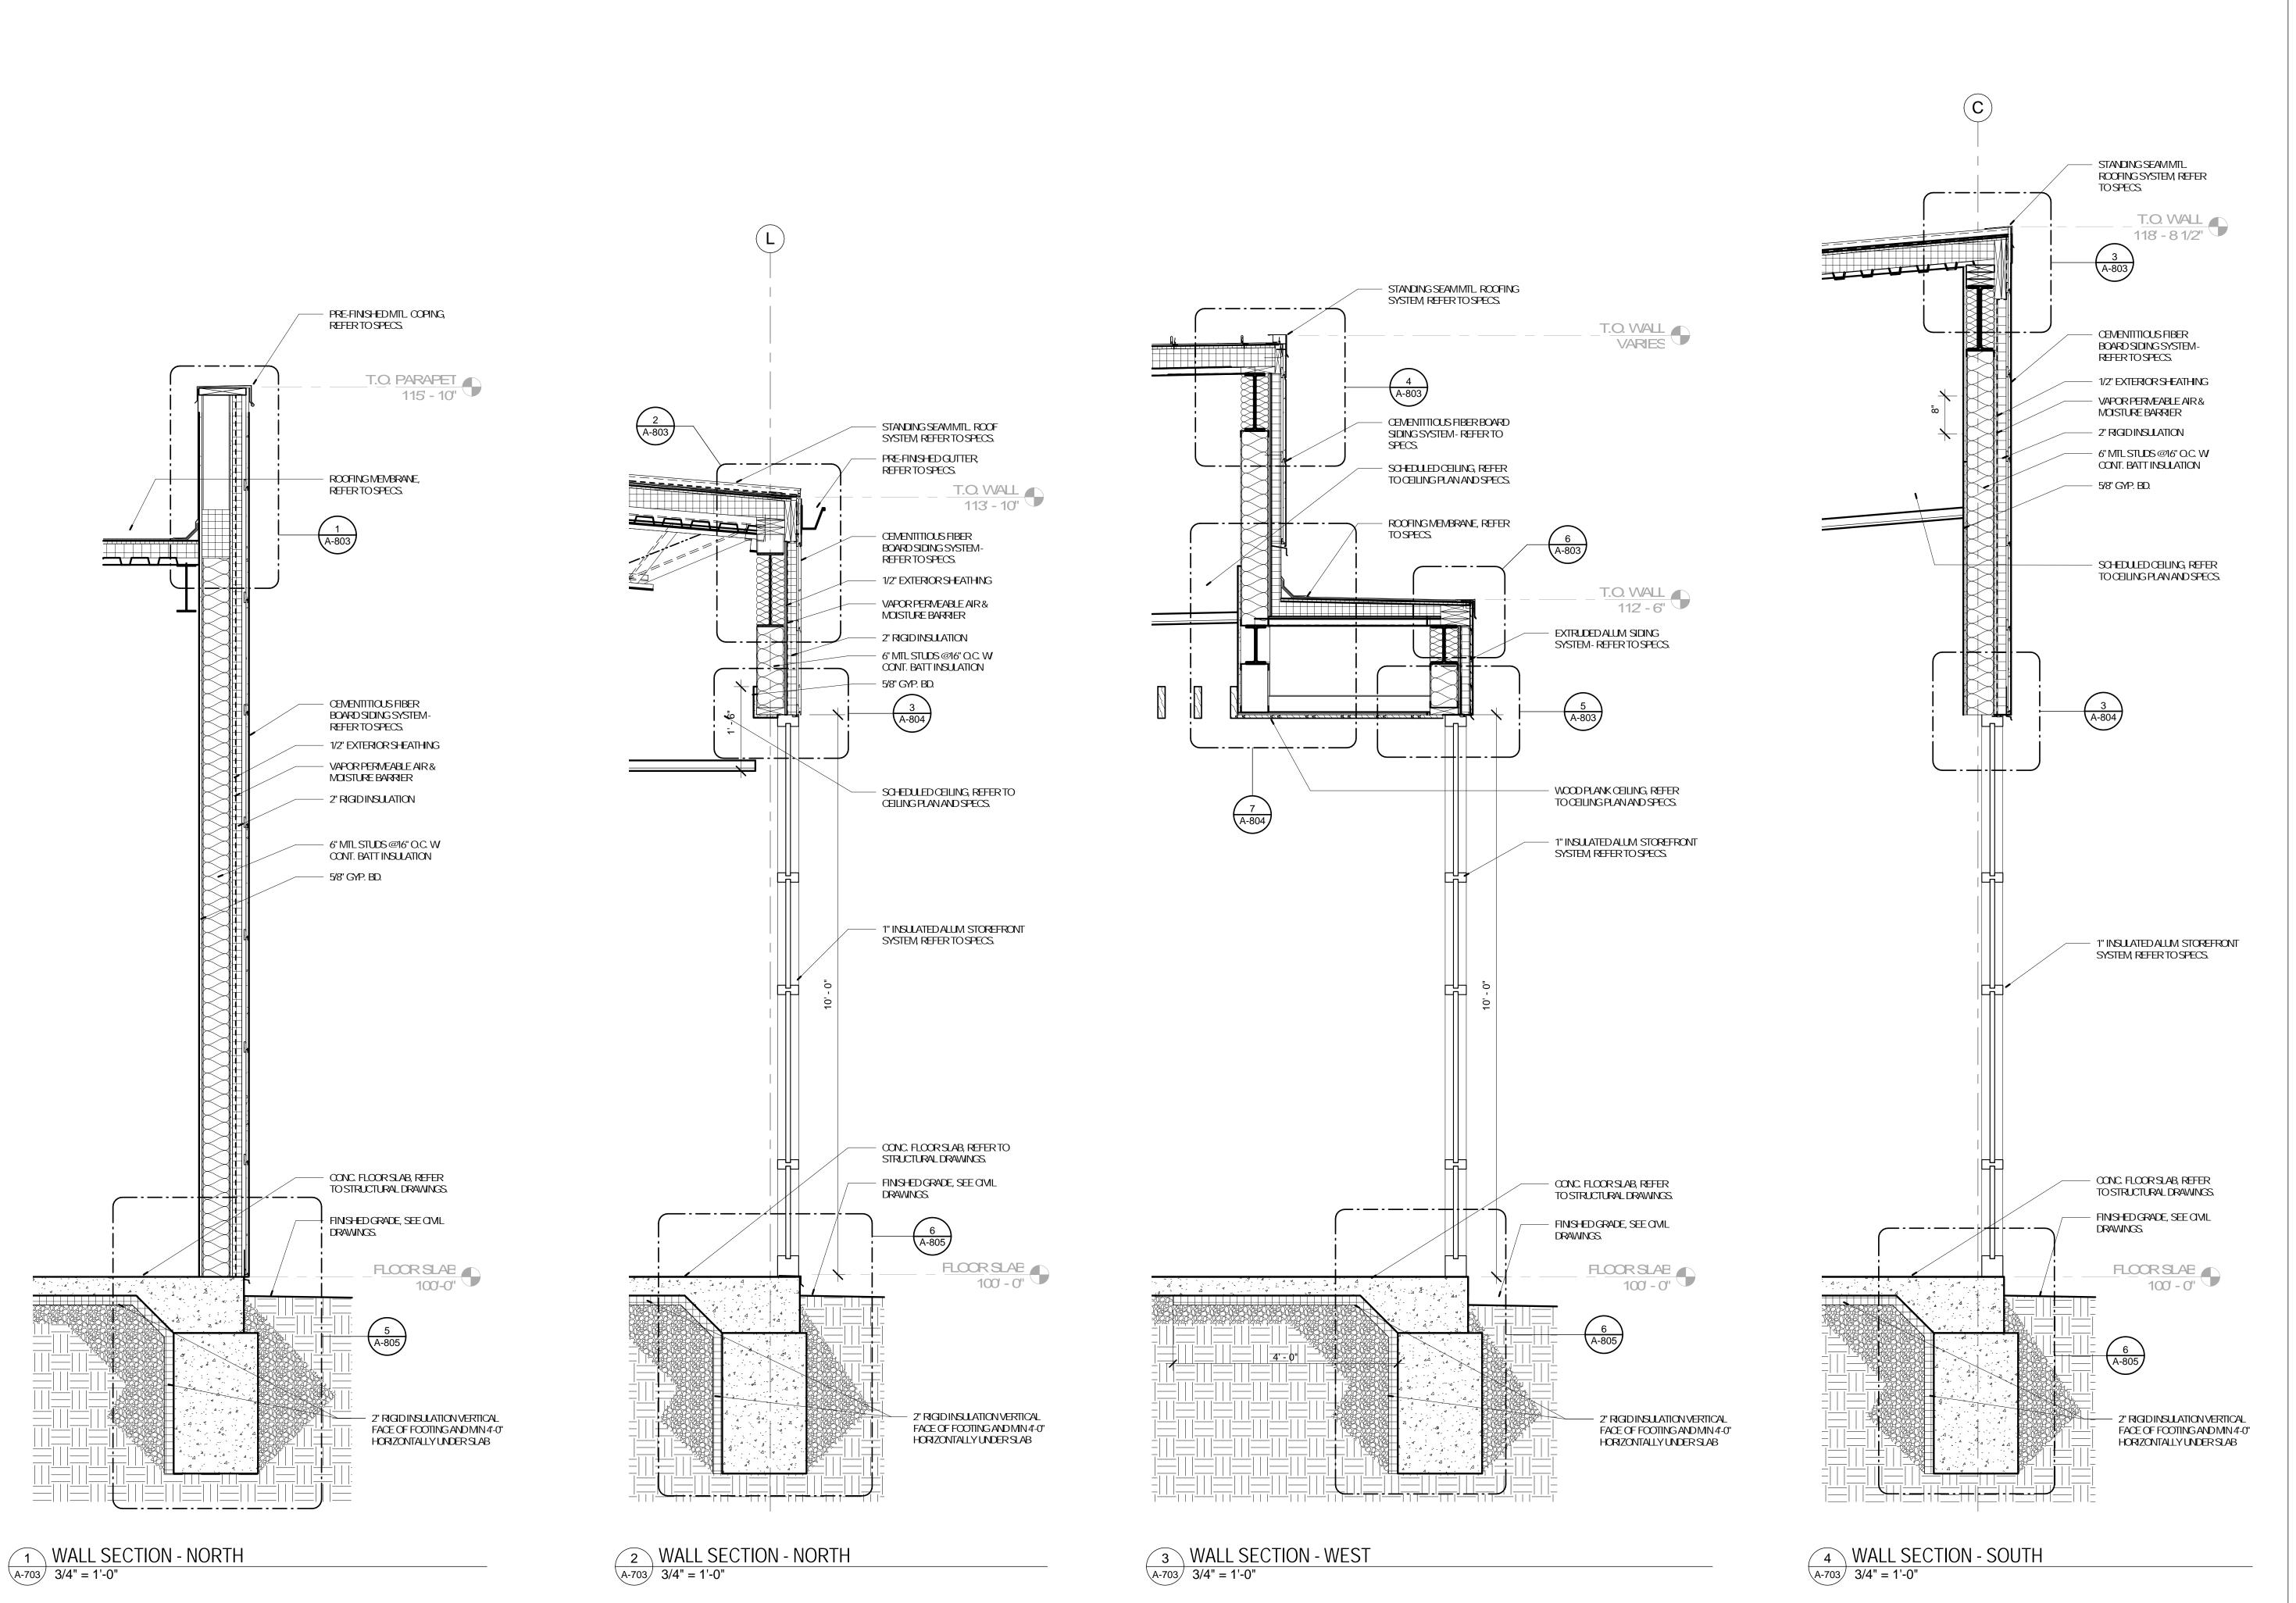
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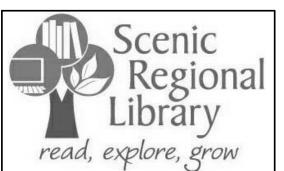
No.	Date	Description
	04/14/17	ISSUED FOR BID

DRAWNBY: SC/SH

PROJECT NUMBER: 16-1161.03

SHEETTITLE: WALL SECTIONS





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No. Date


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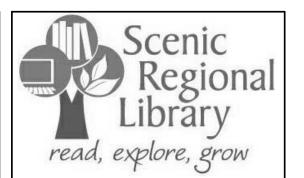
Description

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DRAWNBY: SC/SH
PROJECT NUMBER: 16-1161.03

SHEETTITLE:
WALL SECTIONS



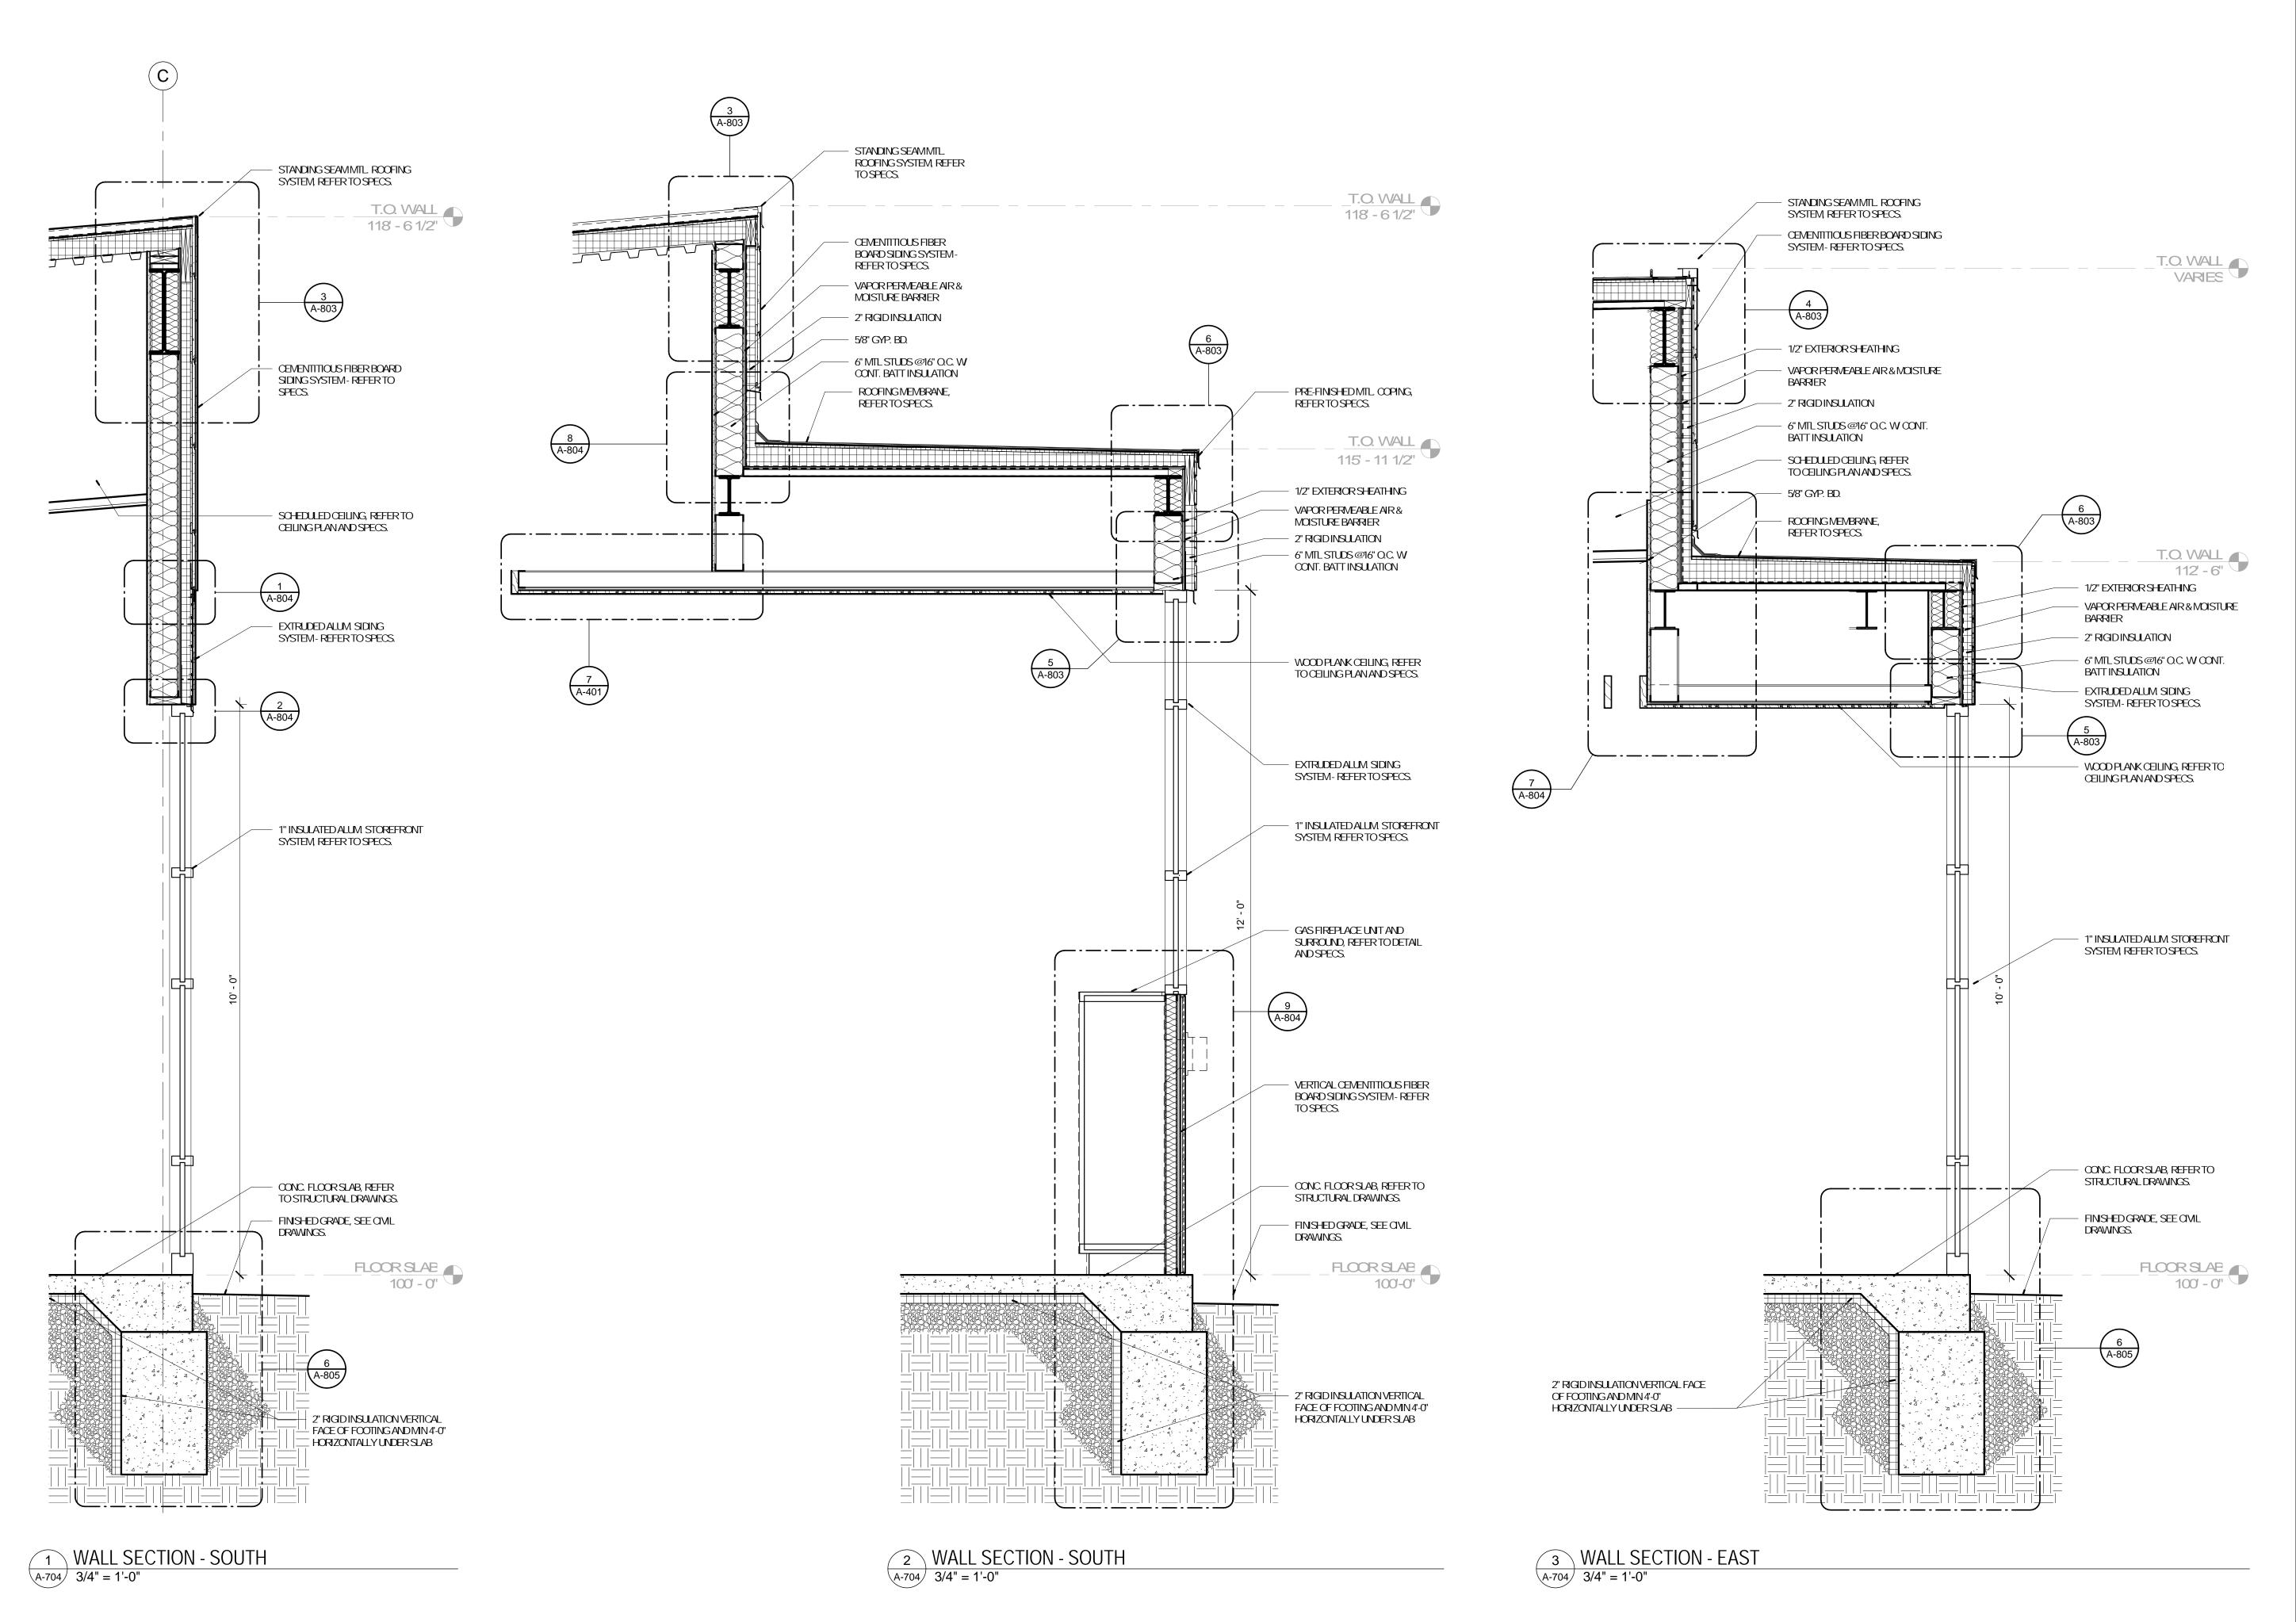

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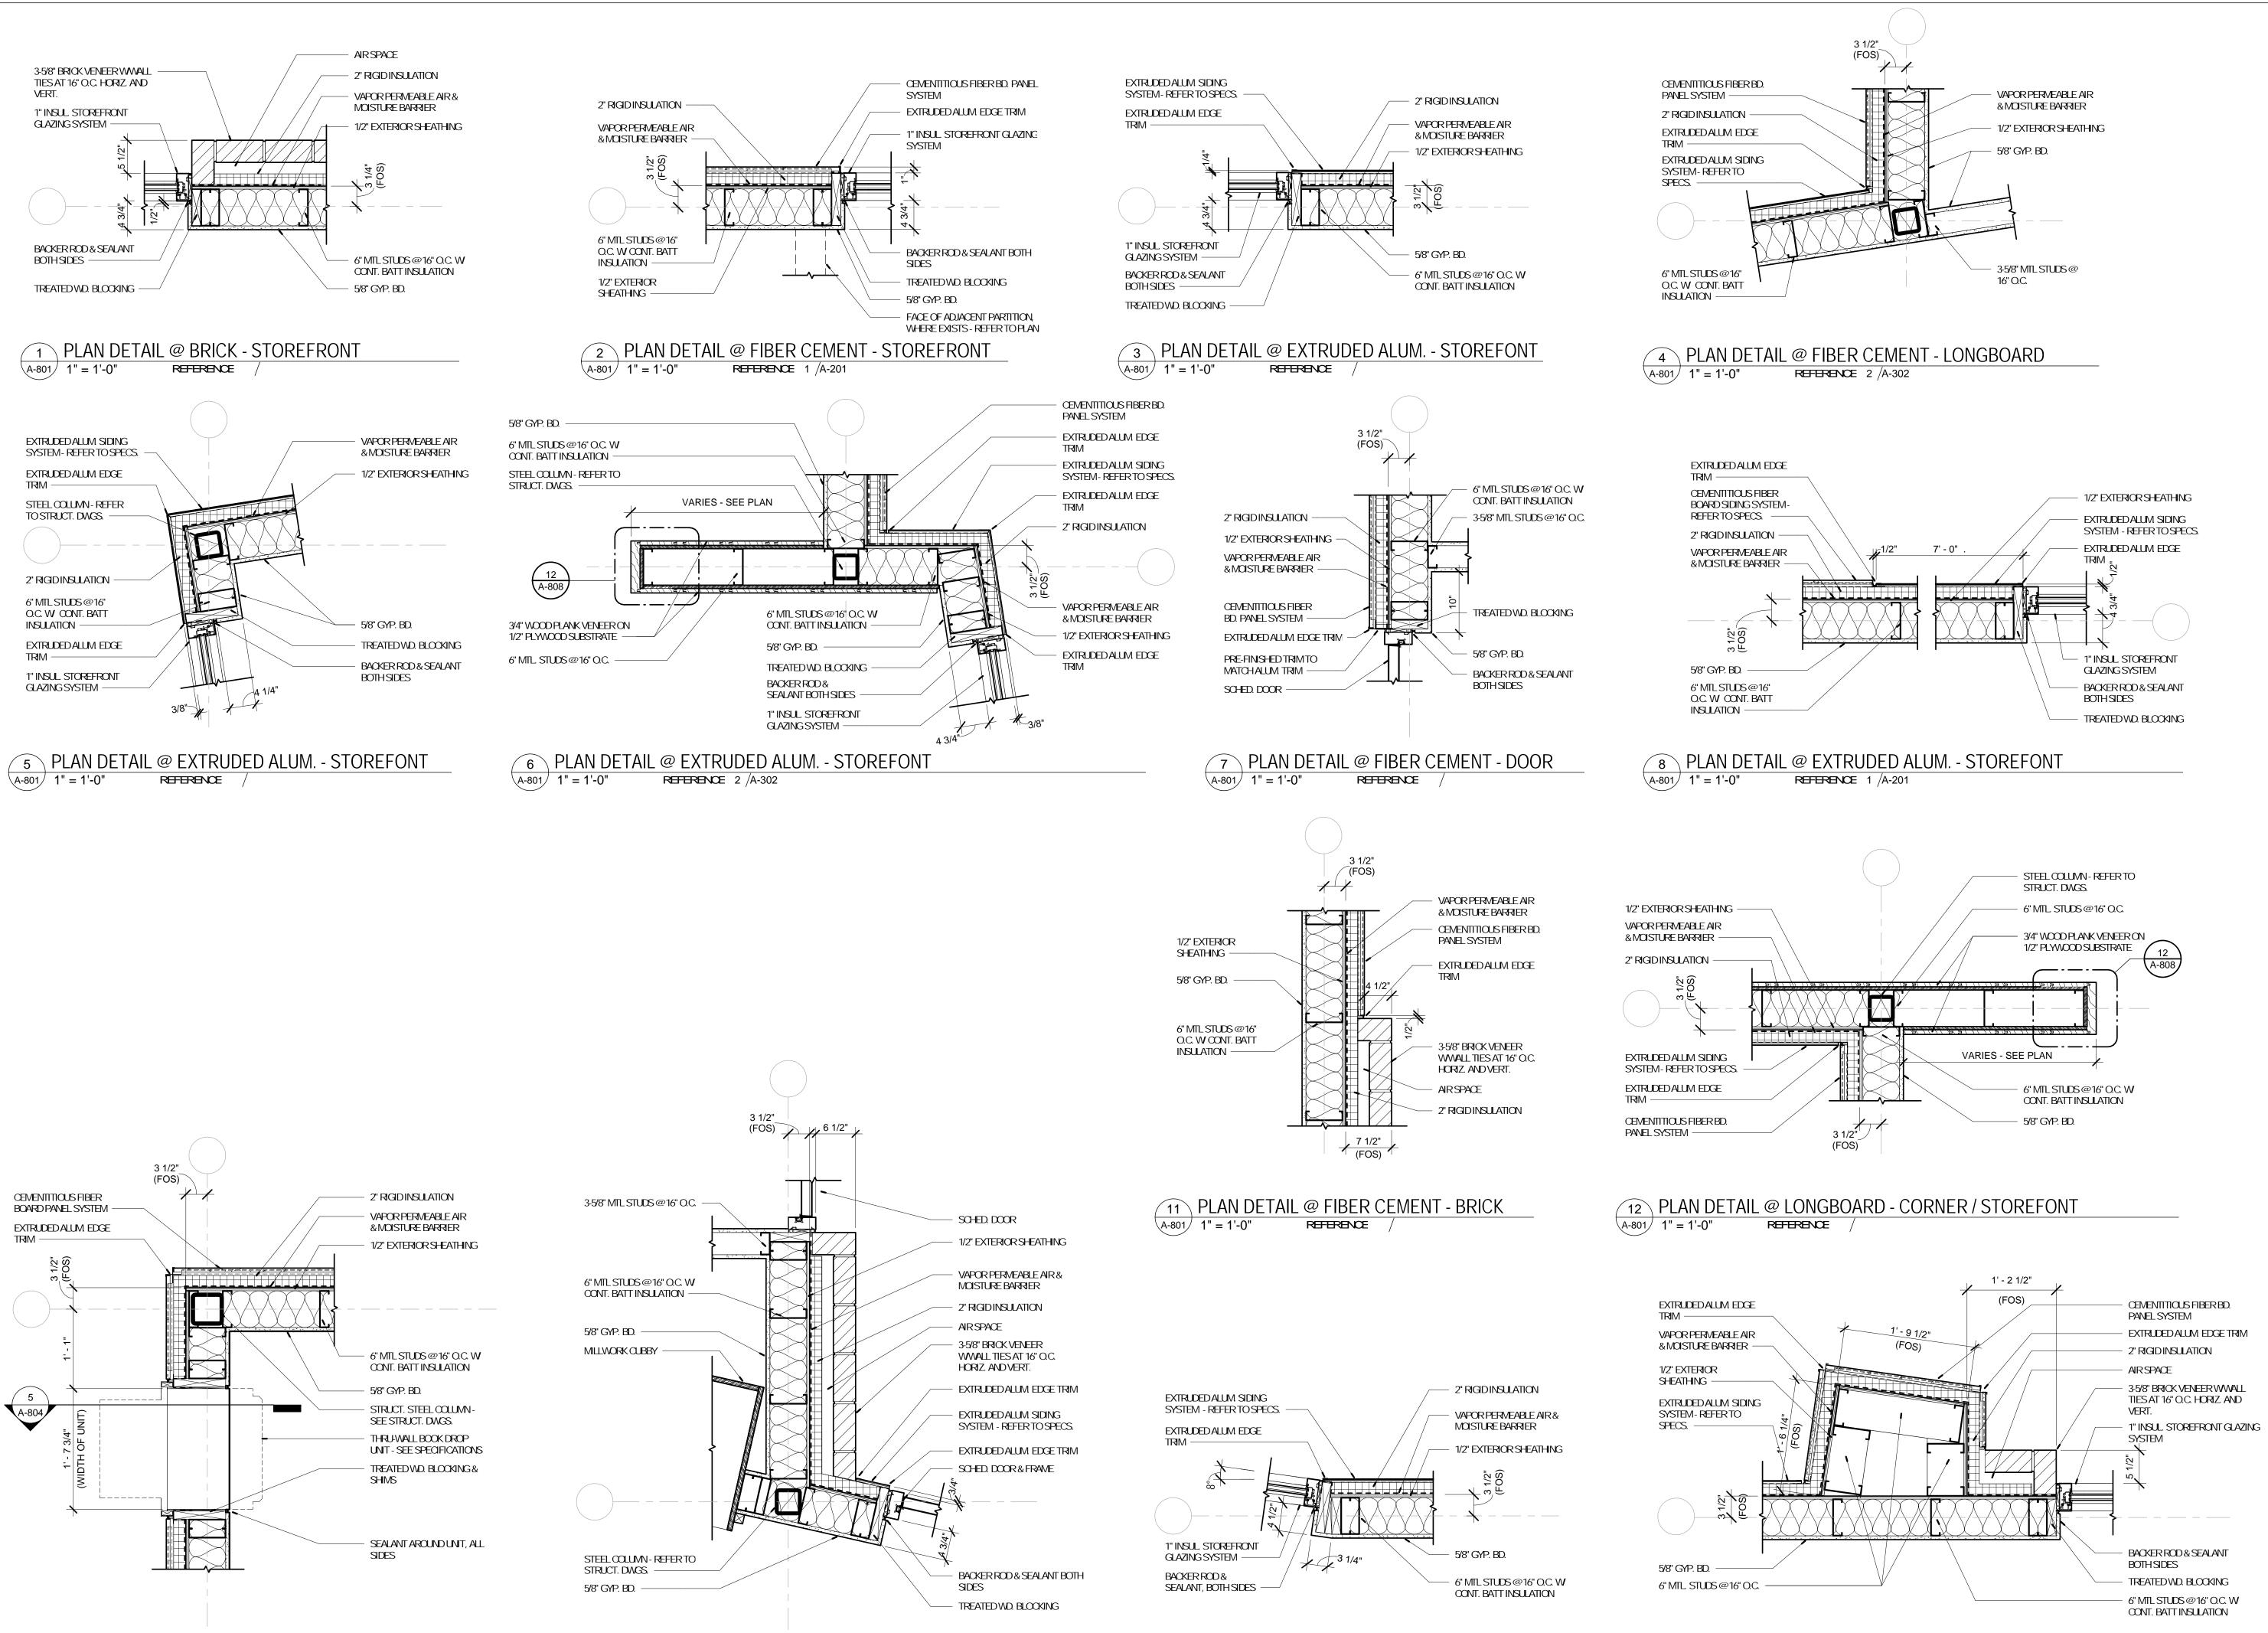
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MO ARCHTECTURAL LICENSE A2010039554
MO CERTIFICATE OF AUTHORITY A2014008380

No.	Date	Description
	04/14/17	ISSUED FOR BID

DRAWNBY: SC/SH

PROJECT NUMBER 16-1161.03

SHEETTITLE:
WALL SECTIONS



15 PLAN DETAIL @ EXTRUDED ALUM. - STOREFONT

14 PLAN DETAIL @ EXTRUDED ALUM. - STOREFONT

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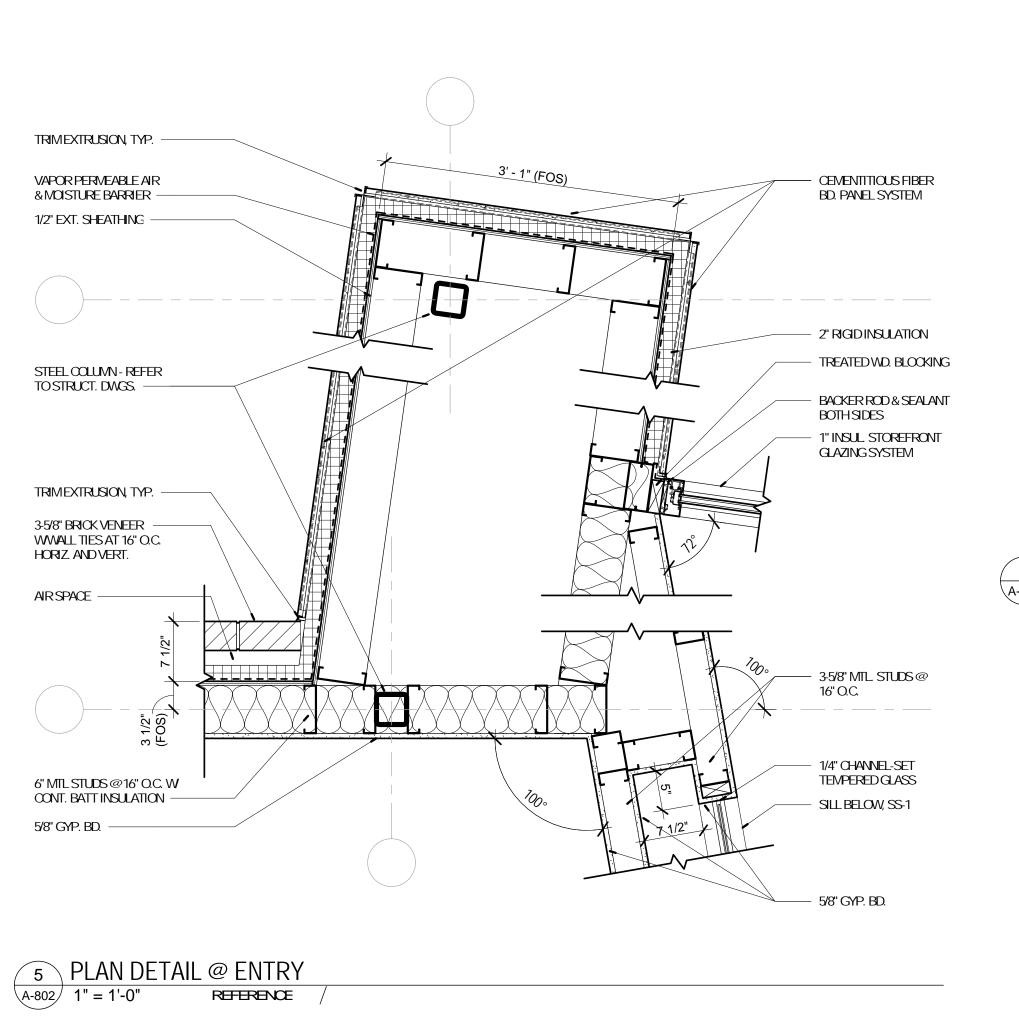
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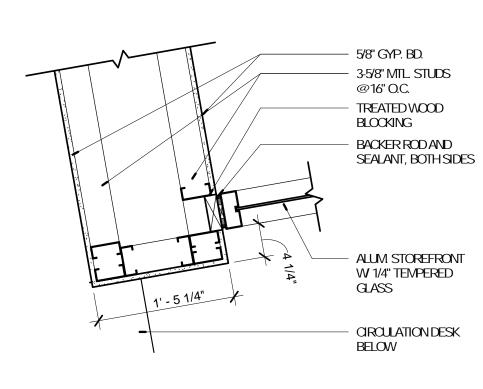
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DETAILS - PLAN


16 PLAN DETAIL @ BRICK - FIBER CEMENT - STOREFRONT






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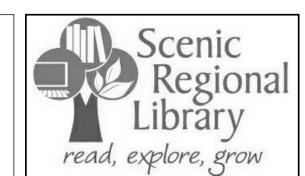
3 PLAN DETAIL

A-802 1" = 1'-0" REFERENCE /

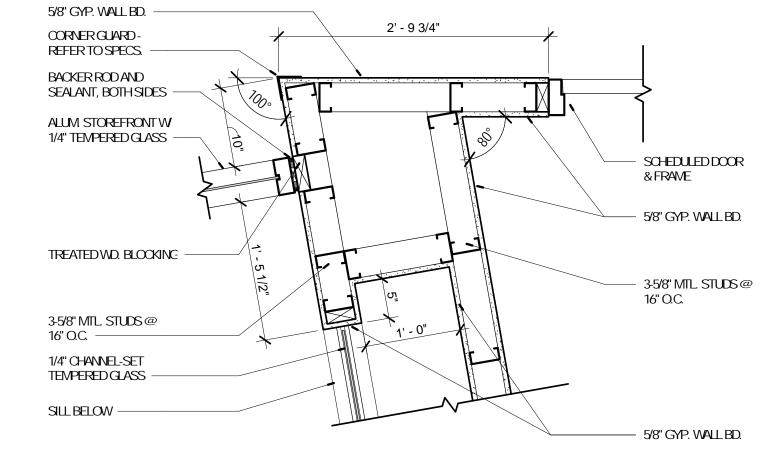

4 PLAN DETAIL

A-802 1" = 1'-0" REFERENCE /

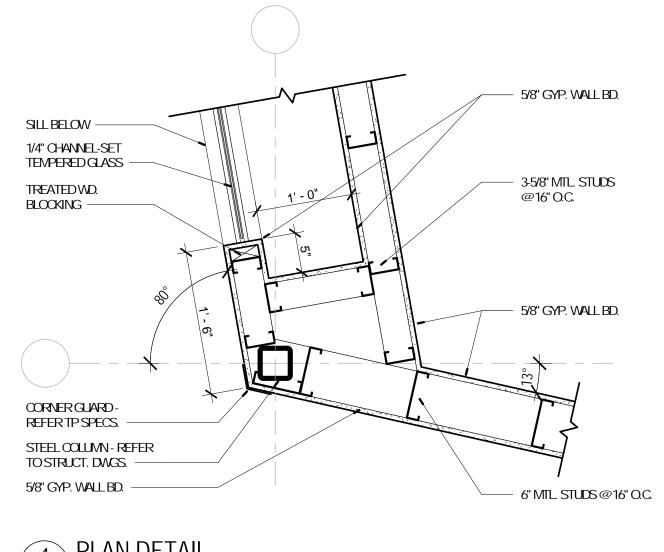

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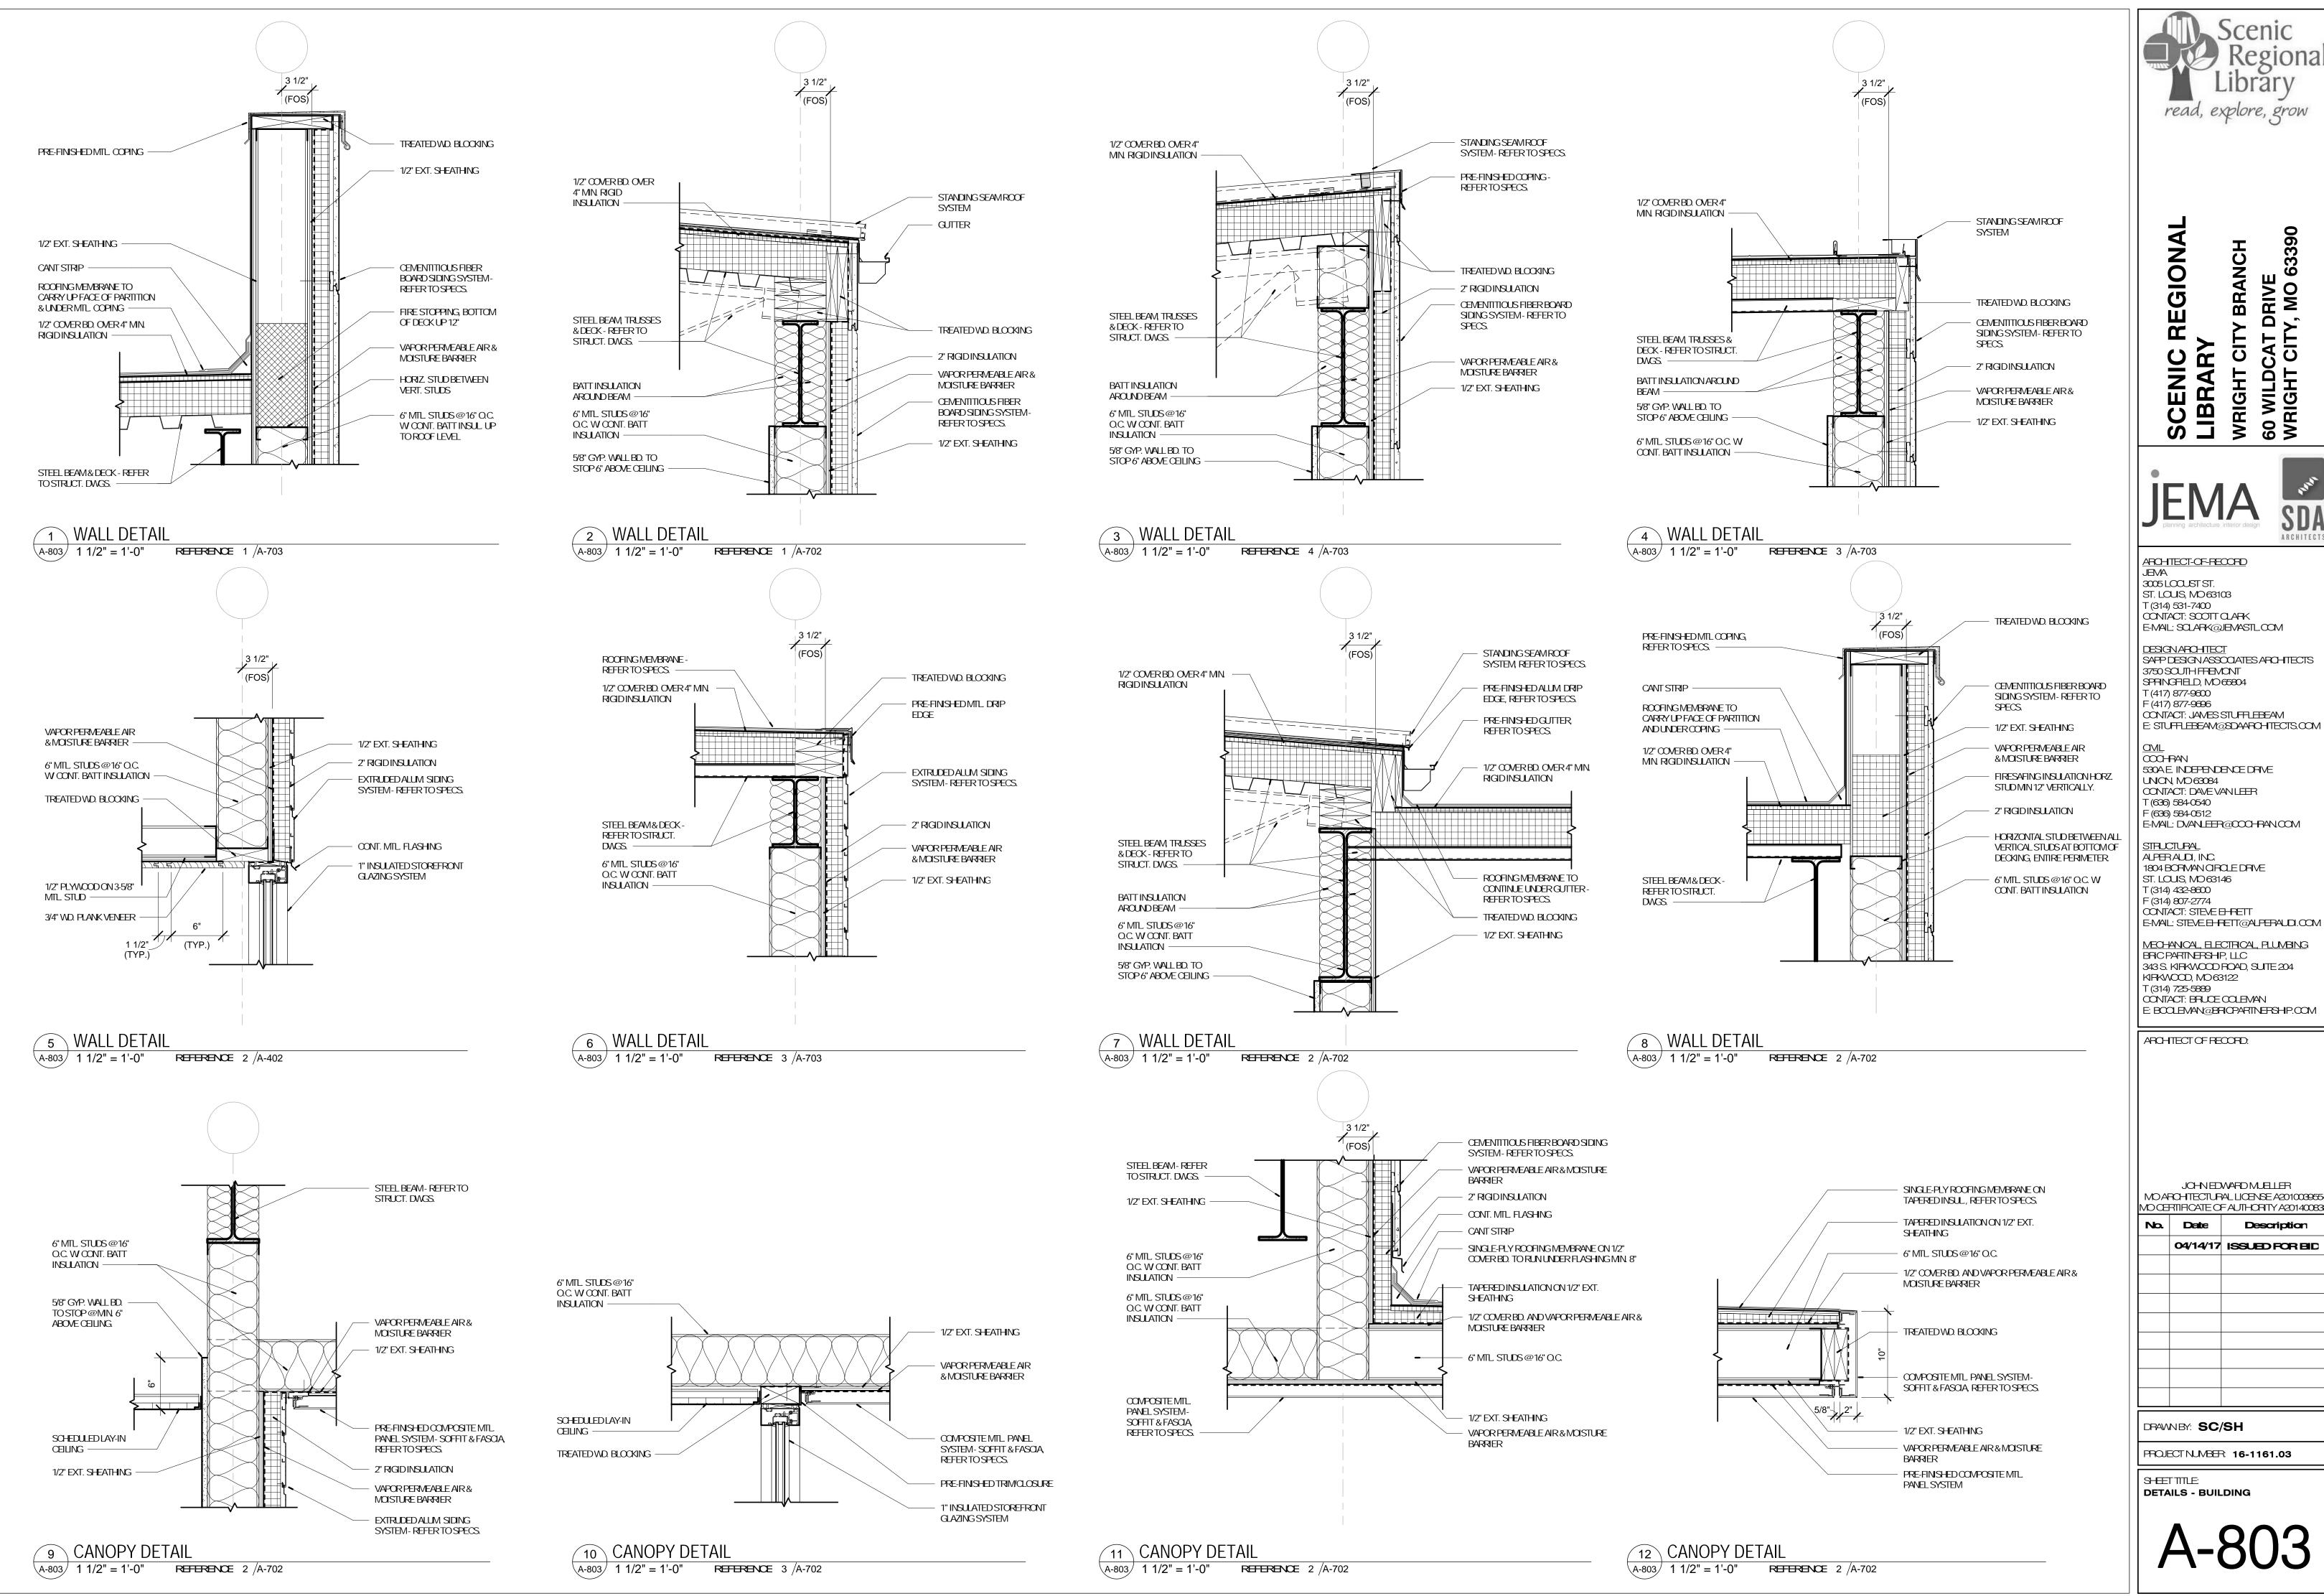
No.	Date	Description
	04/14/17	ISSUED FOR BID

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PROJECTNUMBER: 16-1161.03

SHEETTITLE:

DETAILS - PLAN






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MECHANICAL, ELECTRICAL, PLUMBING

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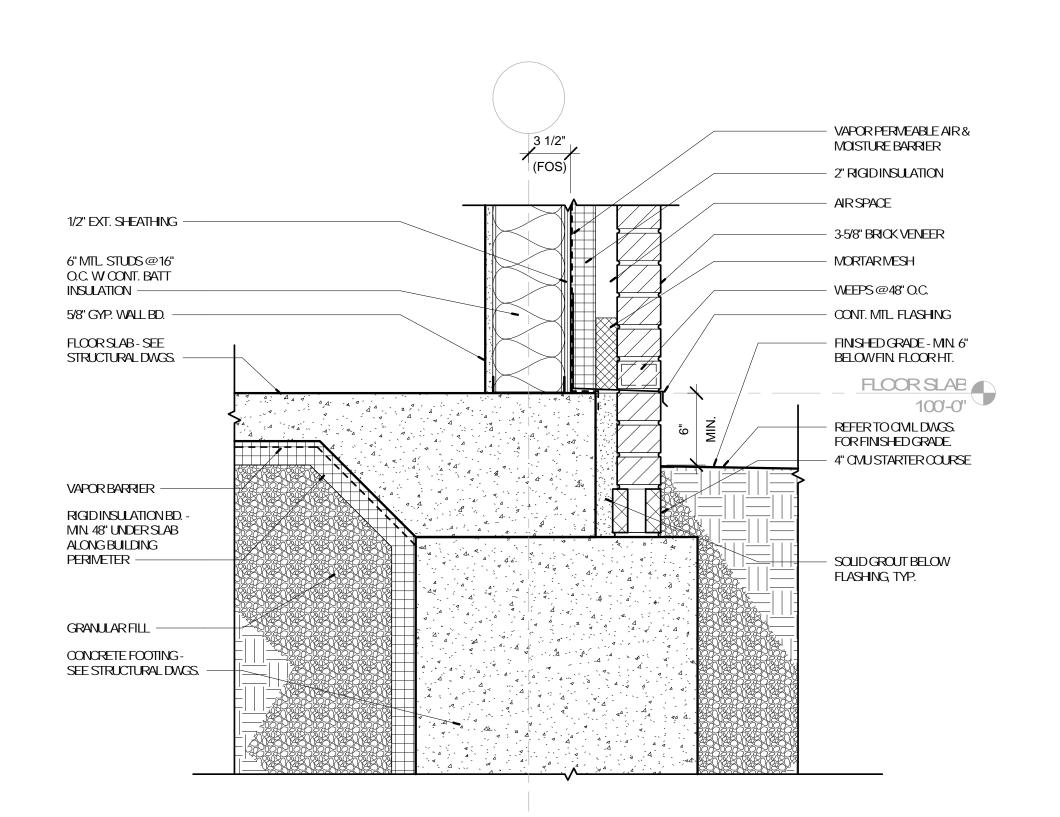
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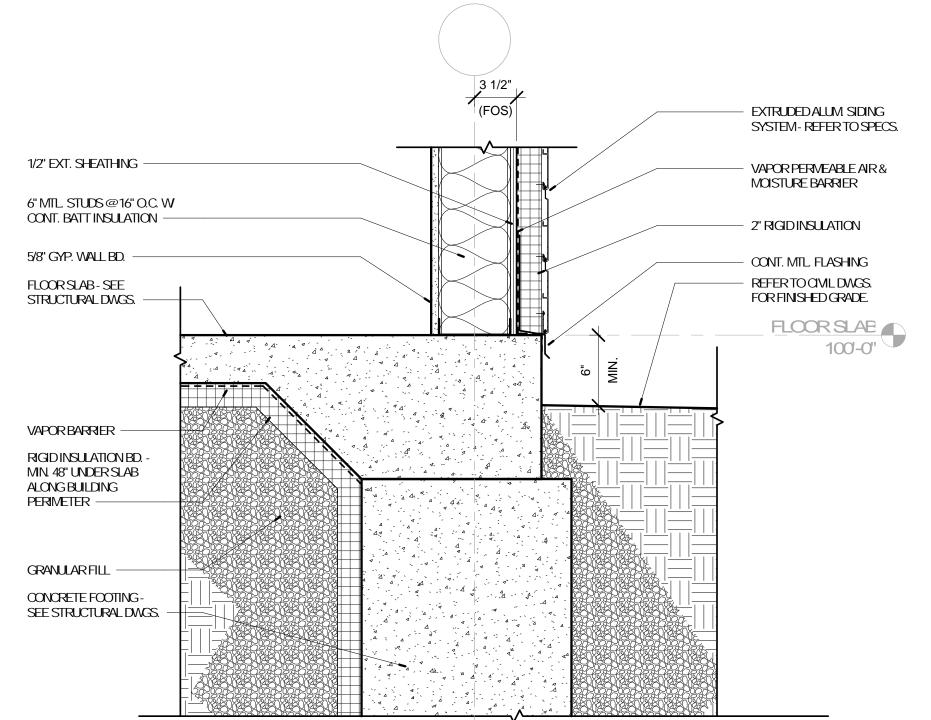
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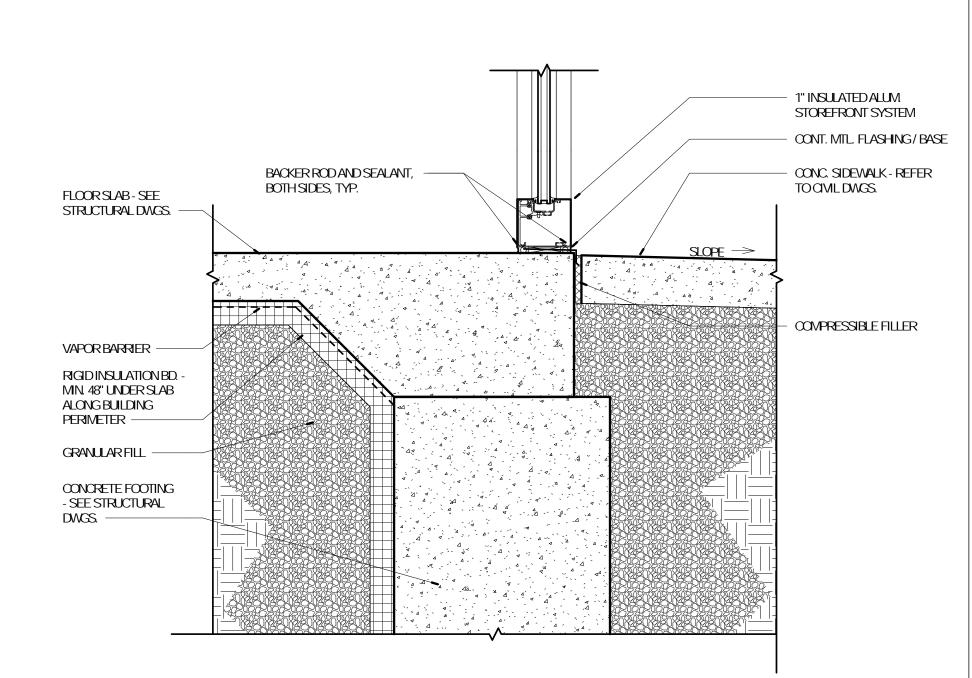
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PROJECT NUMBER: 16-1161.03

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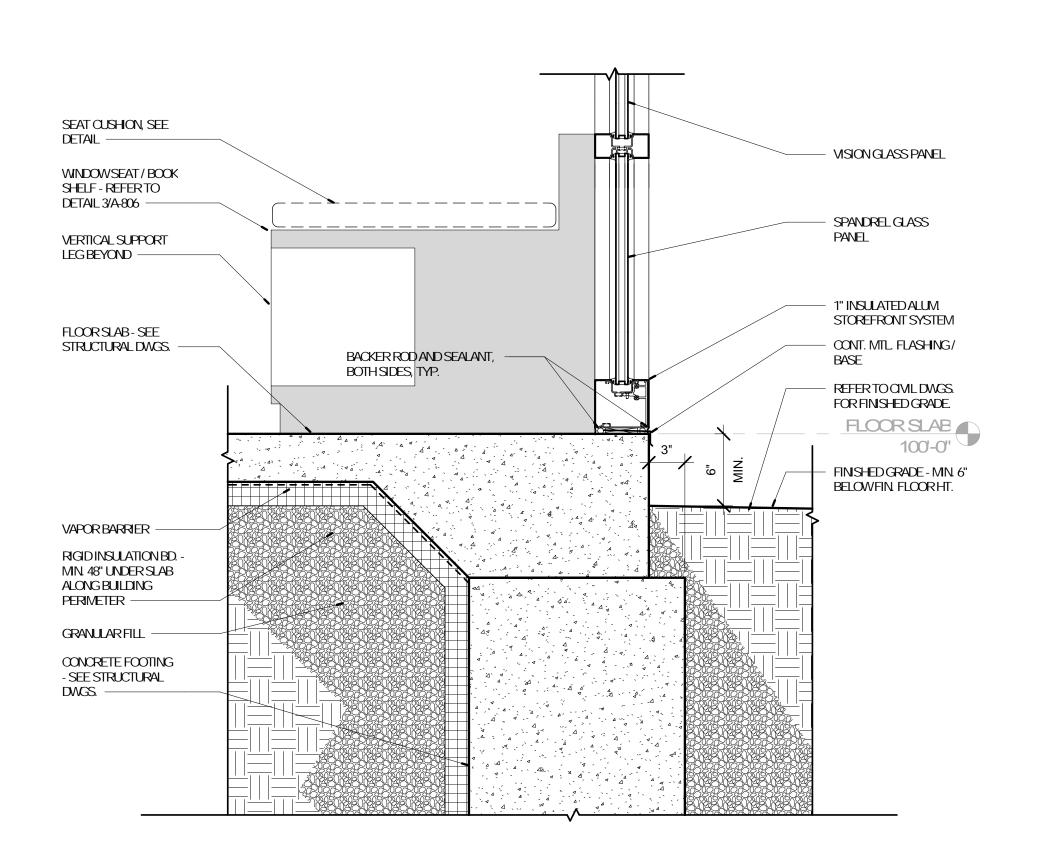



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A-805 1 1/2" = 1'-0" REFERENCE

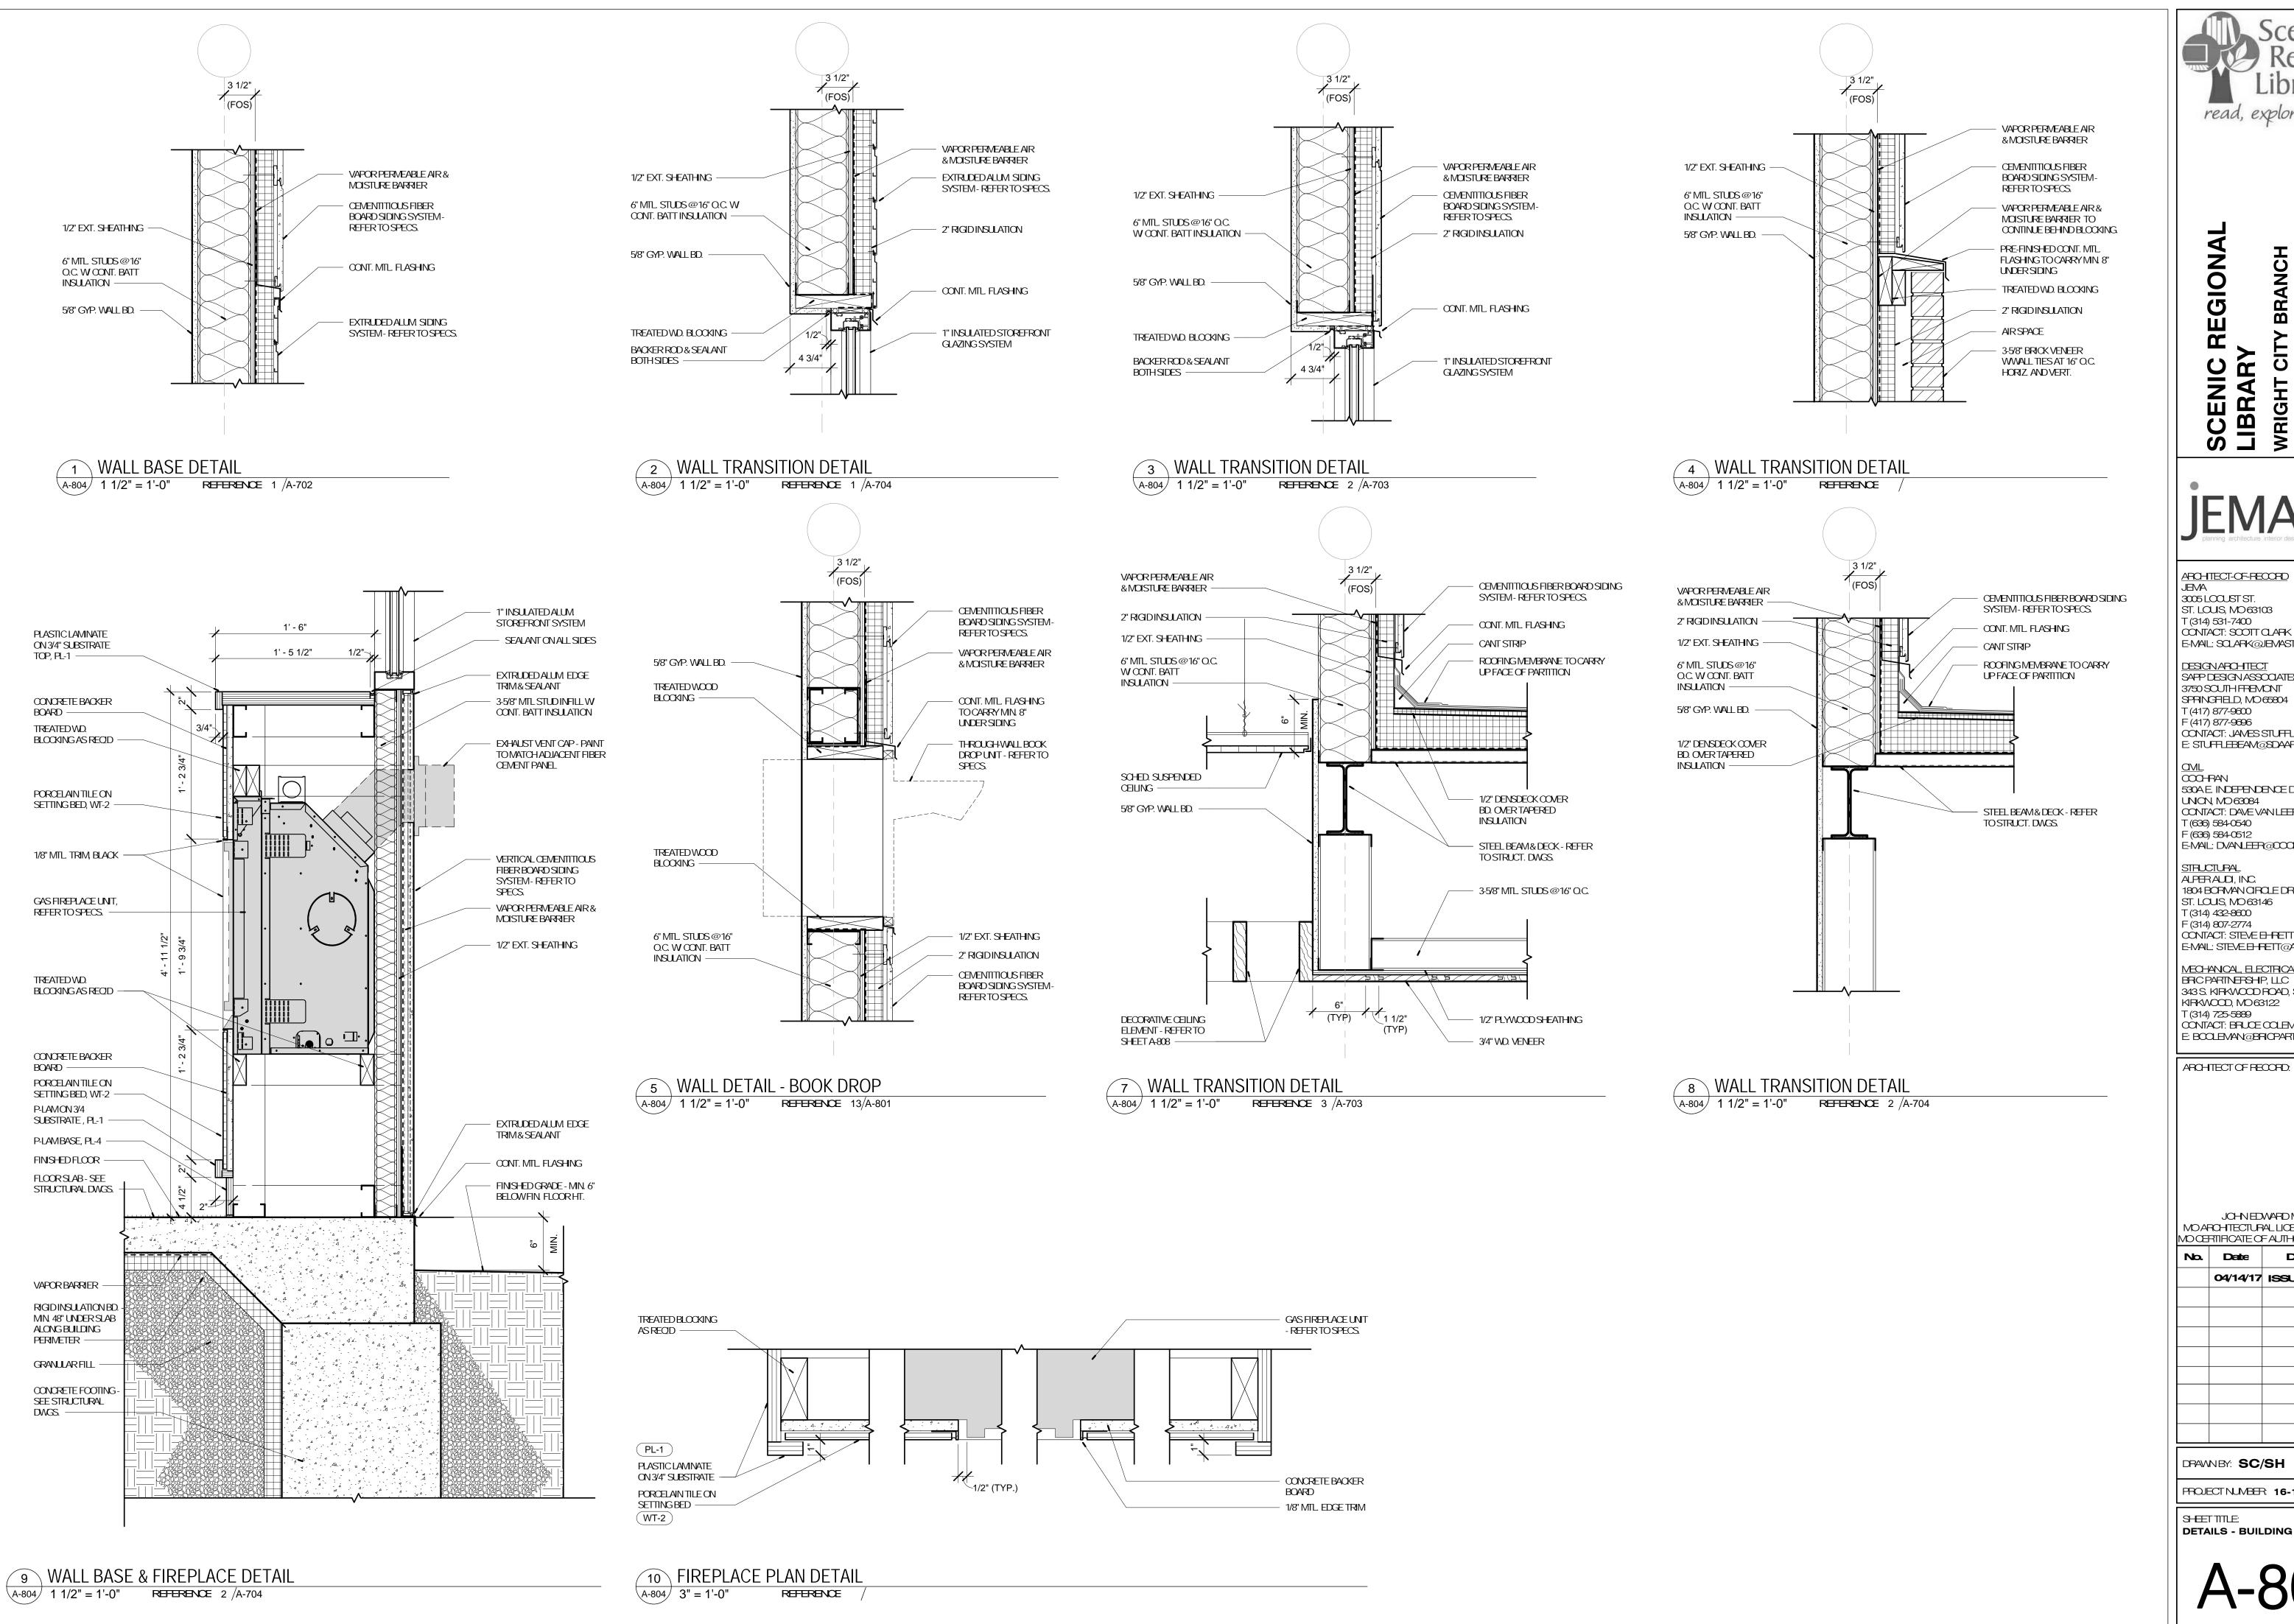
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A-805 1 1/2" = 1'-0" REFERENCE 1 /A-702

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A-805 1 1/2" = 1'-0" REFERENCE 3 /A-702





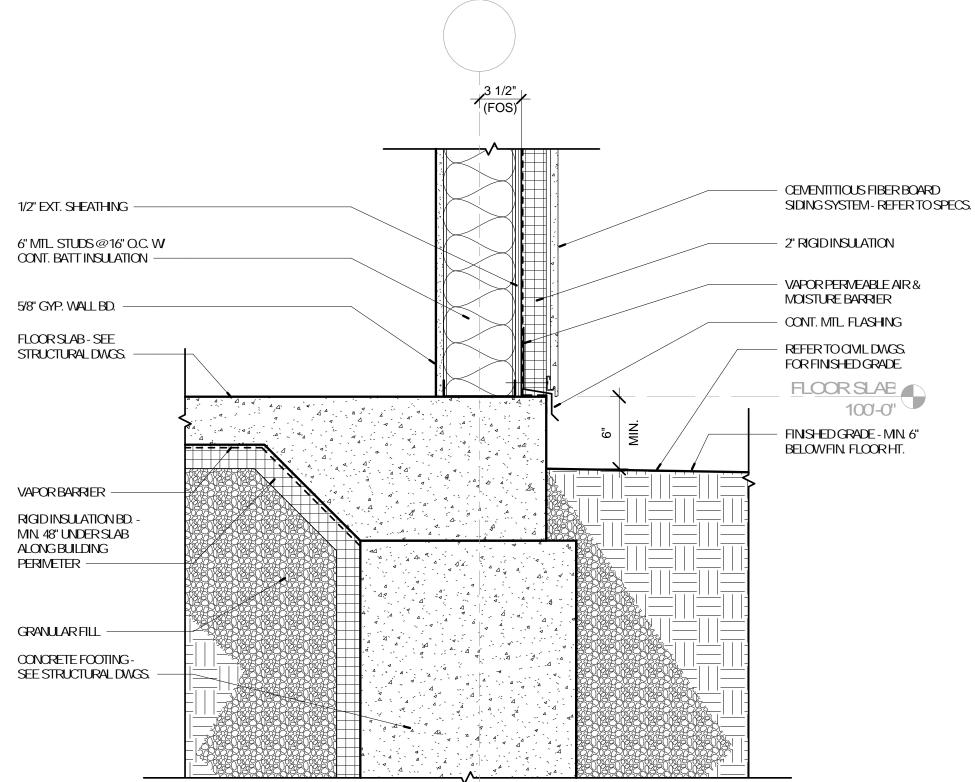

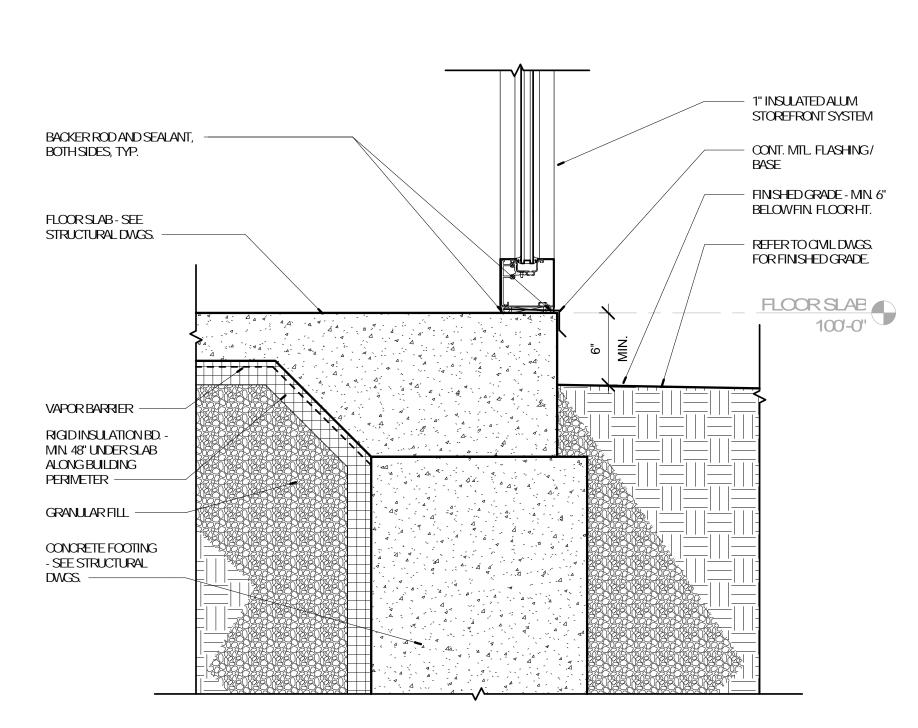4 WALL BASE DETAIL

A-805 1 1/2" = 1'-0" REFERENCE /

5 WALL BASE DETAIL

A-805 1 1/2" = 1'-0" REFERENCE 1 /A-703

6 WALL BASE DETAIL
A-805 1 1/2" = 1'-0" REFERENCE 2 /A-703

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ARCHITECT OF RECORD:

JOHN EDWARD MUELLER

MO ARCHTECTURAL LICENSE A2010039554

MO CERTIFICATE OF AUTHORITY A2014008380

No. Date Description


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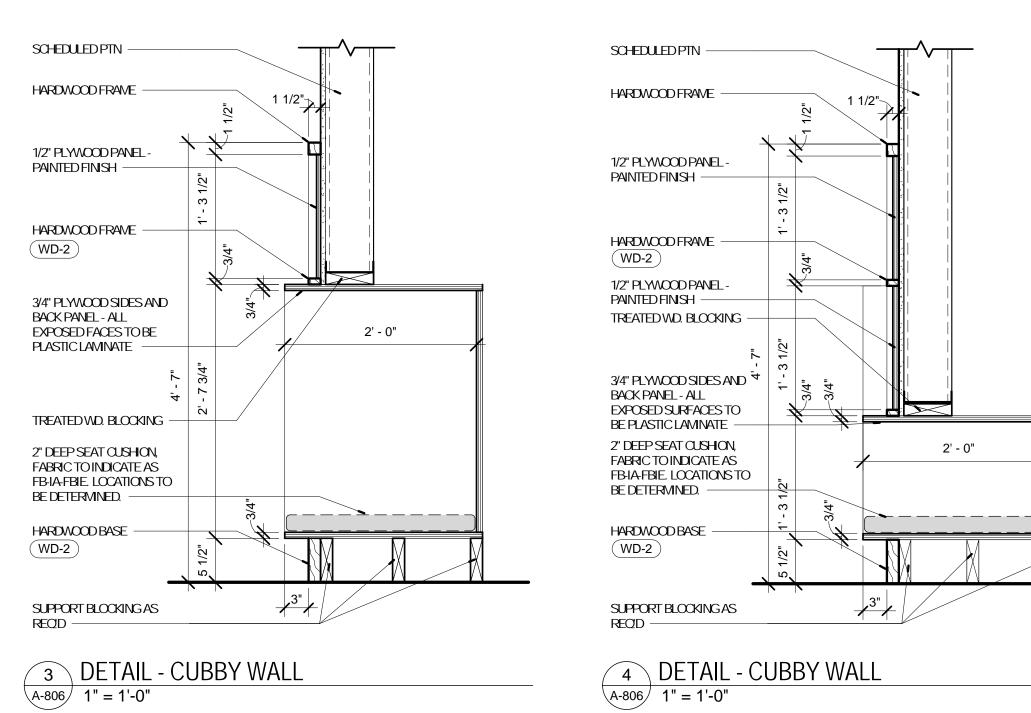
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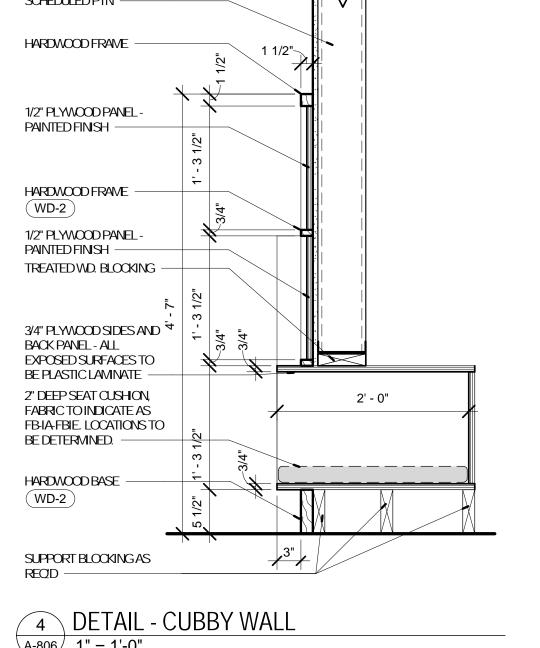
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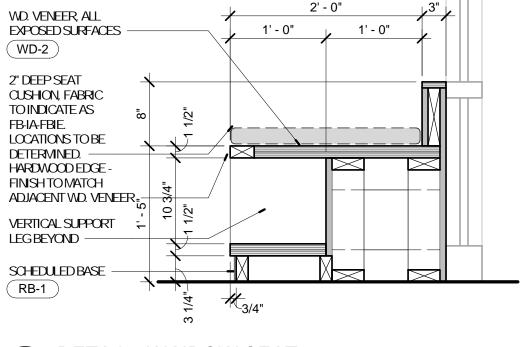
SHEET TITLE:

DETAILS - BUILDING









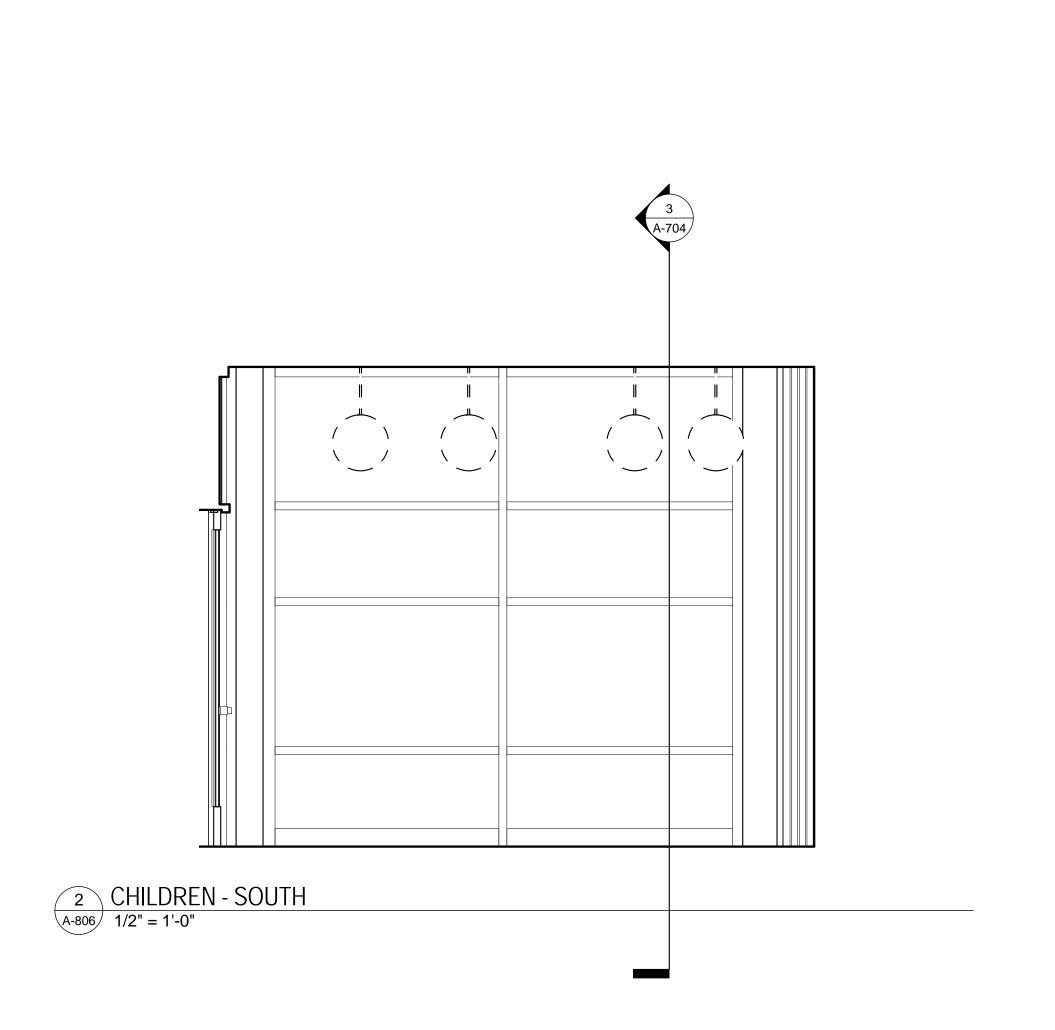

5 DETAIL - WINDOW SEAT A-806 1" = 1'-0"

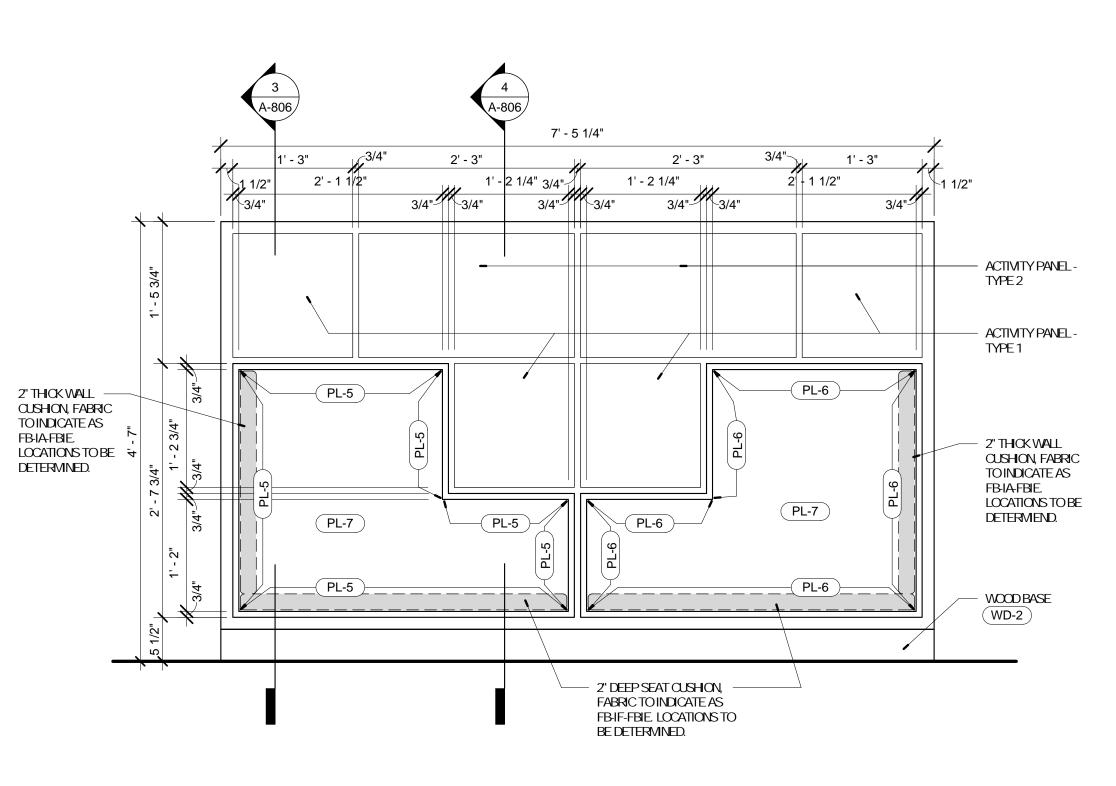

1 ELEV - CUBBIES A-806 1" = 1'-0"

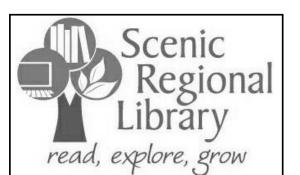

WRIGHT

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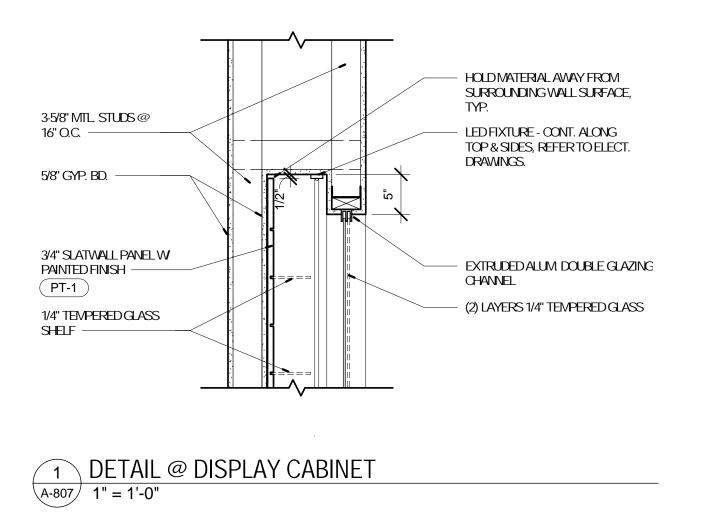
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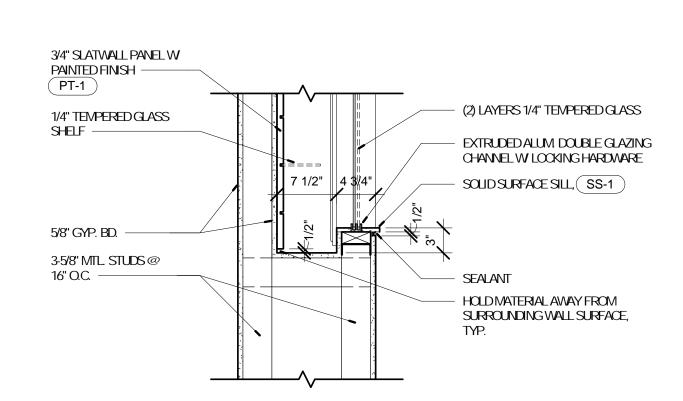
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No.	Date	Description
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PROJECT NUMBER: 16-1161.03


SHEETTITLE: DETAILS






DETAIL @ DISPLAY CABINET

A-807 1" = 1'-0"

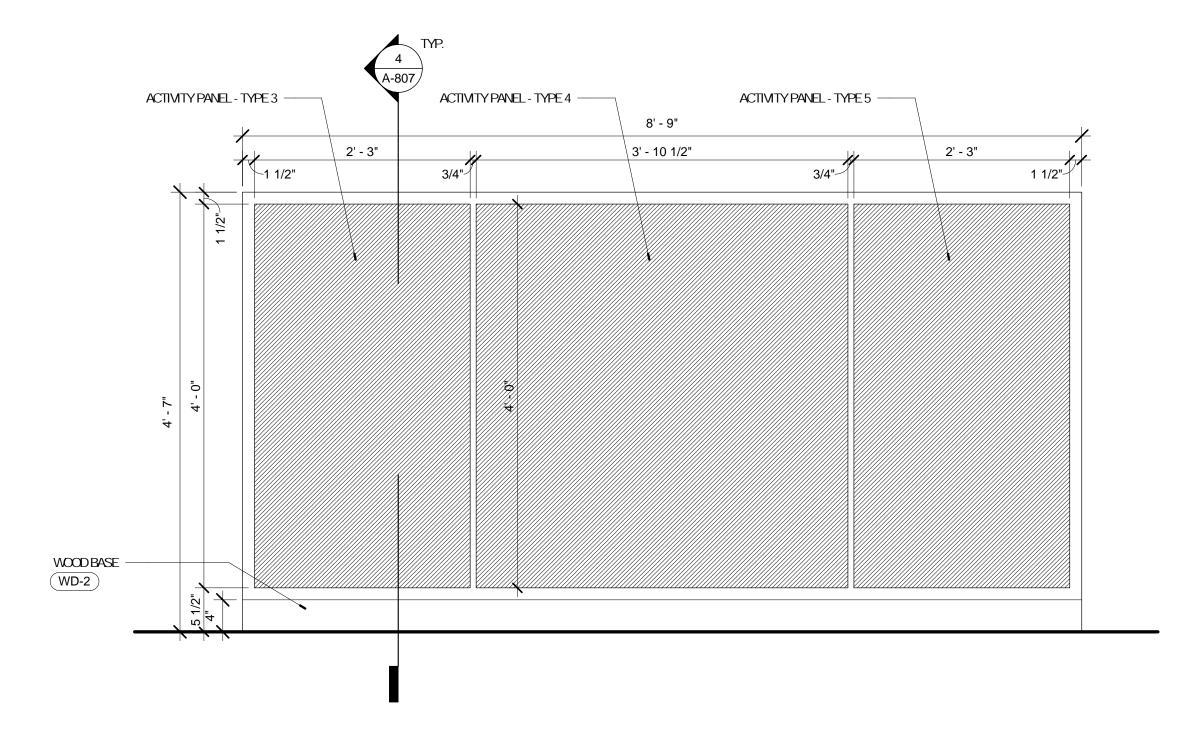

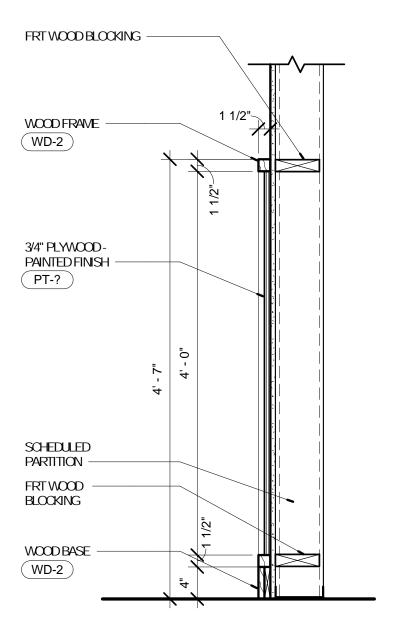

3 ELEV - ACTIVITY WALL
A-807 1" = 1'-0"

4 DETAIL - ACTIVITY WALL
A-807 1" = 1'-0"

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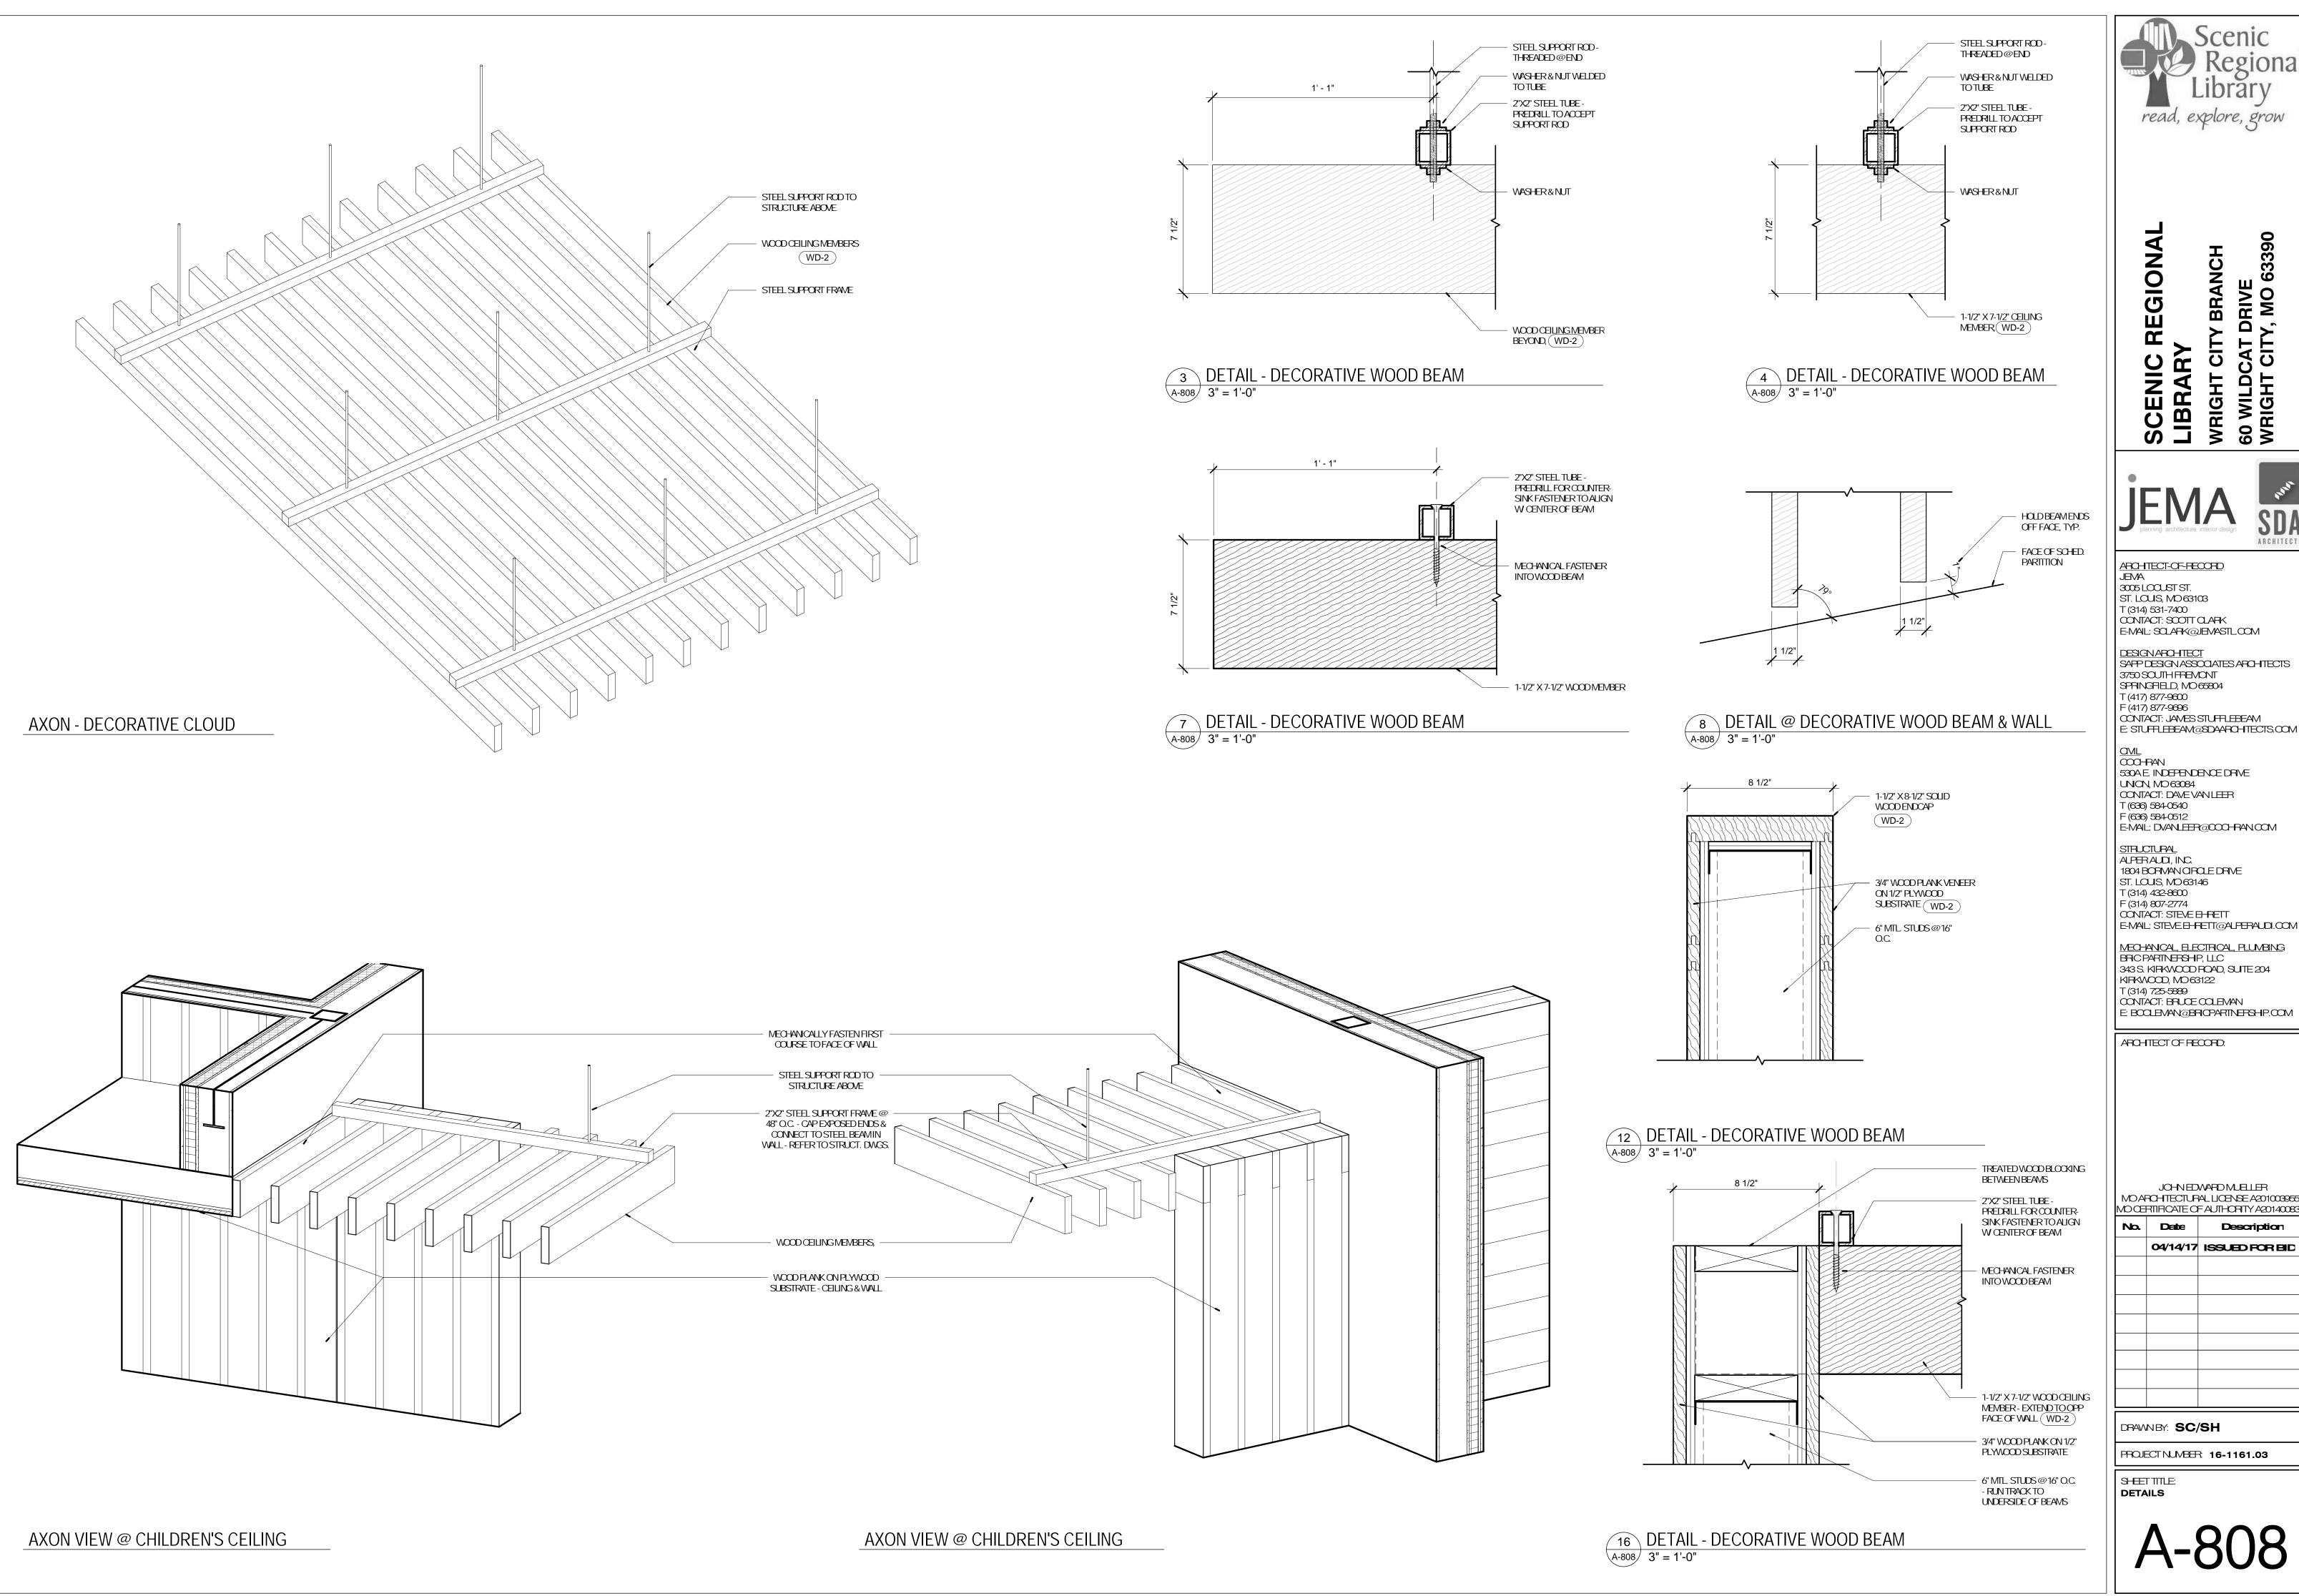
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PROJECT NUMBER: 16-1161.03

SHEET TITLE: DETAILS

A-807



read, explore, grow

63390

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CML COOHRAN 530A E INDEPENDENCE DRIVE UNION, MO 63084 CONTACT: DAVE VAN LEER T (636) 584-0540

E-MAL: DVANLEER@000-RAN.COM STRUCTURAL ALPERAUDI, INC. 1804 BORWAN GROLE DRIVE ST. LOUS, MD 63146 T (314) 432-8600 F (314) 807-2774 CONTACT: STEVE EL RETT

E-MAIL: STEVE.EI-PETT@ALPERAUDI.COM MECHANICAL, ELECTRICAL, PLUMBING BRIC PARTINERSHP, LLC 343 S. KIRKWOOD ROAD, SUITE 204 KIRKWOOD, M063122


ARCHITECT OF RECORD:

JOHN EDWARD MUELLER MOAPOHTECTURAL LICENSE A2010039554 MO CERTIFICATE OF AUTHORITY A2014008380

No.	Date	Description				
	04/14/17	ISSUED FOR BID				

DRAWNBY: SC/SH

SHEETTITLE:

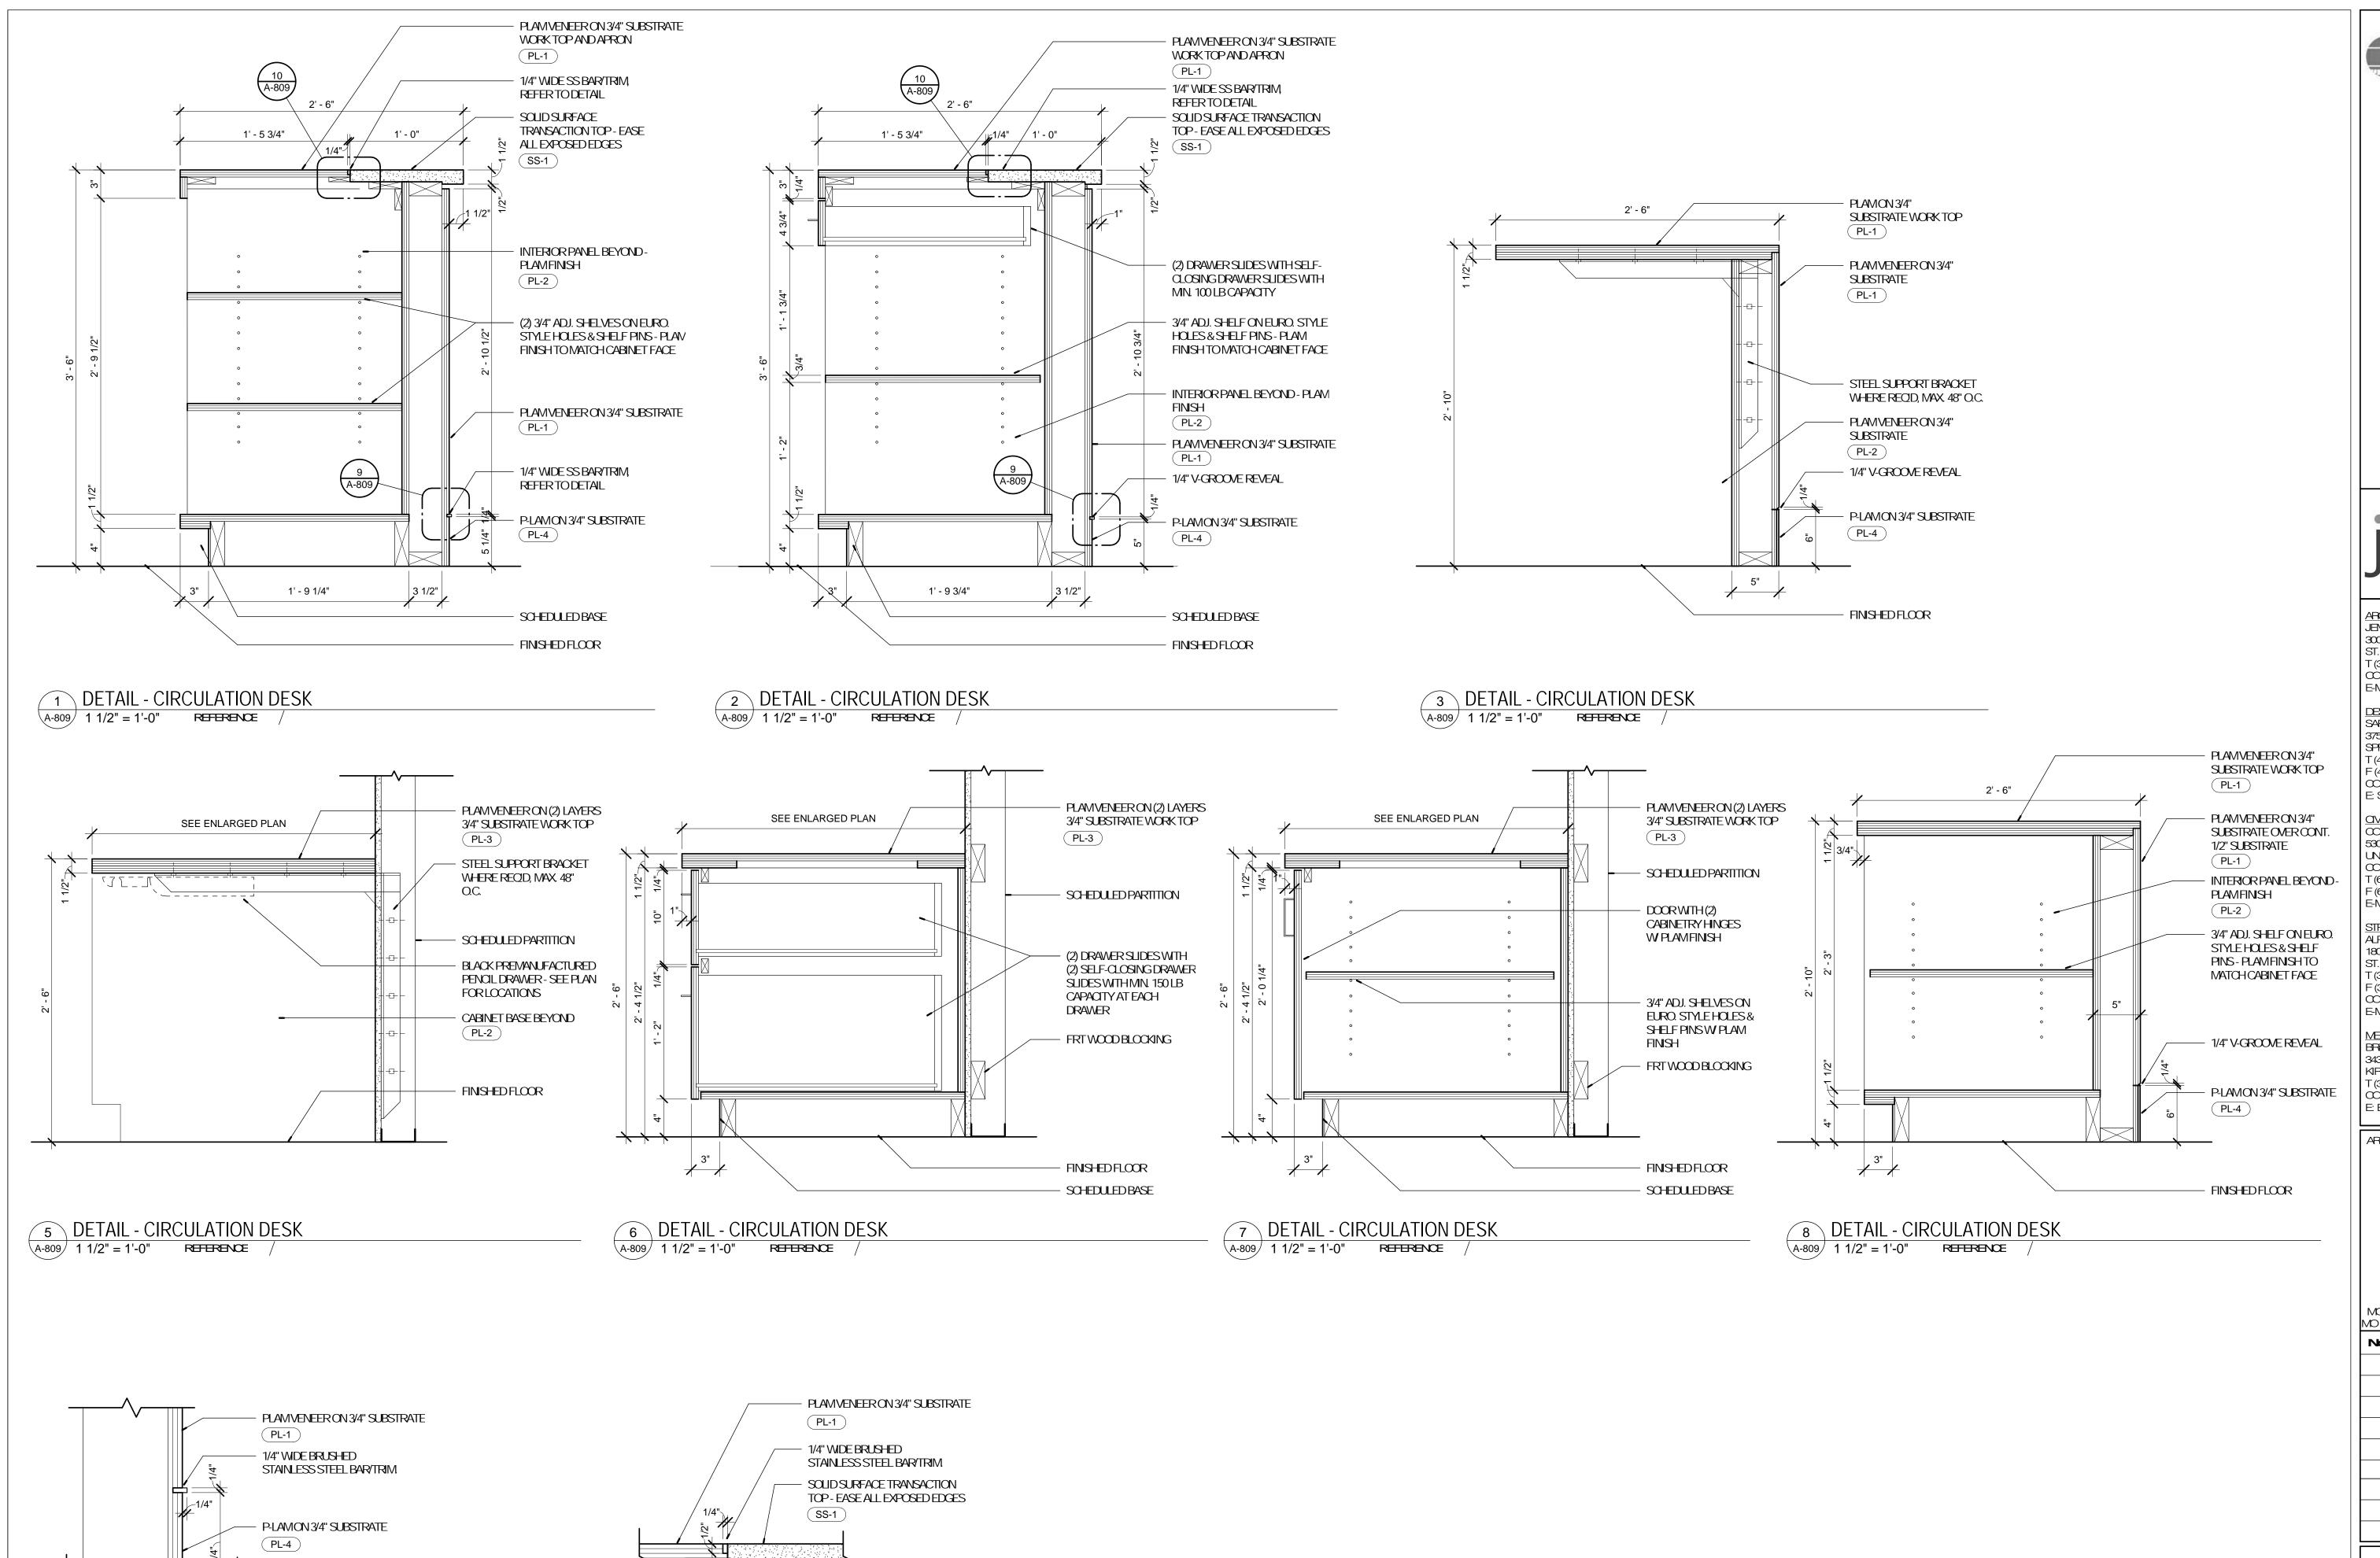

9 DETAIL - CIRCULATION DESK BASE TRIM

REFERENCE 1 /A-809

A-809 / 3" = 1'-0"

10 DETAIL - CIRCULATION DESK TOP

REFERENCE 1 /A-809



NCH :: 63390

LIBRARY
WRIGHT CITY BRANCH
60 WILDCAT DRIVE

EIVA
SD
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BHCPARINERSHP, LLC 343 S. KIPKWOOD POAD, SUTTE 204 KIPKWOOD, MO 63122 T (314) 725-5889 CONTACT: BRUCE COLEMAN E: BOOLEMAN@BRICPARTINERSHP.COM

ARCHITECT OF RECORD:

JOHNEDWARD MUELLER
MOARCHTECTURAL LICENSE A2010039554
MOCERTIRCATE OF AUTHORITY A2014008380


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	04/14/17	ISSUED FOR BID				


DRAWN BY: SC/SH

PROJECT NUMBER: 16-1161.03

SHEETTILE:
DETAILS - MILLWORK

A-809

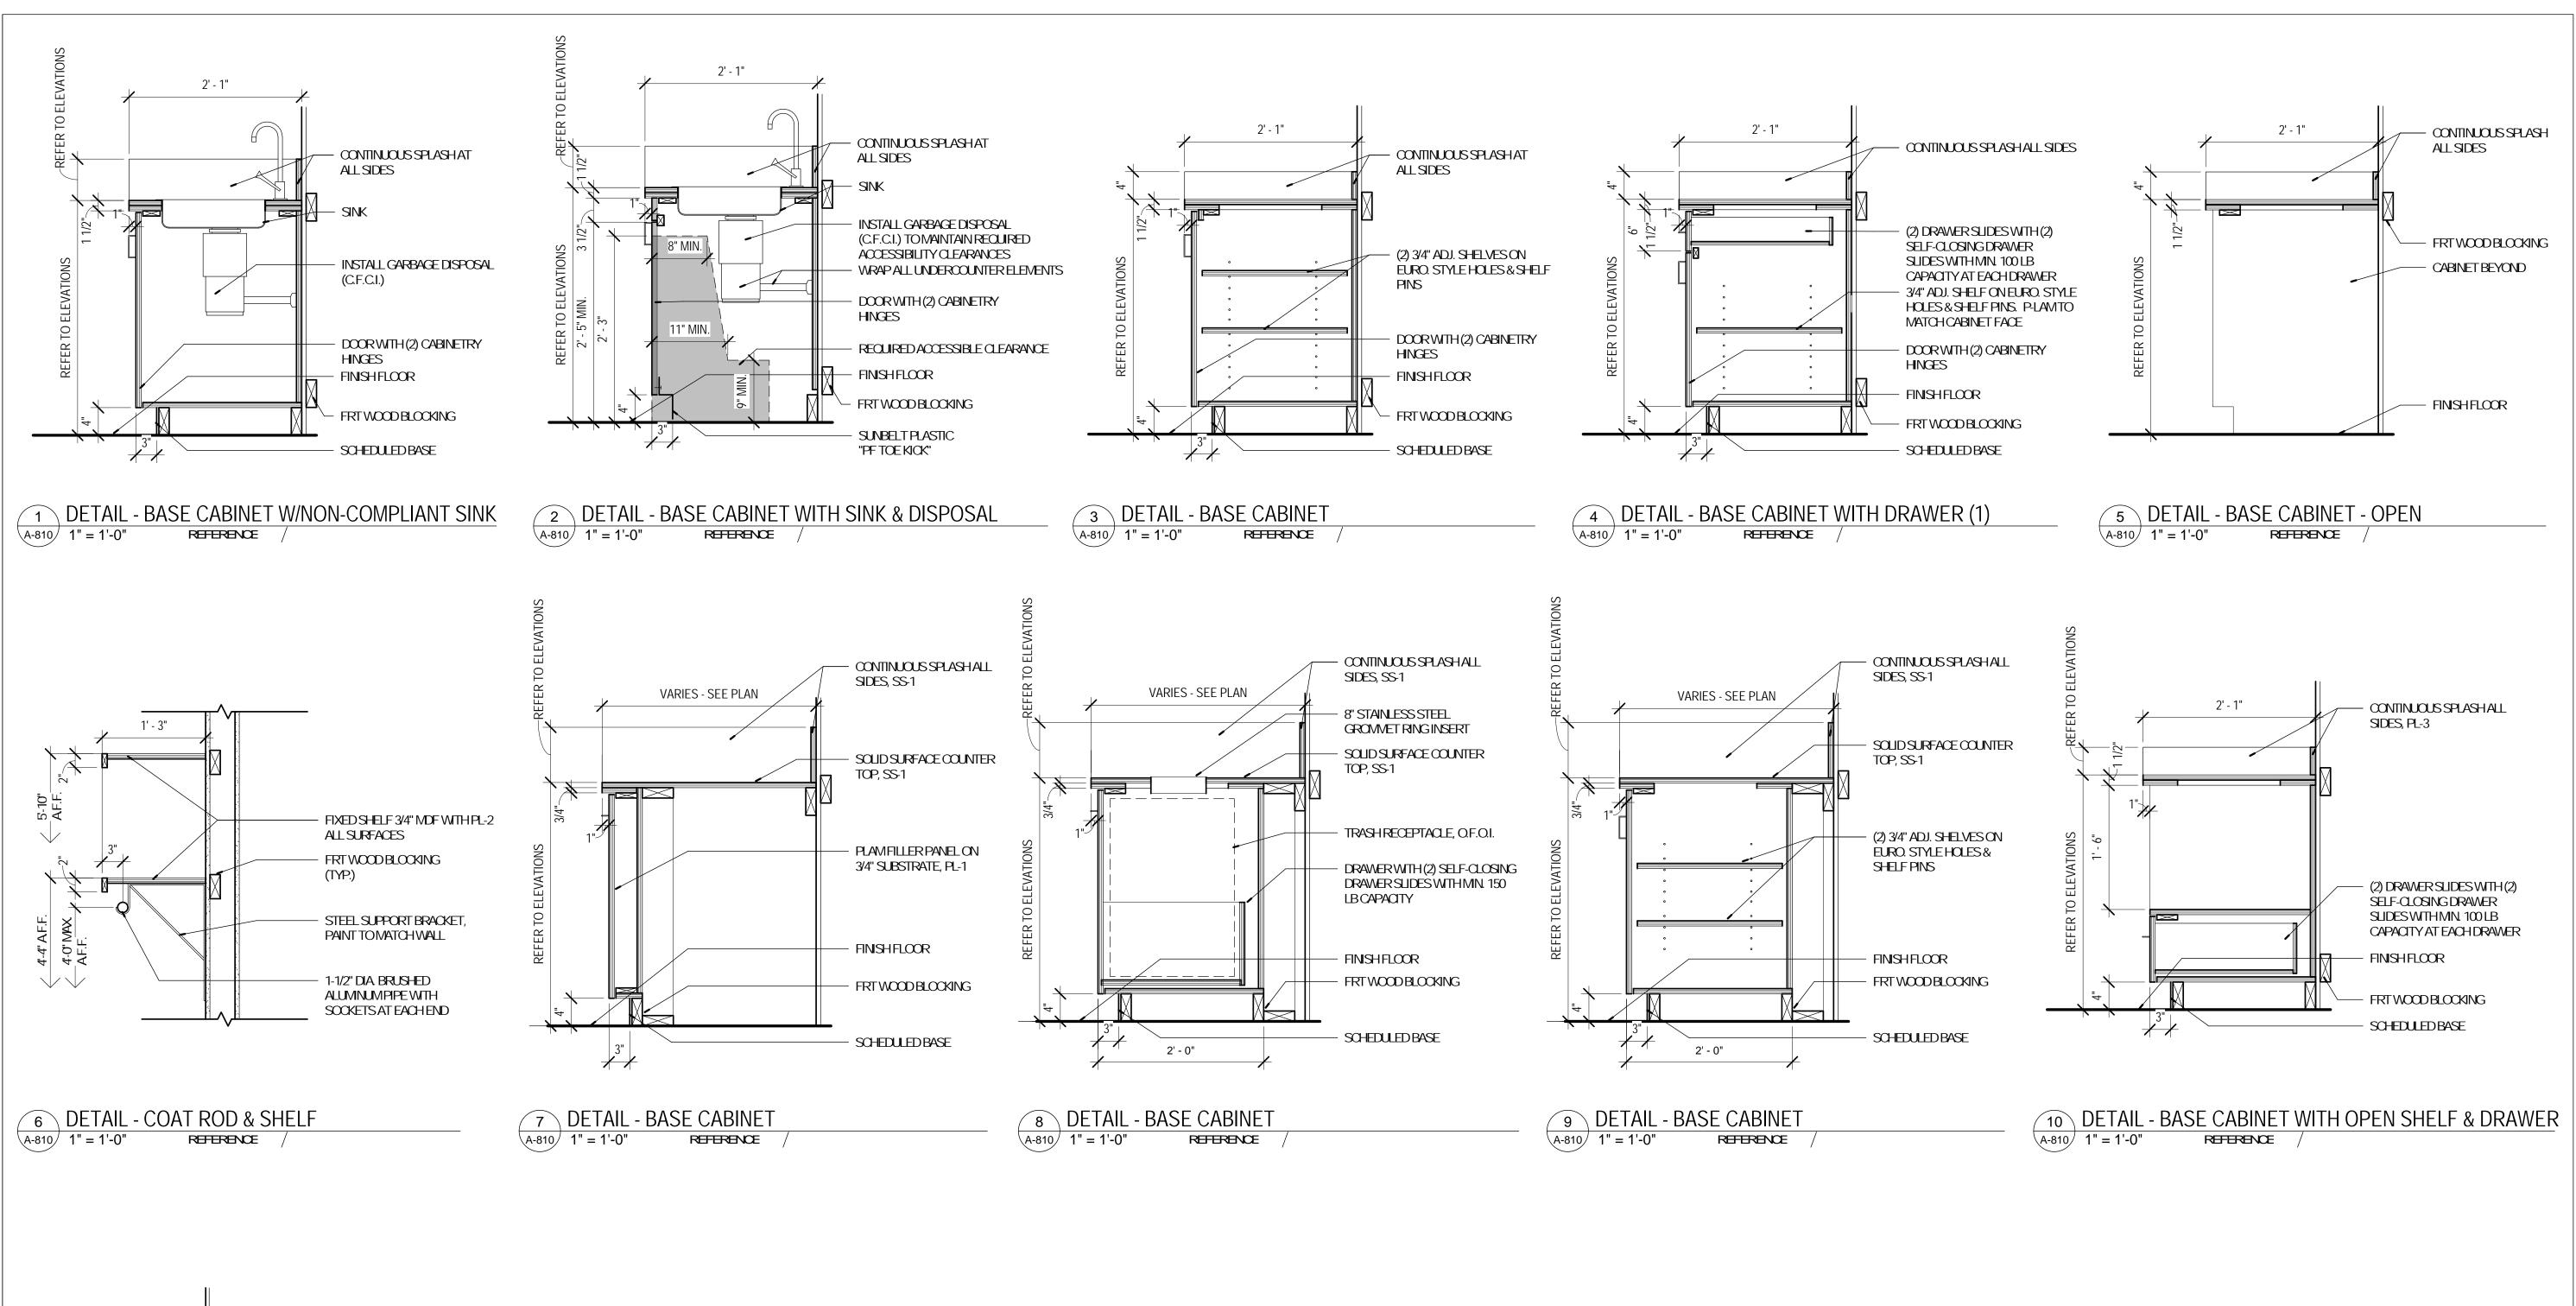

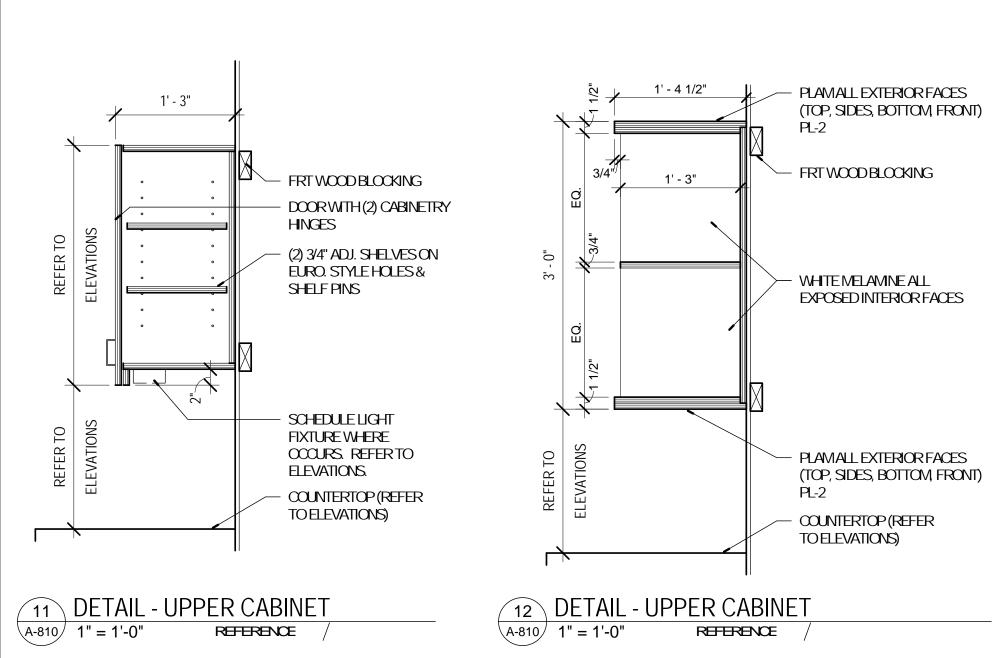



CENIC REGIONAL
BRARY
RIGHT CITY BRANCH
WILDCAT DRIVE
RIGHT CITY, MO 63390

ENA SI Planning architecture interior design

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ARCHITECT OF RECORD:

JOHN EDWARD MUELLER
MO ARCHTECTURAL LICENSE A2010039554
MO CERTIFICATE OF AUTHORITY A2014008380


No.	Date	Description
	04/14/17	ISSUED FOR BID

DRAWNBY: SC/SH

PROJECTNUMBER: 16-1161.03

SHEETTITLE:
DETAILS - MILLWORK

A-810

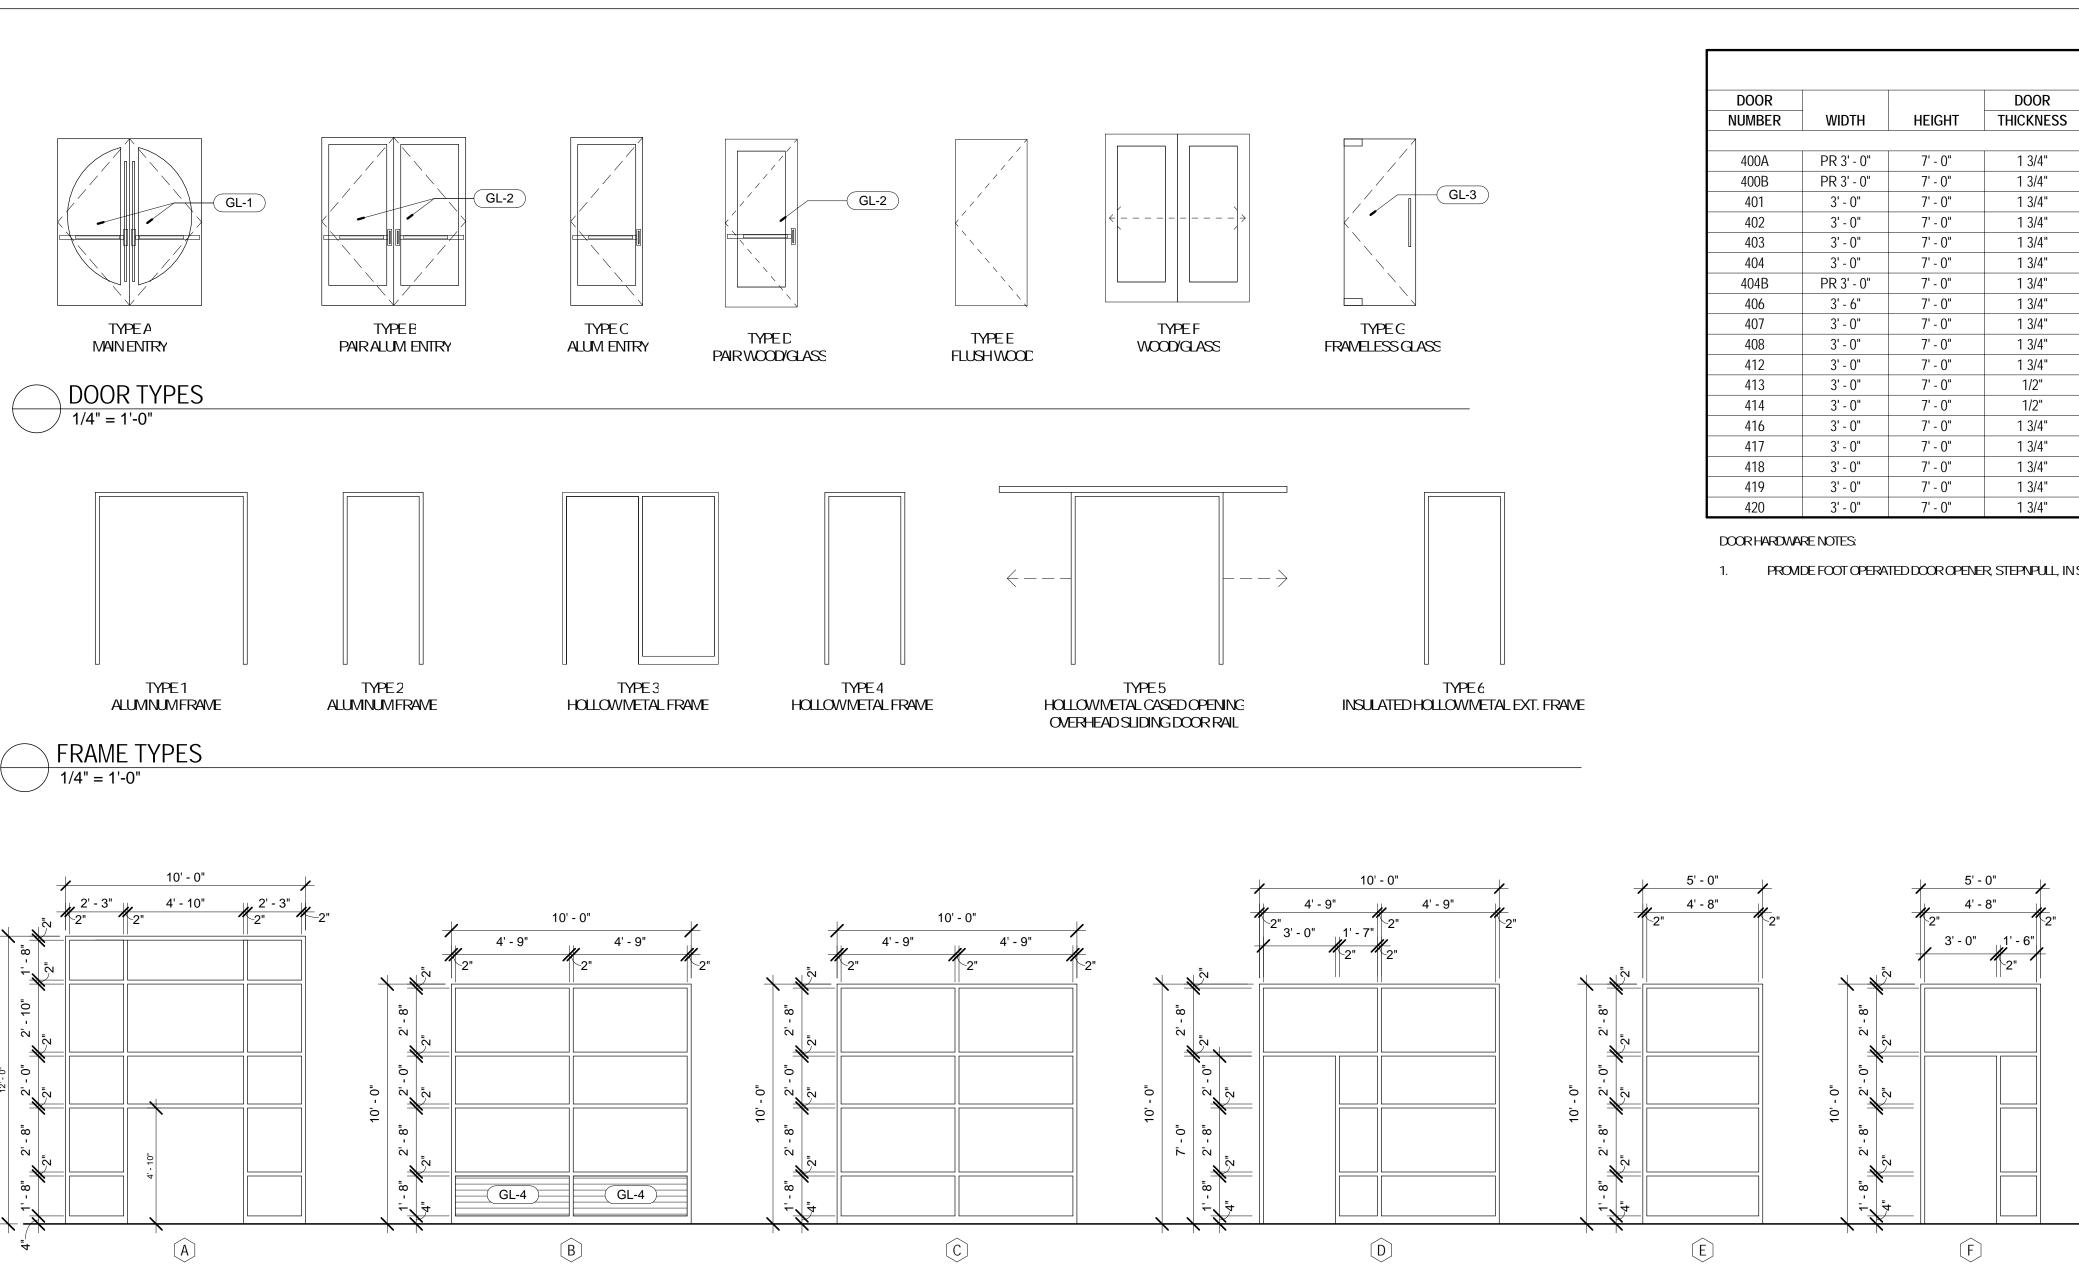


20' - 2" 4' - 5" 4' - 5" 6' - 0" 4' - 6" 2" 2" 2"	7' - 0"	1' - 6"	12' - 0" 2' - 8" 2" 2" 2" 2" 2"
.0. 0. 2 8.		-0.	10 0" 2" 2' - 8" 2" 2' - 8"
G	GL-3 GL-3	GL-3	J

WINDOW TYPES 1/4" = 1'-0"

DOOR SCHEDULE										
DOOR			DOOR	DOOR	DOOR	FF	RAME		FIRE	
NUMBER	WIDTH	HEIGHT	THICKNESS	TYPE	MATERIAL	TYPE	FINISH	HDWR. GROUP	RATING	REMARKS
400A	PR 3' - 0"	7' - 0"	1 3/4"	Α	ALUM.	1	PRE-FINISHED	1.0 AO		CUSTOM COLOR TO MATCH SAMPLE, SEE SPECS.
400B	PR 3' - 0"	7' - 0"	1 3/4"	В	ALUM.	1	PRE-FINISHED	4.0 AO		
401	3' - 0"	7' - 0"	1 3/4"	D	WD-1/GL	3	PT-3	6.0		
402	3' - 0"	7' - 0"	1 3/4"	Е	WD-1	4	PT-3	13.0		SEE NOTE 1 BELOW, INSTALL RESTROOM SIDE.
403	3' - 0"	7' - 0"	1 3/4"	E	WD-1	4	PT-3	13.0		SEE NOTE 1 BELOW, INSTALL RESTROOM SIDE.
404	3' - 0"	7' - 0"	1 3/4"	С	ALUM.	2	PRE-FINISHED	2.0		
404B	PR 3' - 0"	7' - 0"	1 3/4"	F	WD-1/GL	5	PT-3	5.0		PAIR OF SLIDERS ON RAIL
406	3' - 6"	7' - 0"	1 3/4"	Е	WD-1	4	PT-3	7.0	45 MINUTE	
407	3' - 0"	7' - 0"	1 3/4"	С	ALUM.	2	PRE-FINISHED	2.0		
408	3' - 0"	7' - 0"	1 3/4"	С	ALUM.	2	PRE-FINISHED	2.0		
412	3' - 0"	7' - 0"	1 3/4"	Е	WD-1	4	PT-3	11.0		
413	3' - 0"	7' - 0"	1/2"	G	GL	N/A	N/A	14.0		FLOOR AND HEAD PIVOTS, SEE SPECS.
414	3' - 0"	7' - 0"	1/2"	G	GL	N/A	N/A	14.0		FLOOR AND HEAD PIVOTS, SEE SPECS.
416	3' - 0"	7' - 0"	1 3/4"	Е	WD-1	4	PT-3	10.0	45 MINUTE	
417	3' - 0"	7' - 0"	1 3/4"	Е	WD-1	4	PT-3	9.0		
418	3' - 0"	7' - 0"	1 3/4"	С	ALUM.	2	PRE-FINISHED	2.0		
419	3' - 0"	7' - 0"	1 3/4"	Е	WD-1	4	PT-3	9.0		
420	3' - 0"	7' - 0"	1 3/4"	Е	WD-1	4	PT-3	12.0	45 MINUTE	

NOTE: UNLESS NOTED OTHERWISE ALL GALZING TO BE TYPE (GL-1)

1. PROMDE FOOT OPERATED DOOR OPENER, STEPNPULL, IN SILVER FINISH FOR THIS DOOR

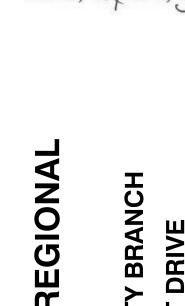

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ARCHITECT OF RECORD:


JOHN EDWARD MUELLER MO ARCHTECTURAL LICENSE A2010039554 MO CERTIRICATE OF AUTHORITY A2014008380


No.	Date	Description
	04/14/17	ISSUED FOR BID


DRAWNBY: SC/SH


PROJECT NUMBER: 16-1161.03


SHEETTITLE: DOOR SCHEDULE / DOOR, FRAME AND WINDOW TYPES

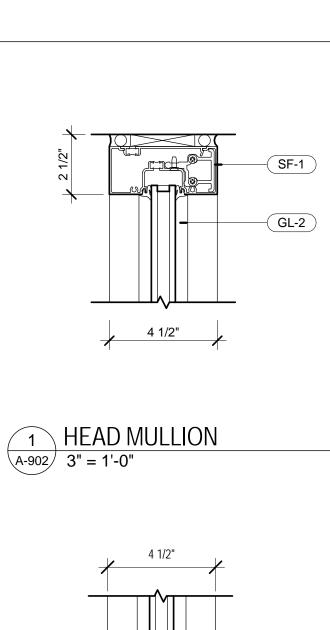


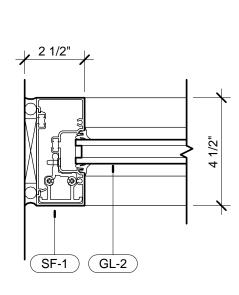


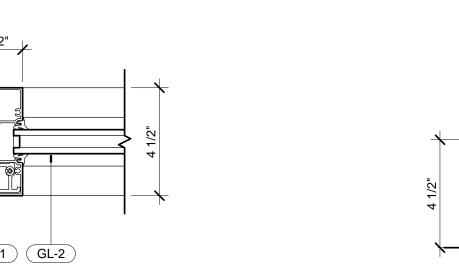

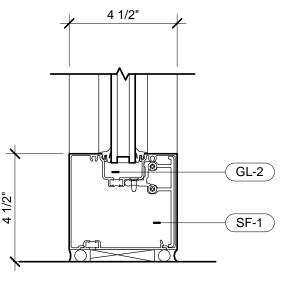

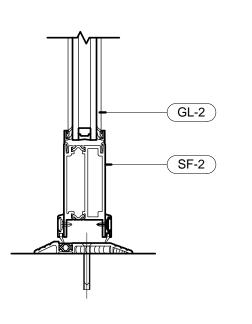

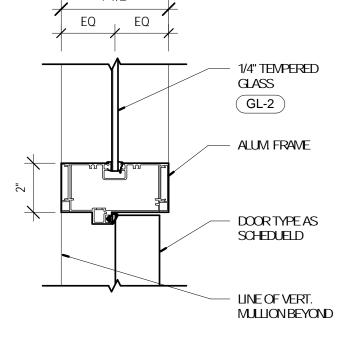

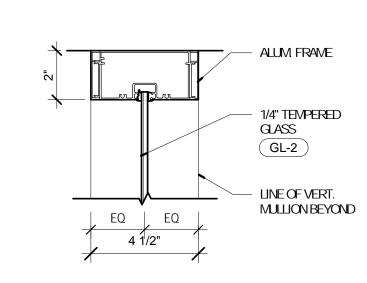


2 JAMB MULLION




4 DOOR SILL A-902 3" = 1'-0"


5 MULLION / DOOR JAMB A-902 3" = 1'-0"


6 MULLION / DOOR JAMB A-902 3" = 1'-0"

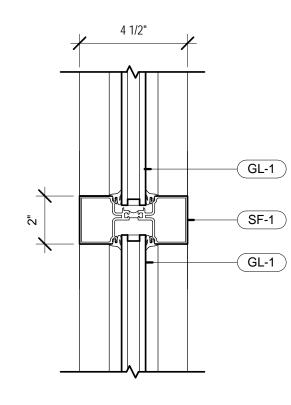


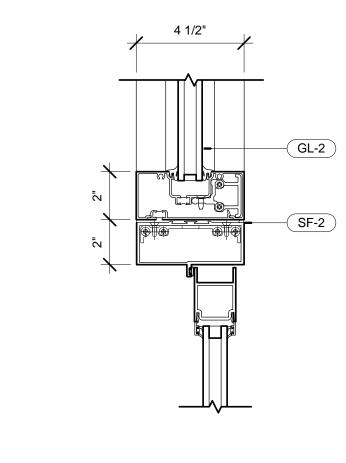


A-902 3" = 1'-0"

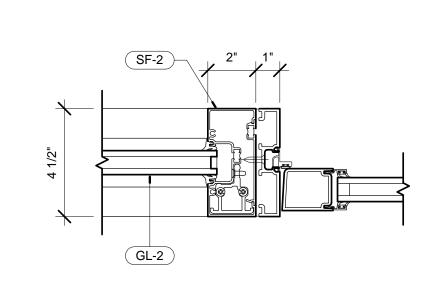

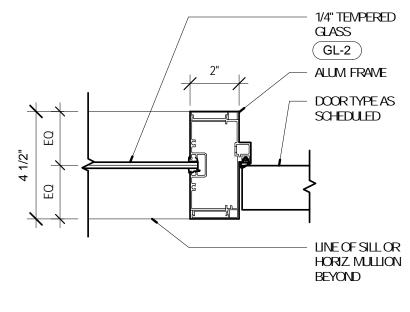

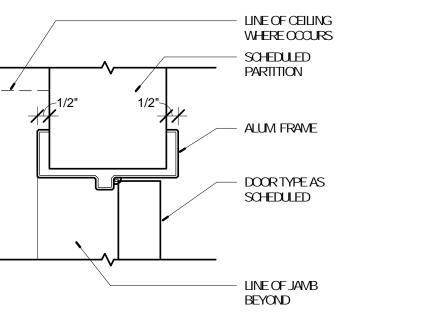

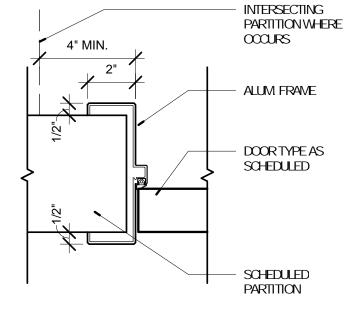

7 INNER MULLION A-902 3" = 1'-0"












DOOR JAMB (TYP) A-902 3" = 1'-0"

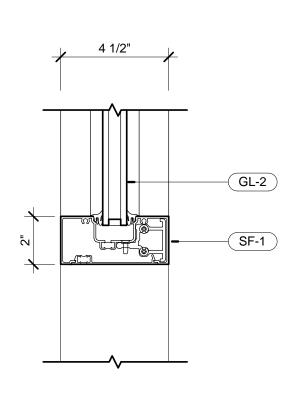




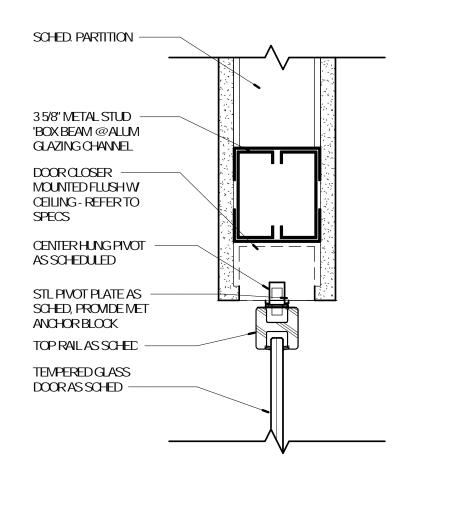

15 DETAIL @ GLASS DOOR HEAD A-902 3" = 1'-0"

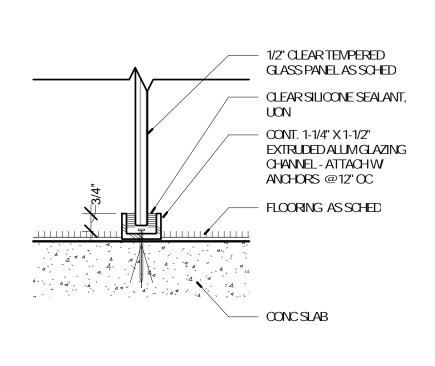

16 DETAIL @ GLASS PANEL SILL A-902 3" = 1'-0"

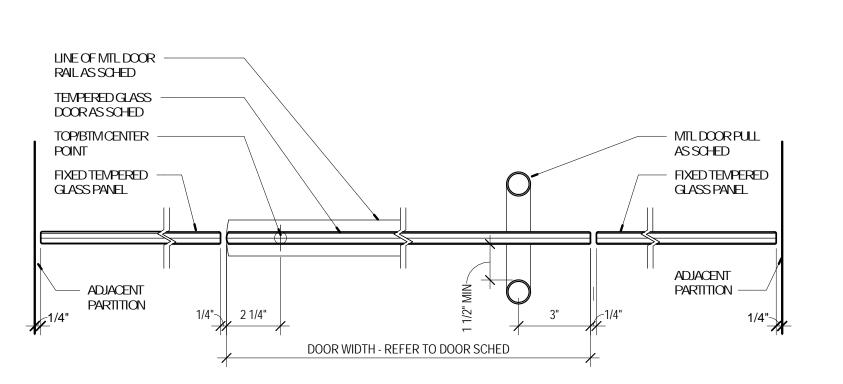

JAMB DETAIL @ TEMPERED GLASS DOOR A-902 3" = 1'-0"

E: BOOLEMAN@BRICPARTINERSHP.COM

ARCHITECT OF RECORD:

JOHN EDWARD MUELLER MOAPOHTECTURAL LICENSE A2010039554 MO CERTIFICATE OF AUTHORITY A2014008380

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BRANCH

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CONTACT: STEVE EL RETT

BRICPARINERSHP, LLC

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ST. LOUS, MO63146

63390


REGIONAL

	No.	Date	Description				
		04/14/17	ISSUED FOR BID				
1							

DRAWNBY: SC/SH

PROJECT NUMBER: 16-1161.03

SHEET TITLE: FRAME DETAILS

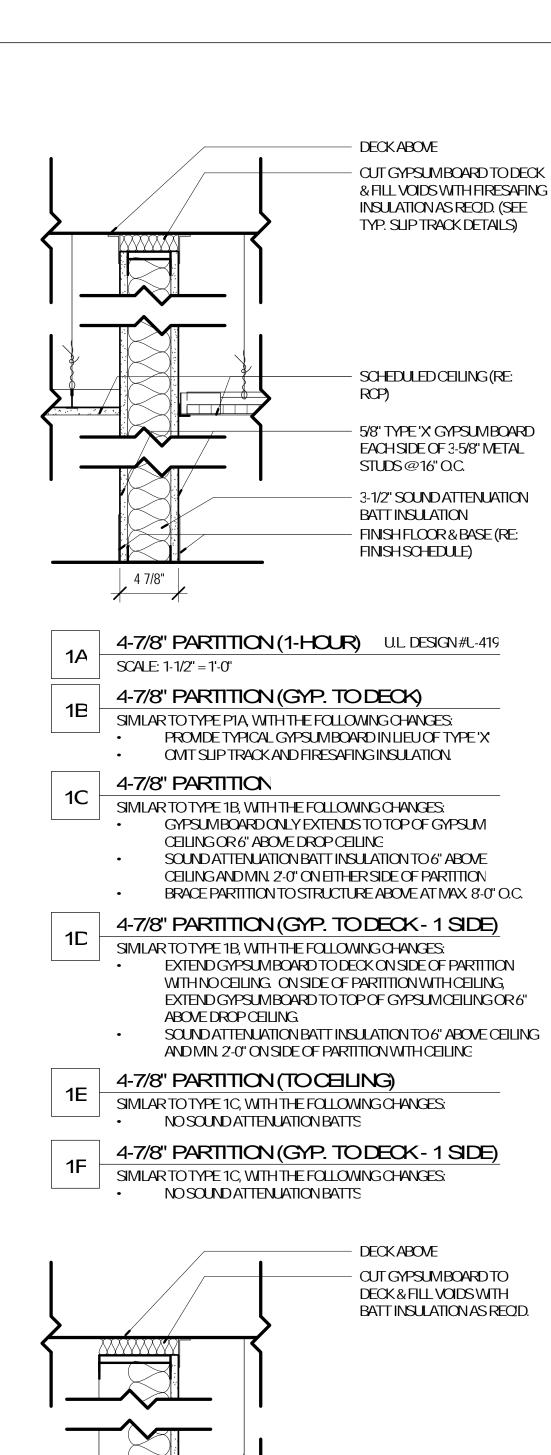

SCHEDULED CEILING (RE:

5/8" BOARD ON 20 GA 6"

METAL STUDS @ 16" O.C.

BATT INSULATION

FINISH SCHEDULE)

3-1/2" SOUND ATTENUATION


FINISHFLOOR & BASE (RE:

RCP)

6 5/8"

SCALE: 1 1/2" = 1'-0"

6-5/8" PARTITION (GYP. TO DECK)

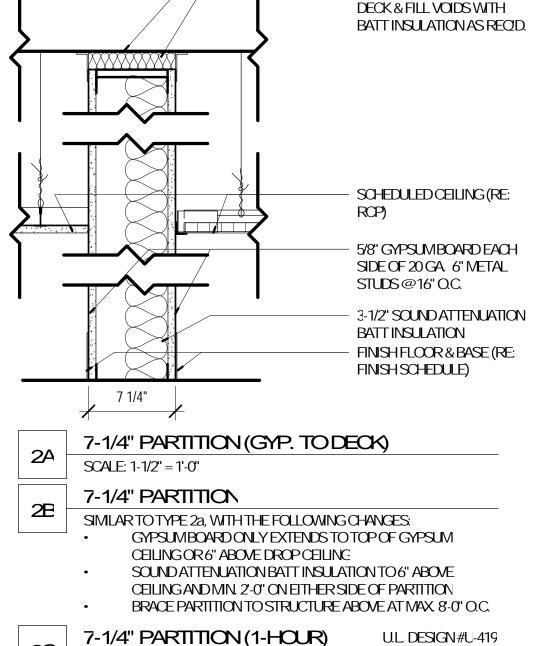

SIMLAR TO TYPE 2a, WITH THE FOLLOWING CHANGES:

SIMLARTO TYPE 2a, WITH THE FOLLOWING CHANGES:

SIMLAR TO TYPE 2a, WITH THE FOLLOWING CHANGES:

1/2" PLYWOOD SHEATHING BOTH SIDES IN LIEU OF

• SLIPTRACK AND FIRESAFING INSULATION.

7-1/4" PARTITION (TO CEILING)

3/4" WOOD PLANK BOTH SIDES

NO SOUND ATTENUATION BATTS

TYPE "X" GYPSUMBOARD.

8-1/2" PARTITION

GYPSUMBOARD

VARIES (RE: PLAN)

SCALE: 1 1/2" = 1'-0"

CHASE PARTITION

CHASE PARTITION (GYP. TO DECK)

SIMLAR TO TYPE 5a, WITH THE FOLLOWING CHANGES:

MN6" ABOVE DROP CEILING


PROMED CEMETITIOUS BACKER BOARD UP TO 48" A.F.F.

SOUND ATTENUATION BATT INSULATION TO 6" ABOVE CELLING AND MIN. 2'-0" ON EITHER SIDE OF PARTITION

EXTEND GYPSUMBOARD TO TOP OF GYPSUMCEILING OR

DECK ABOVE

CUT GYPSUMBOARD TO

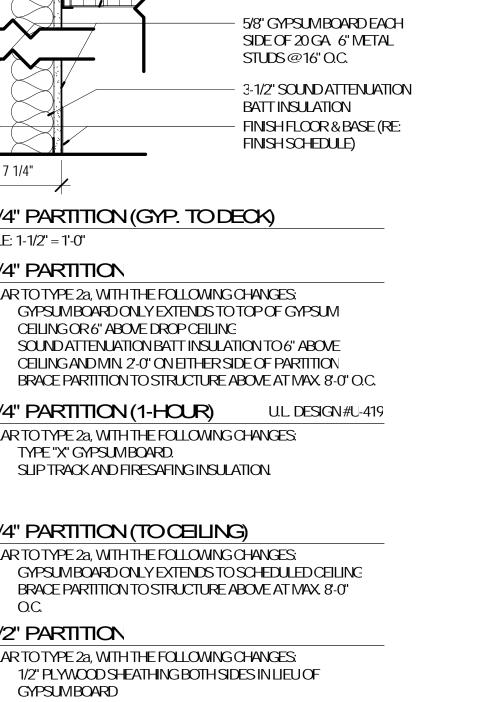


DECK ABOVE

RCP)

16" O.C.

BATT INSULATION

FINISH SCHEDULE)

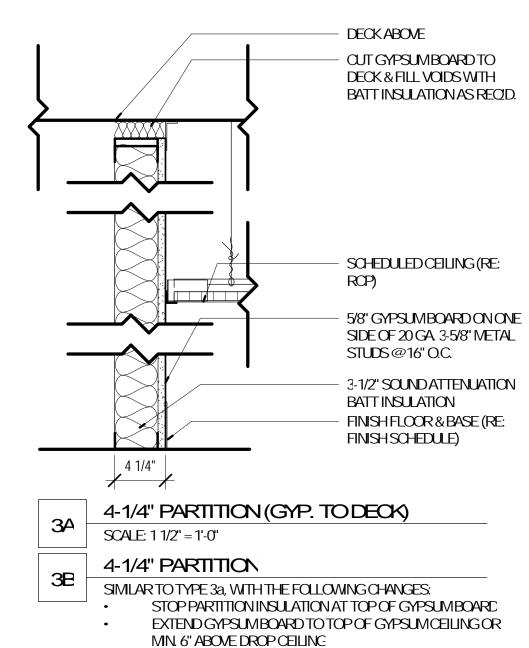


ASFURRINGWALL

4-1/4" PARTITION (TO CEILING)

NO SOUND ATTENUATION BATTS

SIMLAR TO TYPE 3b, WITH THE FOLLOWING CHANGES:

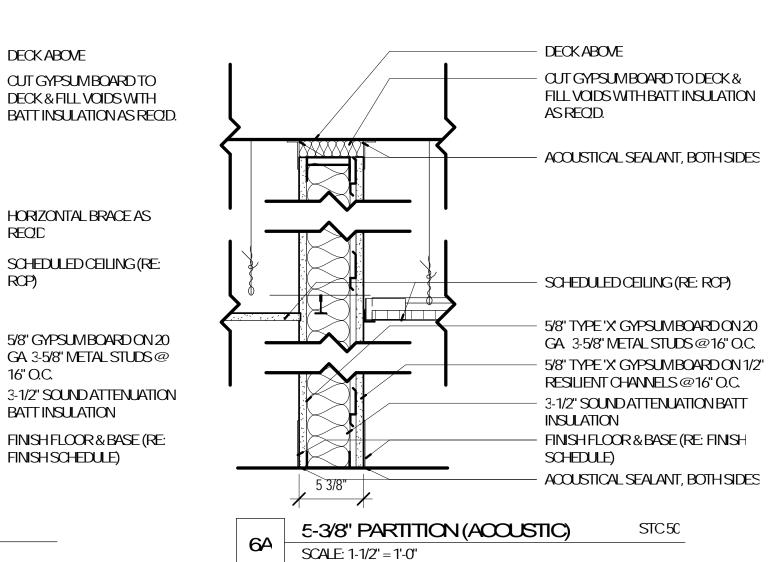

7-3/4" PARTITION (ACCUSTIC)

METAL STUDS

BATT INSULATION

SIMLAR TO TYPE 6a, WITH THE FOLLOWING CHANGES:

USE 20 GA 6" METAL STUDS IN LIEU OF 3-5/8"

USE 5" THERWAFIBER SAFB SOUND ATTENUATION

STC56



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UNON, MD 63084 CONTACT: DAVE VAN LEER T (636) 584-0540 F (636) 584-0512 E-MAIL: DVANLEER@CCCCHRAN.CCCM STRUCTURAL ALPERAUDI, INC. 1804 BORMAN GROLE DRIVE ST. LOUS, MO63146 T (314) 432-8600 F (314) 807-2774 CONTACT: STEVE B-PETT E-MAIL: STEVE.B-RETT@ALPERAUDI.COM MECHANICAL, ELECTRICAL, PLUMBING BRICPARTINERSHIP, LLC 343 S. KIRKWOOD ROAD, SUITE 204 KIRKWOOD, MO63122 T (314) 725-5889 CONTACT: BRUCE COLEMAN

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CONTACT: JAMES STUFFLEBEAM

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ARCHITECT OF RECORD:

JOHN EDWARD MUELLER MOAPOHTECTURAL LICENSE A2010039554 MO CERTIFICATE OF AUTHORITY A2014008380


E: BOOLEMAN@BRICPARTINERSHP.COM


No.	Date	Description				
	04/14/17	ISSUED FOR BID				

DRAWNBY: Author

PROJECT NUMBER: 16-1161.03

SHEETTITLE: PARTITION TYPES

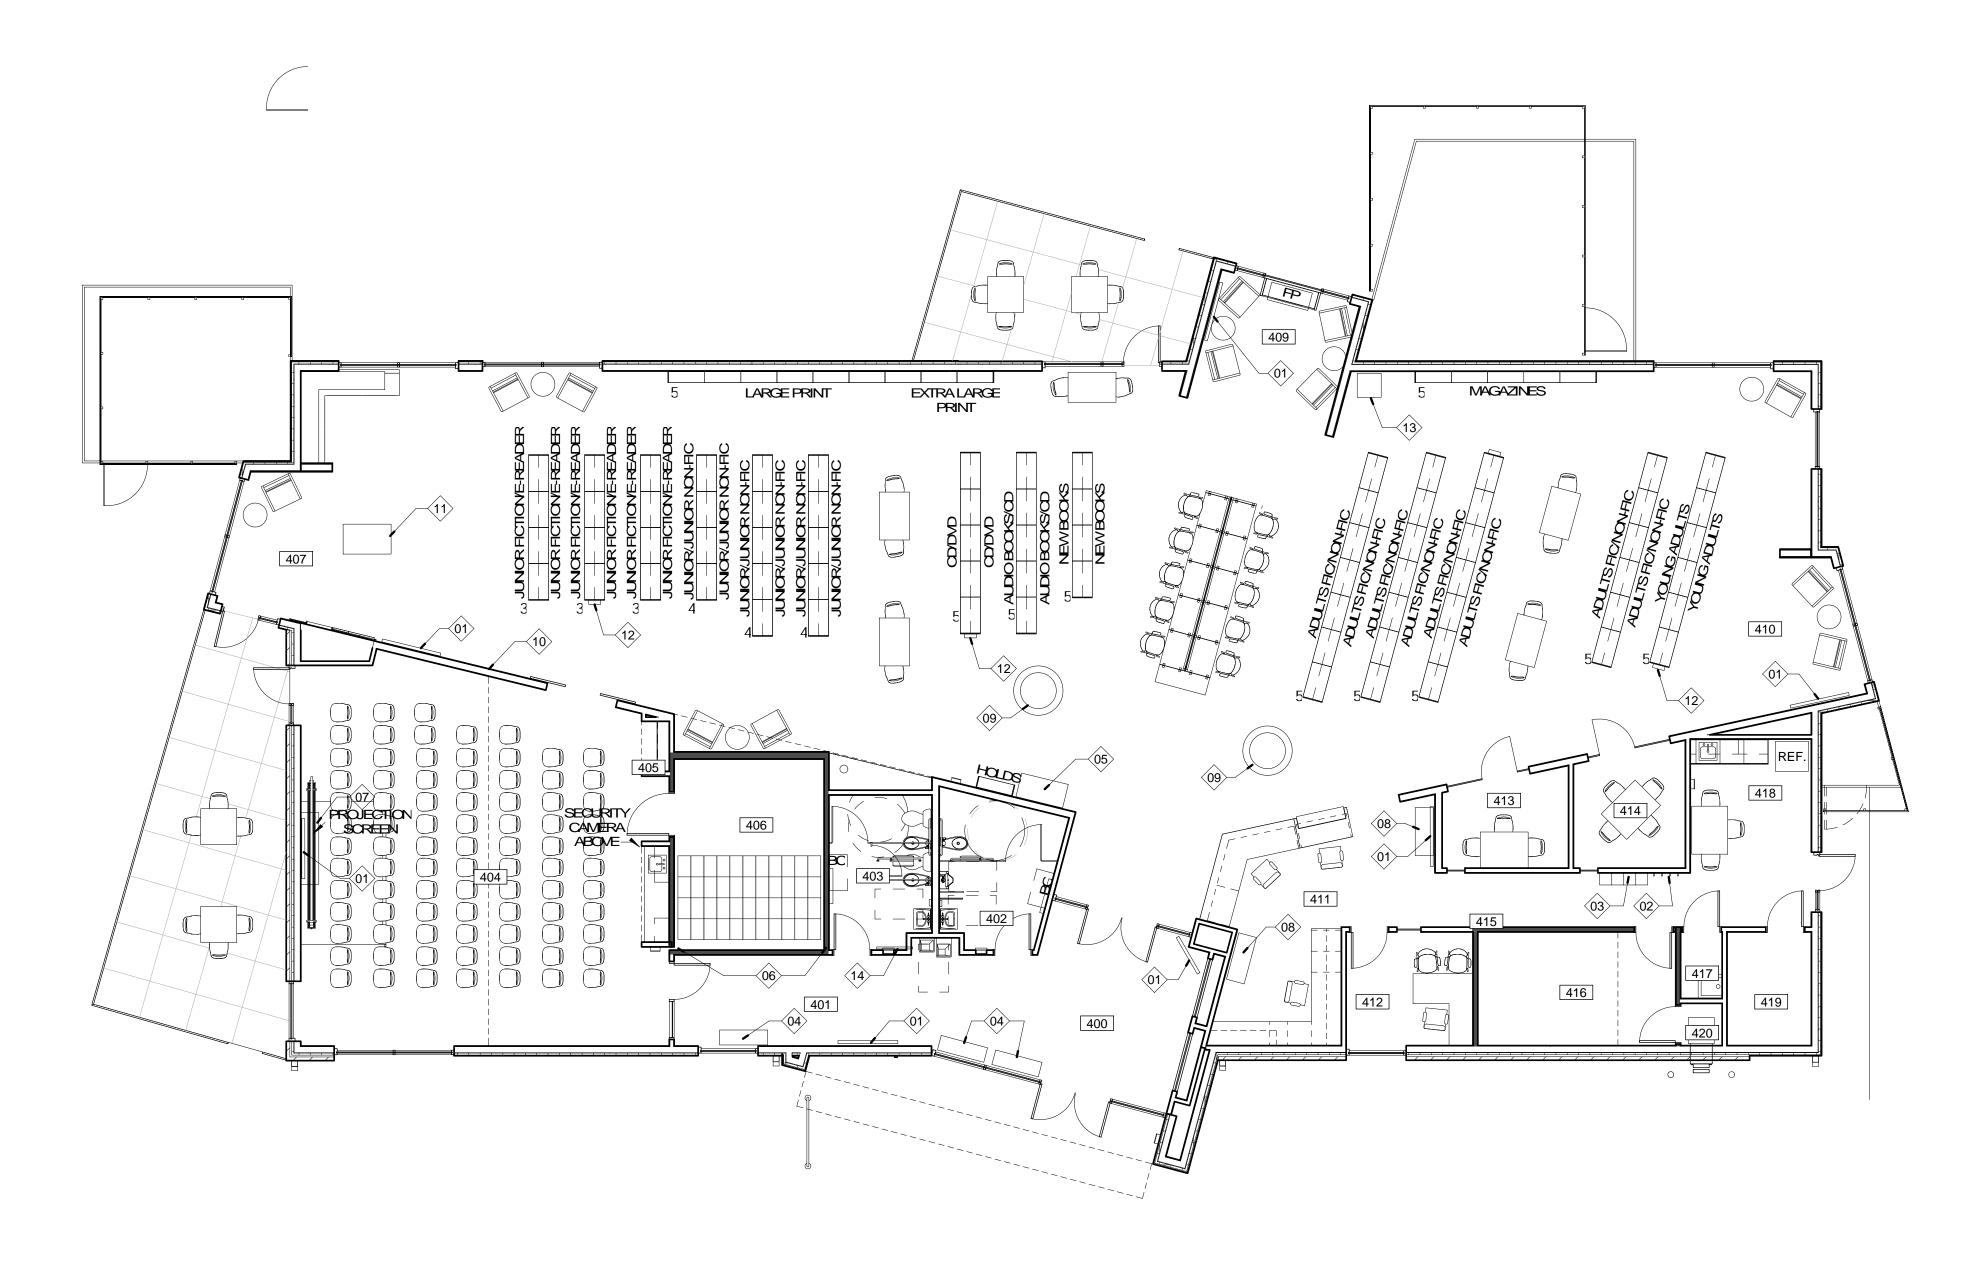

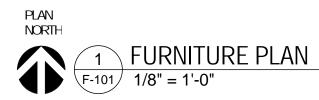

GENERAL NOTES - FURNITURE PLAN

- ALL LIBRARY SHELMING INDICATED IS OFOI, SHOWN FOR REFERENCE.

2.	ALL FURNITURE INDICATED IS OFOI, SHOWN FOR REFERENCE.
3.	ALL APPLIANCES INDICATED ARE OFOI, SHOWN FOR REFERENCE.

17	
Keynote Number	Description
Number	Description
01	WALL-MOUNTED DISPLAY, DISPLAY AND
01	MOUNTING BRACKET OFCI.
02	COAT HOOKS, CFCI, SEE SPECIFICATIONS.
03	LOCKERS, CFCI, SEE SPECIFICATIONS.
04	BENCH, OFOI.
05	SELF SERVE KIOSK, OFOI.
06	DONOR WALL, ALL ITEMS PLAQUES ETC, OFOI.
07	GAMING CABINET, OFOI.
08	CART, OFOI.
09	TIERED BOOK DISPLAY, OFOI.
10	BULLETIN BOARD, OFCI.
11	I-PAD TABLE, OFOI.
12	OPAC UNIT, OFOI.
13	NEWSPAPER DISPLAY, OFOI.
14	LOCKING BULLETING BOARD CABINET, CFC REFER TO SPECS.

Number

401

410 411

416


412 OFFICE

413 STUDY

414 STUDY 415 CORRIDOR

STORAGE

417 JANITORS CLOSET 418 BREAK ROOM 419 MECH/ELEC 420 BOOK DROP

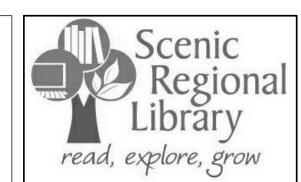

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ARCHITECT OF RECORD:

JOHN EDWARD MUELLER MO ARCHITECTURAL LICENSE A2010039554 MO CERTIFICATE OF AUTHORITY A2014008380

	No.	Date	Description
ROOM SCHEDULE		04/14/17	ISSUED FOR BIL
Name			
VESTIBULE			
CORRIDOR			
MENS			
WOMENS			
MEETING ROOM			
COATS			
STORAGE			
CHILDREN AREA			
CIRCULATION			
ADULT AREA		NBY: SC	/SH
TEEN AREA		•	
WORK ROOM	PROJE	ECT NUMB ET	₹ 16-1161.03

SHEETTITLE: FURNITURE PLAN - FIRST FLOOR

DESIGN CRITERIA

A. CODES AND STANDARDS:

2009 INTERNATIONAL BUILDING CODE (I.B.C.) **BUILDING OCCUPANCY CATEGORY: II**

B. DESIGN LOADS:

SUPERIMPOSED DEAD LOADS:

ROOFING: 3 PSF INSULATION: 4 PSF METAL DECK: 3 PSF CEILINGS: 2 PSF MEP: 4 PSF

SPRINKLER LIVE LOADS: 4 PSF

LIVE LOADS:

MINIMUM LIVE LOAD: 23 PSF

SNOW LOADS:

SNOW LOAD IMPORTANCE FACTOR: I = 1.0 GROUND SNOW LOAD: Pg = 20 PSF FLAT ROOF SNOW LOAD: Pf = 14 PSF SNOW EXPOSURE FACTOR: Ce = 1.0 THERMAL FACTOR: Ct = 1.0

WIND DESIGN DATA:

WIND LOAD IMPORTANCE FACTOR: I = 1.0 BASIC WIND SPEED: 90 MPH WIND EXPOSURE: C INTERNAL PRESSURE COEFFICIENT: +/- 0.18 COMPONENTS AND CLADDING: (0.10 SF): ZONE 1: -19.9 PSF / +10 PSF ZONE 2: -23.0 PSF / +10 PSF ZONE 3: -30.8 PSF / +10 PSF ZONE 4: -18.2 PSF / +16.8 PSF

ZONE 5: -22.4 PSF / +16.8 PSF

SEISMIC DESIGN DATA:

SEISMIC IMPORTANCE FACTOR: I = 1.0 MAPPED SPECTRAL RESPONSE ACCELERATIONS: Ss = 34.2 / S1 = 12.3% SITE CLASS: C SPECTRAL RESPONSE COEFFICIENTS: Sds = 27.4% / Sd1 = 13.7% SEISMIC DESIGN CATEGORY: C BASIC STRUCTURAL SYSTEM: STRUCTURAL STEEL SYSTEM BASIC SEISMIC FORCE-RESISTING SYSTEM(S): STRUCTURAL STEEL SYSTEM NOT SPECIFICALLY DETAILED FOR SEISMIC RESISTANCE. RESPONSE MODIFICATION FACTOR: R = 3

ANALYSIS PROCEDURE USED: EQUIVALENT LATERAL FORCE

DESIGN BASE SHEAR: V = 20K

SEISMIC RESPONSE COEFFICIENT: Cs = 0.091

FOUNDATIONS:

DESIGN:

1. THE FOUNDATION HAS BEEN DESIGNED IN ACCORDANCE WITH THE RECOMMENDATIONS MADE IN THE "SOILS AND FOUNDATION INVESTIGATION" BY COCHRAN, DATED NOVEMBER 2016.

BACKFILLING:

A. DO NOT BACKFILL BASEMENT WALLS AND GRADE BEAMS UNTIL BRACING FLOORS ARE IN PLACE OR ADEQUATE TEMPORARY BRACING IS INSTALLED.

B. BACKFILL UNDER FOUNDATIONS WITH CONCRETE OR AS APPROVED BY GEOTECHNICAL ENGINEER.

SPREAD FOOTINGS:

1. FOOTINGS SHALL BEAR ON FIRM NATURAL SOIL OR ENGINEERED FILL CAPABLE OF SUSTAINING A NET BEARING PRESSURE OF 2000 PSF. UNDER FULL SERVICE LIVE AND DEAD LOADS.

2. TOP OF FOOTING (T/F) ELEVATIONS ARE SHOWN ON THE PLANS.

3. FOOTINGS SHALL BE POURED INTO AN EARTH-FORMED TRENCH U.N.O.. CONTRACTOR TO PROVIDE ADDITIONAL CONCRETE REQUIRED DUE TO SOIL CHARACTERISTICS OR SLOPE OF EXCAVATIONS.

4. ALL BEARING MATERIAL SHALL BE INSPECTED BY THE GEOTECHNICAL ENGINEER PRIOR TO CONCRETE PLACEMENT. THE GEOTECHNICAL ENGINEER SHALL BE THE SOLE JUDGE AS TO THE SUITABILITY OF THE BEARING MATERIAL. FOOTING ELEVATIONS SHALL BE ADJUSTED AS REQUIRED.

5. BOTTOM OF EXTERIOR FOOTINGS SHALL BEAR A MINIMUM OF 30" BELOW FINAL GRADE FOR FROST PROTECTION.

FOUNDATION / RETAINING WALLS:

1. ACTIVE DESIGN PRESSURE IS EQUAL TO AN EQUIVALENT FLUID PRESSURE OF 50 PCF

2. AT-REST DESIGN PRESSURE IS EQUAL TO AN EQUIVALENT FLUID PRESSURE OF 70 PCF

3. PASSIVE DESIGN PRESSURE IS EQUAL TO AN EQUIVALENT FLUID PRESSURE OF 250 PCF

4. SURCHARGE LOADS ARE 100 PSF AT THE SURFACE.

5. COEFFICIENT OF SLIDING FRICTION:

CONCRETE/SOIL = 0.35 (ASSUMED)

6. FOUNDATION WALLS THAT RETAIN EARTH SHALL BE BRACED AGAINST BACKFILLING PRESSURES UNTIL FLOOR SLABS AT TOP AND BOTTOM ARE IN PLACE.

7. WHERE FOUNDATION WALLS ARE TO HAVE EARTH PLACED ON EACH SIDE. PLACE FILL SIMULTANEOUSLY SO AS TO MAINTAIN A COMMON ELEVATION ON EACH SIDE OF THE WALL.

8. DO NOT BACKFILL UNTIL CONCRETE HAS REACHED ITS 28 DAY STRENGTH.

CONCRETE:

 CONCRETE SHALL CONFORM WITH THE REQUIREMENTS SET FORTH IN A.C.I. 301 AND SHALL HAVE A 28-DAY COMPRESSIVE STRENGTH AND DENSITY. IN ACCORDANCE WITH THE FOLLOWING:

28 DAY STRENGTH f'c (K.S.I.)	CONCRETE DENSITY	MAXIMUM W/C (INCLUDING FLY ASH)	MINIMUM CEMENT MATERIAL (#/CY INCLUDING FLY ASH)	MAXIMUM AGGREGATE (IN.)	SLUMP LIMITS (IN.) (+0", -2")	TOTAL AIR LIMITS (%0) (B)	REQUIRED ADMIXTURES (C)
4	145	0.48	564	1	4	-	-
4	145	0.48	564	3/4	4	-	-
4	145	0.40	564	3/4	4	6	AE, WR
4	145	0.50	564	1	4	N	-
4	145	0.40	564	3/4	4	6	-
	4 4 4	4 145 4 145 4 145 4 145	4 145 0.48 4 145 0.48 4 145 0.40 4 145 0.50	4 145 0.48 564 4 145 0.48 564 4 145 0.40 564 4 145 0.50 564	4 145 0.48 564 1 4 145 0.48 564 3/4 4 145 0.40 564 3/4 4 145 0.50 564 1	4 145 0.48 564 1 4 4 145 0.48 564 3/4 4 4 145 0.40 564 3/4 4 4 145 0.50 564 1 4	4 145 0.48 564 1 4 - 4 145 0.48 564 3/4 4 - 4 145 0.40 564 3/4 4 6 4 145 0.50 564 1 4 N

A. FOR MAXIMUM COARSE AGGREGATE SIZE INDICATED, USE THE FOLLOWING AGGREGATE SIZE NUMBERS PER A.S.T.M. C33:

3/8" - #8 AGGREGATE 3/4" - #67 AGGREGATE 1" - #57 AGGREGATE 1 1/2" - #467 AGGREGATE

B. TOTAL AIR CONTENT LIMITS INCLUDE BOTH ENTRAINED AND ENTRAPPED AIR +/- 1 1/2%. "N" IN COLUMN INDICATES ADDITION OF ENTRAINED AIR IS NOT PERMITTED.

C. ABBREVIATIONS FOR REQUIRED ADMIXTURES AS FOLLOWS: AE - AIR-ENTRAINING ADMIXTURE, WR - WATER REDUCING ADMIXTURE

D. MAXIMUM SHRINKAGE FOR SLAB ON GRADE SHALL BE LIMITED TO 5/8" PER 100 FOOT.

2. REINFORCING SHALL CONFORM TO A.S.T.M. A615, GR. 60, INCLUDING TIES AND STIRRUPS. BARS REQUIRING WELDING OR FIELD BENDING SHALL BE A.S.T.M. A706, GRADE 60.

3. WELDED WIRE FABRIC SHALL CONFORM TO A.S.T.M. A185

4. LAP SPLICES SHALL BE IN ACCORDANCE WITH THE FOLLOWING TABLE, UNLESS NOTED OTHERWISE. WHERE CLASSES ARE NOT CALLED OUT ON DRAWINGS, USE CLASS "B" SPLICES.

SPLICES f'c = 4000 P.S.I., fy = 60,000 P.S.I.

	STANDARD TENSION LAP SPLICE, GRADE 60												
							ICE LEN						
f'c = 3,000 P.S.I. f'c = 4,000 P.S.I. f'c = 5,000 P.S.I.													
BAR	CLASS	-	4	E	3	,	4	E	3	-	4	ı	3
SIZE	CASE	1	2	1	2	1	2	1	2	1	2	1	2
#3		16	25	21	32	14	21	18	28	13	19	17	25
#4		22	33	28	43	19	28	25	37	17	25	22	33
#5		27	41	36	53	24	36	31	46	21	32	28	41
#6		33	49	43	64	28	43	37	55	25	38	33	50
#7		48	72	62	93	42	62	54	81	37	56	48	72
#8		55	82	71	107	47	71	62	92	42	64	55	83
#9		62	93	80	120	54	80	70	104	48	72	62	93
#10		70	104	90	136	60	90	78	117	54	81	70	105
#11		77	116	100	151	67	100	87	130	60	90	78	117

"TOP BARS" ARE DEFINED AS ANY BAR WITH MORE THAN 12" OF CONCRETE CAST BELOW THE BAR, SEE NOTE 4 IN TABLE NOTES.

		TABLE NOTES:				
COMPRESSION LAP SCHEDULE						
LAP LENGT	H (INCHES)	1. TABLES ARE BASED A.C.I. 318. WHERE CLEAR SPACING OF BARS BEING DEVELOPED OR SPLICED IS AT LEAST 2 BAR				
f'c = 3,000 P.S.I	. OR GREATER	DIAMETERS AND THE CLEAR COVER AT LEAST 1 BAR DIAMETER,				
BAR SIZE 30 BAR DIA.		USE CASE 1. USE CASE 2 FOR OTHER BAR ARRANGEMENTS.				
#3	12	2. ALL SPLICES TO BE CLASS "B" TENSION SPLICE UNLESS				
#4	15	OTHERWISE NOTED.				
#5	19	3. SPLICE PLAIN WELDED WIRE FABRIC BY LAPPING ONE FULL				
#6	22	MESH SPACE PLUS 2 INCHES.				
#7	26	4. FOR TOP BARS, MULTIPLY LENGTHS IN TABLE BY 1.3.				
#8	29					
#9	33	5. FOR EPOXY COATED REINFORCEMENT, MULTIPLY LENGTHS IN TABLE BY 1.5 FOR COVER LESS THAN 3db OR CLEAR SPACING				
#10	37	LESS THAN 6db, MULTIPLY LENGTHS BY 1.2 FOR ALL OTHER				
#11	41	EPOXY COATED REINFORCEMENT.				
		6. FOR LIGHT WEIGHT CONCRETE, MULTIPLY LENGTHS IN TABLE				

7. COMPRESSION DOWEL EMBEDMENT: 22 BAR DIAMETERS

5. ALL REINFORCING SHALL BE DETAILED, FABRICATED AND PLACED, IN ACCORDANCE WITH THE LATEST EDITION OF THE A.C.I. DETAILING MANUAL.

6. ALL REINFORCING SHALL BE SUPPORTED IN FORMS, SPACED WITH NECESSARY ACCESSORIES AND SHALL BE SECURELY WIRED TOGETHER, IN ACCORDANCE WITH C.R.S.I. "REINFORCING BAR DETAILING", LATEST EDITION.

7. MINIMUM CONCRETE COVER, UNLESS NOTED OTHERWISE:

A. UNFORMED SURFACE IN CONTACT WITH THE GROUND: 3 IN.

B. FORMED SURFACES EXPOSED TO EARTH OR WEATHER: 1 1/2 IN. FOR #5 BAR OR SMALLER, 2 IN. FOR #6 BAR OR LARGER

C. FORMED SURFACES NOT EXPOSED TO EARTH OR WEATHER: WALLS, SLABS: 3/4 IN., BEAMS, GIRDERS AND COLUMNS (TO TIES OR STIRRUPS): 1 1/2 IN.

CONCRETE NOTES (CONT)

8. ALL CONSTRUCTION JOINTS SHOWN ON DRAWINGS SHALL BE INCORPORATED INTO THE STRUCTURE, UNLESS THEIR ELIMINATION IS APPROVED BY THE ENGINEER. ADDITIONAL CONSTRUCTION JOINTS, REQUIRED TO FACILITATE CONSTRUCTION, SHALL BE LOCATED AT POINTS OF MINIMUM SHEAR AND SHALL BE DETAILED ON SHOP DRAWINGS WITH LOCATIONS SUBJECT TO APPROVAL BY ENGINEER. REINFORCEMENT SHALL PASS CONTINUOUSLY THROUGH THE JOINT.

9. ALL ABUTTING CONCRETE MEMBERS SHALL BE DOWELED TOGETHER, UNLESS POURED MONOLITHICALLY. DOWELS SHALL BE EQUAL IN SIZE AND SPACING TO THE REINFORCING IN THE ADJACENT MEMBER.

10. UNLESS OTHERWISE SHOWN IN THE ARCHITECTURAL DRAWINGS, PROVIDE 3/4" CHAMFERS AT ALL EDGES THAT ARE EXPOSED TO VIEW IN THE FINISHED STRUCTURE.

11. SEE ARCHITECTURAL DRAWINGS FOR DOOR AND WINDOW OPENINGS, DRIP SLOTS, REGLETS, MASONRY ANCHORS, PRECAST BEARING LEDGES, BRICK LEDGE ELEVATIONS AND FOR MISCELLANEOUS EMBEDDED PLATES, BOLTS, ANCHORS, ANGLES, ETC.

12. REFER TO ARCHITECTURAL DRAWINGS FOR CONCRETE FINISHES. WHERE FINISH IS NOT SPECIFIED, CONFORM TO REQUIREMENTS OF A.C.I. 301

13. MECHANICAL, PLUMBING, AND ELECTRICAL DRAWINGS SHALL BE REFERRED TO FOR DRAINS, SLEEVES, OUTLET BOXES, CONDUIT, ANCHORS, ETC. THE VARIOUS TRADES ARE RESPONSIBLE FOR PLACING THEIR ITEMS.

14. REFER TO MECHANICAL DRAWINGS FOR HOUSEKEEPING PADS AND INERTIA BASES AT MECHANICAL EQUIPMENT.

15. PROVIDE CONCRETE EQUIPMENT PADS. INERTIA BASES AND CURBS AS NOTED ELSEWHERE IN CONTRACT DOCUMENTS. UNLESS NOTED, DOWEL PADS WITH HOOKED #4 x 0'-6" PROJECTING 3" FROM CONCRETE BELOW AT 18"O.C. EACH WAY. REINFORCE PADS WITH #4@18 EACH WAY, TOP AND BOTTOM, UNLESS OTHERWISE REQUIRED BY EQUIPMENT ANCHORAGE DESIGN.

16. REFER TO MECHANICAL DRAWINGS FOR UNDERFLOOR AND PERIMETER FOUNDATION DRAINS.

17. BASE PLATES, ANCHOR BOLTS, SUPPORT ANGLES, ETC., BELOW GRADE SHALL BE COVERED WITH A MINIMUM OF 3" CONCRETE.

18. PROVIDE CONTINUOUS WATERSTOP AT HORIZONTAL AND VERTICAL JOINTS BELOW GRADE.

19. SHORING OF COMPOSITE BEAMS AND GIRDERS IS THE RESPONSIBILITY OF THE CONCRETE CONTRACTOR. SEE COMPOSITE BEAM AND DECK NOTES FOR SHORING REQUIREMENTS.

20. FILL SLABS INDICATED ON THE STRUCTURAL DRAWINGS SHALL BE REINFORCED WITH 6x6-W1.4xW1.4 W.W.F., UNLESS NOTED OTHERWISE. SEE ARCHITECTURAL DRAWINGS FOR PLAN DIMENSIONS, THICKNESSES, SLOPES TO DRAIN, ETC.

21. WHERE REINFORCING IS NOT INDICATED OR DEFINED, INCLUDE FOR BID PURPOSES ONLY:

A. WALLS: #5 EACH WAY EACH FACE. SPACING IN INCHES = 140 / (WALL THICKNESS IN INCHES) BUT NOT OVER 18"O.C.

B. BEAMS: 1-#9 CONTINUOUS TOP AND BOTTOM FOR EACH 100 SQUARE INCHES OF BEAM CROSS SECTIONAL AREA AND #4 STIRRUPS SPACED AT 1/4 OF BEAM DEPTH FULL LENGTH OF BEAM.

C. COLUMNS: 1-#9 VERTICAL PER 50 SQUARE INCHES OF CROSS SECTIONAL AREA AND #3 TIES @

D. SLABS: #5 EACH WAY TOP AND BOTTOM. SPACING IN INCHES = 100/(SLAB THICKNESS IN INCHES) BUT NOT OVER 18"O.C.

ON SHOP DRAWINGS, INDICATE ABOVE REINFORCING AS "PER GENERAL NOTES". SUCH REINFORCING MAY BE REVISED OR RELOCATED BY STRUCTURAL ENGINEER DURING SHOP DRAWING REVIEW.

22. MASONRY DOWELS: PROVIDE, PLACE, AND SPACE TO MATCH MASONRY REINFORCING.

23. PROVIDE STANDARD HOOKS ON BARS TERMINATING AT A CONCRETE FACE UNLESS NOTED (E.G.: EDGES OF OPENINGS, SLAB EDGES, EXPANSION JOINTS, ENDS OF BEAMS, AND AT: TOP, BOTTOM AND ENDS OF WALLS, ETC...).

24. PROVIDE (2)#5 (MINIMUM) @ EACH SIDE OF OPENING. EXTEND 2'-0" BEYOND OPENINGS.

STRUCTURAL STEEL:

1. STEEL SHALL CONFORM TO THE FOLLOWING GRADES:

ALL WIDE FLANGE (U.N.O.): A992 GRADE 50 (Fy=50) ALL CHANNEL, ANGLE, BASE PLATES, CONNECTION. PLATES (U.N.O.): A36 (Fy=36) STRUCTURAL PIPE: A53 (Fy=35) STRUCTURAL HSS RECTANGULAR TUBE: A500 GRADE B (Fv=46) STRUCTURAL HSS ROUND TUBE: A500 GRADE B (Fy=42)

2. ALL STRUCTURAL STEEL SHALL BE DETAILED, FABRICATED AND ERECTED IN ACCORDANCE WITH THE LATEST EDITION OF THE A.I.S.C. CODE OF STANDARD PRACTICE, EXCEPT AS MODIFIED IN THESE NOTES AND THE PROJECT SPECIFICATIONS.

3. CONNECTIONS MAY BE BOLTED OR WELDED. THE FABRICATOR IS RESPONSIBLE FOR THE DESIGN OF CONNECTIONS NOT DESIGNED ON THE DRAWINGS. GENERALLY, CONNECTIONS SHOWN ON THE STRUCTURAL DRAWINGS ARE SCHEMATIC AND ARE ONLY INTENDED TO SHOW THE RELATIONSHIP OF MEMBERS CONNECTED. ANY CONNECTION THAT IS NOT SHOWN OR IS NOT COMPLETELY DETAILED ON THE STRUCTURAL DRAWINGS SHALL BE DESIGNED BY A PROFESSIONAL ENGINEER, REGISTERED IN THE STATE OF THE PROJECT, RETAINED BY THE FABRICATOR. COMPLETELY DETAILED MEANS THE FOLLOWING INFORMATION IS SHOWN ON THE

A. ALL PLATE DIMENSIONS AND GRADES.

B. ALL WELD SIZES, LENGTHS, PITCHES, AND RETURNS.

C. ALL HOLE SIZES AND SPACINGS.

D. NUMBER AND TYPES OF BOLTS: WHERE BOLTS ARE SHOWN BUT NO NUMBER IS GIVEN, THE CONNECTION HAS NOT BEEN COMPLETELY DETAILED.

E. WHERE PARTIAL INFORMATION IS GIVEN, IT SHALL BE THE MINIMUM REQUIREMENT FOR THE CONNECTION.

PRIOR TO FABRICATION, PROVIDE (FOR RECORD COPY) DESIGN CALCULATIONS FOR TYPICAL BEAM CONNECTIONS, ALL PRIMARY BRACING AND HANGER CONNECTIONS, SIGNED AND SEALED BY A PROFESSIONAL ENGINEER REGISTERED IN THE STATE OF THE PROJECT SHALL BE SUBMITTED TO THE ENGINEER.

STRUCTURAL STEEL (CONT)

4. CONNECTION DESIGN FORCES:

A. UNLESS REACTIONS ARE SHOWN, FACTORED BEAM CONNECTIONS SHALL BE DESIGNED FOR THE GREATER OF:

55% OF MAXIMUM TOTAL UNIFORM LOAD FROM A.I.S.C. 13TH EDITION MAXIMUM TOTAL UNIFORM LOAD TABLES

15 KIPS

B. MOMENT CONNECTIONS INDICATED ON THE DRAWINGS THUS: ---<H>--- DESIGN FOR MOMENT SHOWN OR, IF NOT SHOWN, DEVELOP THE FULL PLASTIC MOMENT CAPACITY OF MEMBER.

C. MAINTAIN TENSION CAPACITY OF COLUMNS, DIAGONALS AND MEMBERS SUBJECT TO TENSION AT BOLT HOLES, NOTCHES, OR COPES.

D. CONNECTION FORCE NOTATION:

P = AXIAL FORCE IN KIPS: (+) TENSION, (-) COMPRESSION VOR[] = SHEAR IN KIPS M = MOMENT IN FOOT KIPS

E. LOADS SHOWN INCLUDE COMPENSATION FOR CODE PERMITTED STRESS INCREASES AND LOAD REDUCTIONS FOR CONNECTION DESIGN.

5. THE MINIMUM PLATE THICKNESS SHALL BE 3/8".

6. BOLTED CONNECTIONS:

T = TORSION IN FOOT KIPS

A. MINIMUM BOLT DIAMETER = 3/4"

B. SLIP CRITICAL CONNECTIONS OF A325SC OR A490SC BOLTS SHALL BE USED FOR ALL BOLTED CONNECTIONS OF BRACING MEMBERS, MOMENT CONNECTIONS, CANTILEVERS, AND AS SHOWN ON THE DRAWINGS. OVERSIZED AND LONG-SLOTTED HOLES ARE ALLOWED FOR SLIP CRITICAL

C. ALL OTHER BOLTED CONNECTIONS SHALL BE BEARING TYPE USING A325N OR A490N BOLTS. OVERSIZED HOLES AND LONG-SLOTTED HOLES ARE NOT ALLOWED UNLESS SHOWN ON THE

D. A307 BOLTS MAY BE USED WHERE INDICATED ON THE DRAWINGS.

E. PROTRUDING BOLT HEADS, SHAFTS OR NUTS SHALL NOT EXTEND INTO NOR PROHIBIT THE APPLICATION OF ARCHITECTURAL FINISHES AND THEY SHALL NOT EXTEND INTO NOR PROHIBIT THE PLACEMENT OF STEEL DECKING TO THE CORRECT LINE AND ELEVATION.

F. THE FABRICATOR IS RESPONSIBLE FOR VERIFYING THE TENSION CAPACITY OF AXIALLY LOADED MEMBERS AFTER A SECTION IS REDUCED FOR BOLT HEADS. MEMBER SIZE MAY BE INCREASED OR CONNECTION PLATES ADDED AS REQUIRED.

G. SHOP DRAWINGS SHALL INDICATE THE TYPE OF BOLT USED IN EACH CONNECTION AND THE ALLOWABLE VALUES USED FOR THE VARIOUS BOLT TYPES.

7. WELDED CONNECTIONS:

A. WELDS ARE CONTINUOUS UNLESS NOTED.

B. ALL FILLET WELDS: A.I.S.C. MINIMUM BUT NOT LESS THAN 1/4" UNLESS NOTED OTHERWISE.

C. ALL WELDING SHALL BE IN ACCORDANCE WITH THE CURRENT "STRUCTURAL WELDING CODE" (A.W.S. D1.1) PUBLISHED BY THE AMERICAN WELDING SOCIETY. ELECTRODES FOR WELDING SHALL COMPLY WITH THE REQUIREMENTS OF TABLE 4.1.1 OF (A.W.S. D1.1).

D. ALL GROOVE WELDS SHALL BE COMPLETE PENETRATION UNLESS NOTED OTHERWISE

8. SPLICING OF STEEL MEMBERS, UNLESS SHOWN ON THE DRAWINGS, IS PROHIBITED WITHOUT WRITTEN APPROVAL OF THE ARCHITECT.

9. NO CHANGE IN SIZE OR POSITION OF THE STRUCTURAL ELEMENTS SHALL BE MADE AND HOLES, SLOTS, CUTS, ETC., ARE NOT PERMITTED THROUGH ANY MEMBER UNLESS THEY ARE DETAILED ON THE APPROVED SHOP DRAWINGS.

10. NO FINAL BOLTING OR WELDING SHALL BE MADE UNTIL AS MUCH OF THE STRUCTURE AS WILL BE STIFFENED THEREBY HAS BEEN PROPERLY ALIGNED.

11. UNLESS NOTED OTHERWISE, BEAMS SHALL BEAR 8" MINIMUM ON CONCRETE OR MASONRY. ANCHOR BEAMS TO MASONRY OR CONCRETE WITH 2-3/4" DIA. ANCHOR BOLTS OR WELDED TO EMBED PLATE.

12. FABRICATE ALL BEAMS WITH THE MILL CAMBER UP.

13. SHEAR STUDS: CONFORM TO A.W.S. D1.1-98, SHOP WELD EXCEPT WHERE APPLIED THROUGH METAL DECK.

14. HEADED STUDS SHALL CONFORM TO A.S.T.M. A108, GRADE 1015, WELDABLE (Fy = 65 K.S.I.).

15. WHERE FIREPROOFING IS REQUIRED, ADJUST FIREPROOFING THICKNESS BASED ON MEMBER SIZES. SEE ARCHITECTURAL DRAWINGS FOR FIREPROOFING REQUIREMENTS AND THICKNESS.

16. THE FABRICATOR IS RESPONSIBLE FOR THE DESIGN AND DETAILING OF STEEL STAIRS. STAIRS SHOWN ON THE STRUCTURAL DRAWINGS ARE SCHEMATIC AND ARE ONLY INTENDED TO SHOW THE RELATIONSHIP OF MEMBERS CONNECTED. STAIRS SHALL BE DESIGNED BY A PROFESSIONAL ENGINEER REGISTERED IN THE STATE OF THE PROJECT, RETAINED BY THE FABRICATOR.



ARCHITECT-OF-RECORD

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STEVEN J. EHRETT MO STRUCTURAL LICENSE E-29025

MO CERTIFICATE OF AUTHORITY 000287

No.	Date	Description
	04/14/17	ISSUED FOR BID

DRAWN BY: TRN

PROJECT NUMBER: 16020

SHEET TITLE:

GENERAL NOTES

METAL ROOF DECK:

- 1. METAL ROOF DECK SHALL COMPLY WITH THE REQUIREMENTS OF THE STEEL DECK INSTITUTE PROJECT SPECIFICATIONS SEE PLANS FOR DECK TYPES AND GAUGES.
- 2. METAL ROOF DECK HAS BEEN DESIGNED TO FUNCTION AS A DIAPHRAGM FOR THE TRANSMISSION OF LATERAL LOADS.
- 3. LAP DECK 4" MINIMUM AT SPLICES CENTERED ON SUPPORT
- 4. DO NOT SUSPEND POINT LOADS FROM DECK INCLUDING HANGERS FOR: CEILINGS, PIPES, DUCTS, EQUIPMENT, ETC... CONTRACTOR INSTALLING SUCH POINT LOADS SHALL PROVIDE SUBFRAMING TO TRANSFER LOAD TO STRUCTURE SUPPORTING DECK.
- 5. FABRICATE DECK UNITS IN LENGTHS TO SPAN THREE OR MORE SUPPORT SPACINGS.
- 6. MINIMUM YIELD STRENGTH = 33 K.S.I.
- 7. METAL DECK SHALL BE ROLLED OF STEEL SHEETS CONFORMING TO A.S.T.M. A1008 GRADE A. NO METAL ROOF DECK SHALL HAVE SECTION PROPERTIES PER FOOT OF WIDTH NOT LESS THAN THAT PROVIDED BY VULCRAFT FOR THE TYPE OF DECK INDICATED.
- 8. DECKING MANUFACTURER SHALL COORDINATE SIZE AND LOCATION OF ROOF OPENINGS WITH ARCHITECTURAL AND MECHANICAL DRAWINGS. PROVIDE FRAMING FOR OPENINGS PER TYPICAL DETAILS

STEEL JOISTS:

- 1. STEEL JOISTS SHALL BE DETAILED, FABRICATED AND ERECTED IN ACCORDANCE WITH "S.J.I." SPECIFICATIONS (LATEST EDITION).
- 2. BRIDGING SHALL BE SPACED IN ACCORDANCE WITH S.J.I. SPECIFICATIONS AND THE ERECTION DRAWINGS OF THE JOIST SUPPLIER. STEEL JOIST BRIDGING SHALL BE PLACED AND JOIST ENDS FIXED PRIOR TO THE APPLICATION OF ANY LOADS. JOIST SUPPLIER SHALL PROVIDE ALL BRIDGING NECESSARY TO ADEQUATELY BRACE THE JOIST TOP CHORD WHERE ROOF CONSTRUCTION IS INSUFFICIENT.
- 3. MINIMUM BEARING REQUIREMENTS, UNLESS NOTED OTHERWISE:
- K SERIES: 2 1/2" ON STRUCTURAL STEEL
- LH & DLH SERIES: 4" ON STRUCTURAL STEEL
- 4. UNLESS NOTED OTHERWISE, JOISTS SHALL BE ATTACHED TO SUPPORTING STEEL WORK AS FOLLOWS.
- K SERIES: TWO 1/8" FILLET WELDS (ONE EACH SIDE) 2" LONG OR EQUIVALENT. LH & DLH SERIES: TWO 1/4" FILLET WELDS (ONE EACH SIDE) 2" LONG OR EQUIVALENT.
- 5. JOISTS, AT COLUMN CENTERLINES, SHALL BE BOLTED TO STRUCTURAL STEEL BEAMS PER S.J.I. REQUIREMENTS.
- 6. SEE DETAILS FOR ATTACHMENT OF JOISTS TO CONCRETE AND MASONRY.
- 7. BRIDGING THAT TERMINATES AT, OR IS INTERRUPTED BY, STRUCTURAL STEEL BEAMS, SHALL BE ATTACHED THERETO BY FIELD WELDING OR BOLTING. SEE DRAWINGS FOR DETAIL OF ATTACHMENT OF BRIDGING TO CONCRETE OR MASONRY.
- 8. JOISTS SHALL BE STOCKPILED AT THE JOBSITE IN A VERTICAL POSITION, RESTING ON THEIR TOP OR BOTTOM CHORDS, AND SHALL BE ADEQUATELY SUPPORTED WITH WOOD BLOCKING. KEEP JOISTS FREE OF MUD AND DIRT.
- 9. IT SHALL BE THE ERECTOR'S RESPONSIBILITY TO SEE THAT JOISTS WHICH ARE DAMAGED, KINKED, BENT, OR WITH BROKEN WELDS, ARE NOT PLACED IN THE STRUCTURE.
- 10. JOIST SUPPLIER SHALL DESIGN JOISTS AND SUBMIT CALCULATIONS, STAMPED AND SIGNED BY A PROFESSIONAL ENGINEER IN THE STATE OF THE PROJECT FOR RECORD COPY TO BUILDING DEPARTMENT AND ENGINEER OF RECORD PRIOR TO FABRICATION OF JOISTS. THE ABOVE CALCULATIONS TO INCLUDE ALL LOADING CONDITIONS SHOWN ON THE DRAWINGS AND DETAILS.
- 11. JOIST ENDS, AT ROOF DIAPHRAGM BOUNDARIES, SHALL BE CAPABLE OF TRANSMITTING THE BOUNDARY SHEAR TO THE SUPPORTING STRUCTURE. SEE DETAILS.
- 12. THE JOIST DESIGN AND BRIDGING PLACEMENT SHALL BE CHECKED BY THE JOIST MANUFACTURER USING THE NET UPLIFT SPECIFIED ON THE DRAWINGS. CHANGES IN JOIST SIZE AND/OR BRIDGING PLACEMENT WILL SHOW UP ON THE SHOP DRAWINGS.
- 13. LOCATE PIPE AND EQUIPMENT HANGERS AND OTHER CONCENTRATED LOADS ONLY WHERE LOADS ARE SHOWN ON JOIST SHOP DRAWINGS. ATTACHMENT METHOD AS APPROVED BY JOIST MANUFACTURER.
- 14. ALL HOLES IN SUPPORTING STEEL PROVIDED FOR JOIST ERECTION SHALL BE "FILLED" WITH APPROPRIATE DIAMETER BOLT OR PLUG WELDED. HOLES IN SUPPORTING STEEL SHALL NOT BE SLOTTED.

POST-INSTALLED MECHANICAL ANCHORS:

- 1. POST-INSTALLED MECHANICAL ANCHORS SHALL ONLY BE USED WHERE SPECIFIED ON THE DRAWINGS. THE CONTRACTOR SHALL OBTAIN APPROVAL FROM THE ENGINEER OF RECORD PRIOR TO USING POST-INSTALLED ANCHORS FOR MISSING OR MISPLACED CAST-IN ANCHORS. CARE SHALL BE GIVEN TO AVOID CONFLICTS WITH EXISTING REBAR. HOLES SHALL BE DRILLED AND CLEANED PER THE MANUFACTURER'S INSTRUCTIONS. DO NOT CUT EXISTING REINFORCING.
- 2. THE CONTRACTOR SHALL ARRANGE AN ANCHOR MANUFACTURER'S REPRESENTATIVE TO PROVIDE ONSITE INSTALLATION TRAINING FOR ALL OF THEIR ANCHORING PRODUCTS SPECIFIED. THE STRUCTURAL ENGINEER OR RECORD MUST RECEIVE DOCUMENTED CONFIRMATION THAT ALL OF THE CONTRACTOR'S PERSONNEL WHO INSTALL ANCHORS ARE TRAINED PRIOR TO THE COMMENCEMENT OF INSTALLING ANCHORS.
- 3. UNLESS SPECIFIED OTHERWISE, ANCHORS SHALL BE EMBEDDED IN THE APPROPRIATE SUBSTRATE WITH A MINIMUM EMBEDMENT OF 8 TIMES THE NOMINAL ANCHOR DIAMETER OR THE EMBEDMENT DEPTH REQUIRED TO SUPPORT THE INTENDED LOAD. SUBSTITUTION REQUESTS, FOR PRODUCTS OTHER THAN THOSE LISTED BELOW, SHALL BE SUBMITTED TO THE ENGINEER WITH CALCULATIONS THAT ARE PREPARED AND SEALED BY A PROFESSIONAL ENGINEER, REGISTERED IN THE STATE WHERE PROJECT IS LOCATED, SHOWING THAT THE SUBSTITUTED PRODUCTS WILL ACHIEVE AN EQUIVALENT CAPACITY.
- 4. UNLESS OTHERWISE NOTED IN THE DETAILS, ANCHORS SHALL BE:
- A. CONCRETE EXPANSION ANCHORS:
- ALL CONCRETE EXPANSION ANCHORS SHALL MEET THE REQUIREMENTS OF A.C.I. 318, APPENDIX D AND SHALL BE ACCEPTABLE FOR BOTH CRACKED AND UN-CRACKED CONCRETE.
- "STRONG-BOLT" BY SIMPSON STRONG-TIE CO. (ICC-ES ESR-1771)
 "KWIK BOLT TZ" BY HILTI, INC. (ICC-ES ESR-1917)
 "HSL HEAVY DUTY SLEEVE ANCHOR" BY HILTI, INC. (ICC-ES ESR-1545)
 "HDA UNDERCUT ANCHOR" BY HILTI, INC. (ICC-ES ESR-1546)
 "KWIK BOLT 3" BY HILTI, INC. UNCRACKED ONLY (ICC-ES ESR-2302)
- B. GROUTED MASONRY EXPANSION ANCHORS:
- "WEDGE-ALL" BY SIMPSON STRONG-TIE CO. (ICC-ES ESR-1396)
 "KWIK BOLT 3" BY HILTI, INC. (ICC-ES ESR-1385)
- ADHERE TO MANUFACTURES REQUIREMENTS FOR ANCHOR SPACING AND LOCATIONS
- C. CONCRETE SCREW ANCHORS:
- ALL SCREW ANCHORS SHALL BE INSTALLED IN DRY, INTERIOR NON-CORROSIVE ENVIRONMENTS OR FOR TEMPORARY OUTDOOR APPLICATIONS.
- "TITEN HD" BY SIMPSON STRONG-TIE CO. (ICC-ES ESR-2713) CRACKED AND UN-CRACKED CONCRETE
- "KWIK HUS EZ AND EZ-1" BY HILTI, INC. (ICC-ES ESR-3027)
- D. MASONRY SCREW ANCHORS:
- ALL SCREW ANCHORS SHALL BE INSTALLED IN DRY, INTERIOR NON-CORROSIVE ENVIRONMENTS OR FOR TEMPORARY OUTDOOR APPLICATIONS.
- "TITEN HD" BY SIMPSON STRONG-TIE CO. (ICC-ES ESR-2713)
 "HUS-H SCREW ANCHOR" BY HILTI, INC. (ICC-ES ESR-2369)
- E. SPECIAL INSPECTION SHALL BE PROVIDED IN ACCORDANCE WITH THE ICC-ES REPORT AND AS PRESCRIBED BY THE APPLICABLE BUILDING CODE.

POST-INSTALLED ADHESIVE ANCHORS:

- 1. POST-INSTALLED ADHESIVE ANCHORS SHALL ONLY BE USED WHERE SPECIFIED ON THE DRAWINGS. THE CONTRACTOR SHALL OBTAIN APPROVAL FROM THE ENGINEER OF RECORD PRIOR TO USING POST-INSTALLED ANCHORS FOR MISSING OR MISPLACED CAST-IN ANCHORS. CARE SHALL BE GIVEN TO AVOID CONFLICTS WITH EXISTING REBAR. HOLES SHALL BE DRILLED AND CLEANED PER THE MANUFACTURER'S INSTRUCTIONS. DO NOT CUT EXISTING REINFORCING.
- 2. THE CONTRACTOR SHALL ARRANGE AN ANCHOR MANUFACTURER'S REPRESENTATIVE TO PROVIDE ONSITE INSTALLATION TRAINING FOR ALL OF THEIR ANCHORING PRODUCTS SPECIFIED. THE STRUCTURAL ENGINEER OF RECORD MUST RECEIVE DOCUMENTED CONFIRMATION THAT ALL OF THE CONTRACTOR'S PERSONNEL WHO INSTALL ANCHORS ARE TRAINED PRIOR TO THE COMMENCEMENT OF INSTALLING ANCHORS.
- 3. ADHESIVE ANCHOR SYSTEMS IN CONCRETE MUST COMPLY WITH THE LATEST REVISION OF ICCES ACCEPTANCE CRITERIA AC308 AND HAVE A VALID ICC-ES REPORT IN ACCORDANCE WITH THE APPLICABLE BUILDING CODE. ACCEPTABLE ADHESIVE ANCHOR SYSTEMS IN CONCRETE ARE LISTED BELOW:
- "HIT-HY 200SAFE SET" BY HILTI, INC. (ICC-ES ESR-3187)
- "HIT RE 500-SD" BY HILTI, INC. (ICC-ES ESR-2322) CRACKED AND UN-CRACKED CONCRETE
 "SET-XP EPOXY" BY SIMPSON STRONG-TIE CO. (ICC-ES ESR-2508) CRACKED AND UN-CRACKED
 CONCRETE
- ADHESIVE ANCHORS SHALL CONSIST OF AN INSERT AND AN ADHESIVE FORMULA. INSERTS SHALL MEET THE REQUIREMENTS OF A.S.T.M. A307, A36, A193-B7, OR F1554 FOR THREADED RODS OR A.S.T.M. A615 OR A706 FOR REBAR UNLESS NOTED OTHERWISE.
- ALL ADHESIVE ANCHORS SHALL BE ACCEPTABLE FOR LONG TERM LOADING ONLY. NON-EPOXY BASED ADHESIVES SHALL BE USED WHEN BASE MATERIAL TEMPERATURES ARE BELOW 40 DEG F.
- 4. ADHESIVE ANCHOR SYSTEMS IN GROUTED MASONRY MUST COMPLY WITH THE LATEST REVISION OF ICC-ES AND HAVE A VALID ICC-ES REPORT IN ACCORDANCE WITH THE APPLICABLE BUILDING CODE. ACCEPTABLE ADHESIVE ANCHOR SYSTEMS ARE LISTED BELOW:
- "HIT-HY 70" BY HILTI, INC. (ICC-ES ESR-PENDING)
- "SET EPOXY" BY SIMPSON STRONG-TIE CO. (ICC-ES ESR-1772)
 ADHERE TO MANUFACTURES REQUIREMENTS FOR ANCHOR SPACING AND LOCATIONS.
- 5. DRILLING SHALL BE PERFORMED WITH A ROTARY HAMMER DRILL AND CARBIDE TIPPED DRILL BIT IN ACCORDANCE WITH INSTRUCTIONS ACCOMPANYING ADHESIVE CARTRIDGES AND APPLICABLE ICC-ESR.
- 6. BORE HOLE CLEANING PROCEDURES MUST COMPLY WITH INSTRUCTIONS ACCOMPANYING THE ADHESIVE CARTRIDGE AND APPLICABLE ICC-ESR IN ORDER TO PRODUCE A DRY, DUST-FREE HOLE
- 7. INJECTION OF ADHESIVE SHALL BE PREFORMED IN ACCORDANCE WITH MANUFACTURER'S INSTRUCTIONS ACCOMPANYING PRODUCT AND APPLICABLE ICC-ESR TO PRODUCE AN AIR-VOID
- 8. ALTERNATE DRILLING METHODS, SUCH AS DIAMOND CORING, MUST BE APPROVED BY THE ENGINEER OF RECORD AND COMPLY WITH THE APPLICABLE ICC-ES REPORT.
- 9. SPECIAL CONDITIONS SUCH AS WATER SATURATED CONCRETE, WATER-FILLED HOLES, UNDERWATER AND OVERHEAD INSTALLATIONS MUST BE APPROVED BY THE ENGINEER OF RECORD AND COMPLY WITH THE APPLICABLE ICC-ES REPORT.
- 10. SPECIAL INSPECTION SHALL BE PROVIDED IN ACCORDANCE WITH THE ICC-ES REPORT AND AS PRESCRIBED BY THE APPLICABLE BUILDING CODE.
- 11. FASTENING ELEMENTS (THREADED RODS, REBAR AND INTERNALLY THREADED INSERTS) MUST BE CLEAN, DRY AND FREE OF ANY OIL OR CONTAMINANTS.
- 12. OVERHEAD ADHESIVE ANCHORS MUST BE INSTALLED USING HILTI PROFI SYSTEM.

DEFERRED SUBMITTALS:

FREE INJECTION.

- 1. THE FOLLOWING PROJECT COMPONENTS REQUIRE DESIGN TO BE PROVIDED BY A QUALIFIED PROFESSIONAL ENGINEER, LICENSED IN THE STATE OF THE PROJECT:
- A. CONNECTION DESIGN FOR BRACED FRAMES, MOMENT FRAMES, COLLECTOR BEAMS AND TYPICAL SHEAR CONNECTIONS.
- B. STRUCTURAL LIGHT GAUGE STEEL FRAMING CALCULATIONS AND DETAILS.

MISCELLANEOUS:

- 1. STRUCTURAL DRAWINGS ARE INTENDED TO BE USED WITH ARCHITECTURAL AND MECHANICAL DRAWINGS. CONTRACTOR IS RESPONSIBLE FOR COORDINATING SUCH REQUIREMENTS INTO THEIR SHOP DRAWINGS AND WORK.
- 2. NO OPENING SHALL BE MADE IN ANY STRUCTURAL MEMBER WITHOUT THE WRITTEN APPROVAL OF THE ARCHITECT.
- 3. NO CHANGE IN SIZE OR DIMENSION OF STRUCTURAL MEMBERS SHALL BE MADE WITHOUT THE WRITTEN APPROVAL OF THE ARCHITECT.
- 4. OPENINGS 1'-4" AND LESS ON A SIDE ARE GENERALLY NOT SHOWN ON THE STRUCTURAL DRAWINGS. REFER TO ARCHITECTURAL AND MECHANICAL DRAWINGS FOR SUCH OPENINGS.
- 5. THE CONTRACTOR IS RESPONSIBLE FOR LIMITING THE AMOUNT OF CONSTRUCTION LOAD IMPOSED UPON STRUCTURAL FRAMING. CONSTRUCTION LOADS SHALL NOT EXCEED THE DESIGN CAPACITY OF THE FRAMING AT THE TIME THE LOADS ARE IMPOSED.
- 6. THE STRUCTURE IS DESIGNED TO FUNCTION AS A UNIT UPON COMPLETION. THE CONTRACTOR IS RESPONSIBLE FOR FURNISHING ALL TEMPORARY BRACING AND/OR SUPPORT THAT MAY BE REQUIRED AS THE RESULT OF THE CONTRACTOR'S CONSTRUCTION METHODS AND/OR SEQUENCES.
- 7. UNLESS OTHERWISE NOTED, FIRE PROOFING METHODS AND MATERIALS FOR STRUCTURAL MEMBERS ARE NOT SHOWN ON STRUCTURAL DRAWINGS. REFER TO ARCHITECTURAL DRAWINGS AND SPECIFICATIONS FOR FIRE RATING REQUIREMENTS, FIRE PROOFING METHODS AND
- 8. DO NOT SCALE THESE DRAWINGS, USE DIMENSIONS.
- 9. CONTRACTOR'S CONSTRUCTION AND/OR ERECTION SEQUENCES SHALL RECOGNIZE AND CONSIDER THE EFFECTS OF THERMAL MOVEMENTS OF STRUCTURAL ELEMENTS DURING THE CONSTRUCTION PERIOD. EXPANSION JOINTS SHOWN ON THE DRAWINGS HAVE BEEN DESIGNED TO ACCOMMODATE ANTICIPATED THERMAL MOVEMENT AFTER THE BUILDING IS COMPLETE.
- 10. THE CONTRACTOR SHALL INFORM THE ARCHITECT IN WRITING OF ANY DEVIATION FROM THE CONTRACT DOCUMENTS. THE CONTRACTOR SHALL NOT BE RELIEVED OF THE RESPONSIBILITY FOR SUCH DEVIATION BY THE ARCHITECT'S APPROVAL OF SHOP DRAWINGS, PRODUCT DATA, ETC. UNLESS HE HAS SPECIFICALLY INFORMED THE ARCHITECT OF SUCH DEVIATION AT THE TIME OF SUBMISSION, AND THE ARCHITECT HAS GIVEN WRITTEN APPROVAL TO THE SPECIFIC DEVIATION.
- 11. ALL THINGS WHICH, IN THE OPINION OF THE CONTRACTOR, APPEAR TO BE DEFICIENCIES, OMISSIONS, CONTRADICTIONS, OR AMBIGUITIES, IN THE PLANS AND SPECIFICATIONS SHALL BE BROUGHT TO THE ATTENTION OF THE ARCHITECT. PLANS AND/OR SPECIFICATIONS WILL BE CORRECTED, OR WRITTEN INTERPRETATION OF THE ALLEGED DEFICIENCY, OMISSION, CONTRADICTION OR AMBIGUITY WILL BE MADE BY THE ARCHITECT BEFORE THE AFFECTED WORK PROCEEDS.
- 12. CHECK ALL DIMENSIONS AGAINST REQUIREMENTS OF OTHER CONTRACT DOCUMENTS. FIELD VERIFY DIMENSIONS RELATING TO EXISTING CONDITIONS PRIOR TO ORDERING MATERIALS AND FABRICATION.
- 13. WHERE DIMENSIONS OR WEIGHTS OF EQUIPMENT OR SYSTEMS ARE VARIABLE FROM MANUFACTURER TO MANUFACTURER, VERIFY DIMENSIONS AND WEIGHTS SHOWN ON DRAWINGS WITH SELECTED MANUFACTURER PRIOR TO ORDERING MATERIALS. NOTIFY STRUCTURAL ENGINEER OF DISCREPANCIES.
- 14. DO NOT PLACE EQUIPMENT WHEN SHIPPING OR OPERATING WEIGHT EXCEEDS WEIGHT INDICATED ON STRUCTURAL DRAWINGS.
- 15. NO MODIFICATION, ALTERATION OR REPAIR SHALL BE MADE WITHOUT PRIOR REVIEW BY STRUCTURAL ENGINEER. SUBMIT DETAILS AND CALCULATIONS PREPARED BY A PROFESSIONAL ENGINEER REGISTERED IN STATE WHERE PROJECT IS LOCATED AND EMPLOYED BY CONTRACTORS.
- 16. VERIFY ELEVATOR AND ESCALATOR PIT DIMENSIONS, LOCATIONS, LOADINGS AND DETAILS WITH SUPPLIERS PRIOR TO THE FABRICATION AND/OR INSTALLATION OF ANY MATERIAL.

SPECIAL INSPECTION:

THE FOLLOWING STRUCTURAL ELEMENTS OF CONSTRUCTION SHALL REQUIRE SPECIAL INSPECTION PER I.B.C. SECTION 1704. CONTRACTOR TO FURNISH INSPECTION UNLESS INSTRUCTED OTHERWISE BY THE CONSTRUCTION CONTRACT.

TYPE OF CONSTRUCTION	IBC SECTION	IBC TABLE
INSPECTION OF FABRICATOR	1704.2	-
STEEL CONSTRUCTION	1704.3	1704.3
CONCRETE	1704.4	1704.4
SOILS	1704.7	1704.4

ADHESIVE ANCHORS SHALL BE INSPECTED PER THE REQUIREMENTS IN THEIR ICC-ES REPORTS

MECHANICAL ANCHORS SHALL BE INSPECTED PER THE REQUIREMENTS IN THEIR ICC-ES REPORTS

NOTES:

- 1. SPECIAL INSPECTION IS NOT A SUBSTITUTE FOR INSPECTION BY A CITY INSPECTOR. SPECIALLY INSPECTED WORK WHICH IS INSTALLED OR COVERED WITHOUT THE APPROVAL OF THE CITY INSPECTOR IS SUBJECT TO REMOVAL OR EXPOSURE.
- 2. THE SPECIAL INSPECTORS MUST BE CERTIFIED BY THE CITY TO PERFORM THE TYPES OF INSPECTION SPECIFIED.
- 3. IT IS THE RESPONSIBILITY OF THE CONTRACTOR TO INFORM THE SPECIAL INSPECTOR OR INSPECTION AGENCY AT LEAST ONE WORKING DAY PRIOR TO PERFORMING ANY WORK THAT REQUIRES SPECIAL INSPECTION. ANY WORK PERFORMED WITHOUT REQUIRED SPECIAL INSPECTION IS SUBJECT TO REMOVAL.
- 4. SUBMIT WRITTEN REPORTS WITHIN TWO DAYS OF TESTING TO ENGINEER OF RECORD.



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ENGINEER OF RECORD:

STEVEN J. EHRETT MO STRUCTURAL LICENSE E-29025 MO CERTIFICATE OF AUTHORITY 000287

No.	Date	Description
	04/14/17	ISSUED FOR BID


DRAWN BY: **TRN**

SHEET TITLE:

GENERAL NOTES

PROJECT NUMBER: 16020

S-101

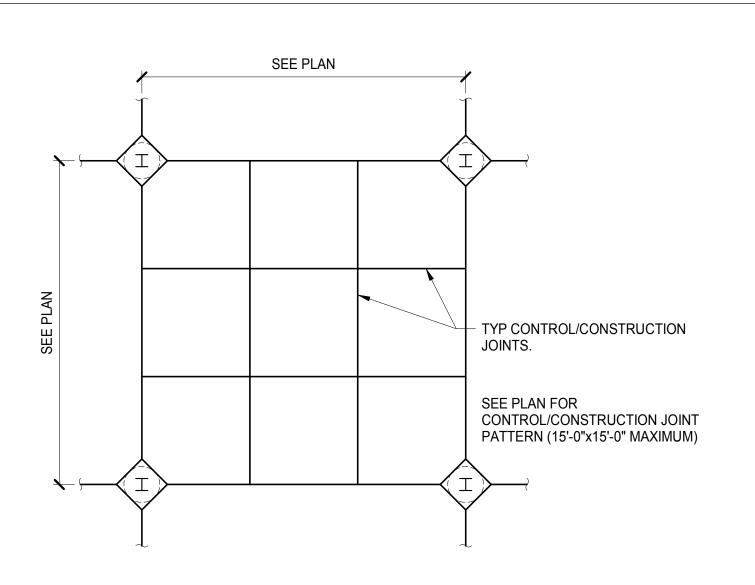

- 3/4"ØX16" LONG SMOOTH DOWELS @ 12"OC CENTERED IN SLAB - COAT ONE END TO PREVENT BOND SLAB ON GRADE **CONSTRUCTION JOINT** CONTROL JOINT AT CONTRACTORS OPTION UNLESS NOTED OTHERWISE. - SLAB ON GRADE

1. CONSTRUCTION AND/OR CONTROL JOINTS ARE INTERCHANGEABLE AT THE CONTRACTORS OPTION. SEE PLANS FOR JOINT LOCATIONS.


2. SAW CUTTING OF JOINTS SHALL BE DONE AS THE CONCRETE SETS SUFFICIENTLY TO PERMIT CUTTING WITHOUT CHIPPING, SPALLING OR TEARING, BUT NOT MORE THAN 24 HOURS AFTER PLACING.

3. REINFORCEMENT TO STOP 2" CLEAR OF CONSTRUCTION JOINTS OR STRIPPABLE CONTROL JOINTS. AT SAW CUT JOINTS, CUT REINFORCEMENT OR STOP 2" CLEAR OF JOINT.

4. JOINTS SHALL DIVIDE SLAB INTO AREAS AS SAW CUT OR STRIPPABLE SQUARE AS POSSIBLE (1.5 TO 1 MAXIMUM L x W RATIO) WITH A MAXIMUM JOINT SPACING OF 15'-0",

> 5. 1 1/2" IF "D" IS LESS THAN OR EQUAL TO 9", D/3 IF "D" IS GREATER THAN 9", D/3 IF REINFORCED.

6. IF SLAB AREA IS UNDEFINED ON PLAN OR IF AN ALTERNATE JOINT PATTERN IS REQUESTED, THE CONTRACTOR SHALL SUBMIT A LOCATION PLAN FOR APPROVAL.

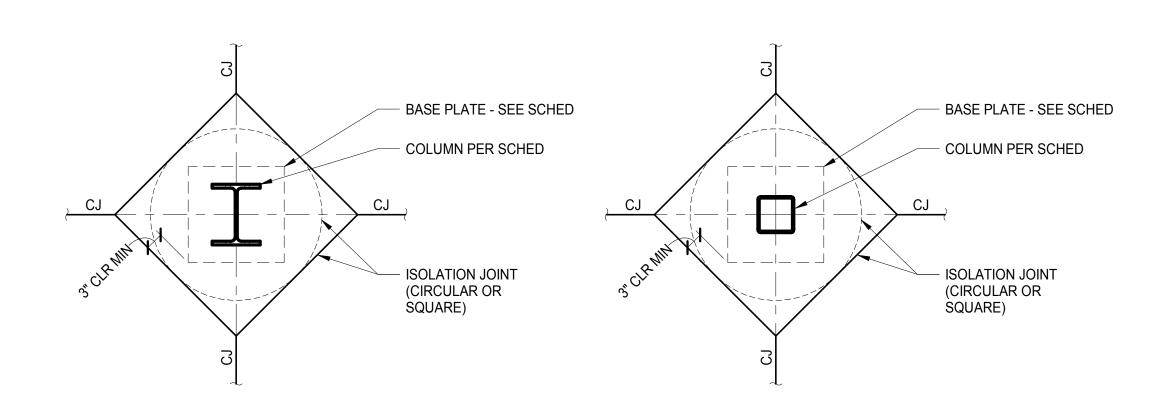



TYPICAL SLAB CONTROL AND CONSTRUCTION JOINT DETAIL S-102 N.T.S.

2 TYPICAL SLAB ON GRADE DETAIL S-102 N.T.S.

CONTROL JOINT

(3) TYPICAL COLUMN ISOLATION JOINT DETAIL S-102 N.T.S.

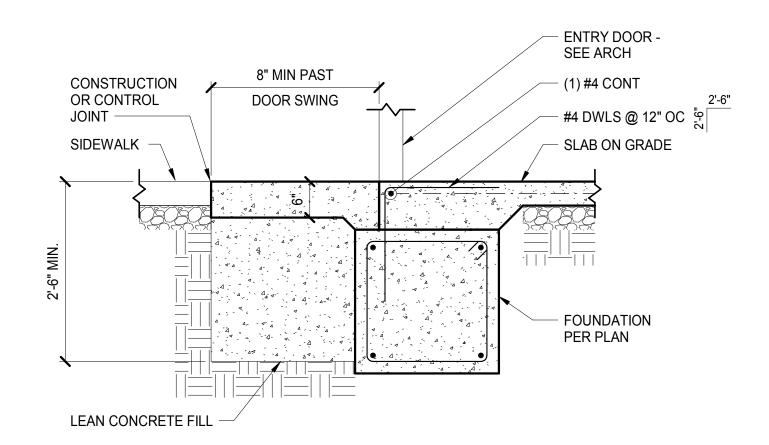

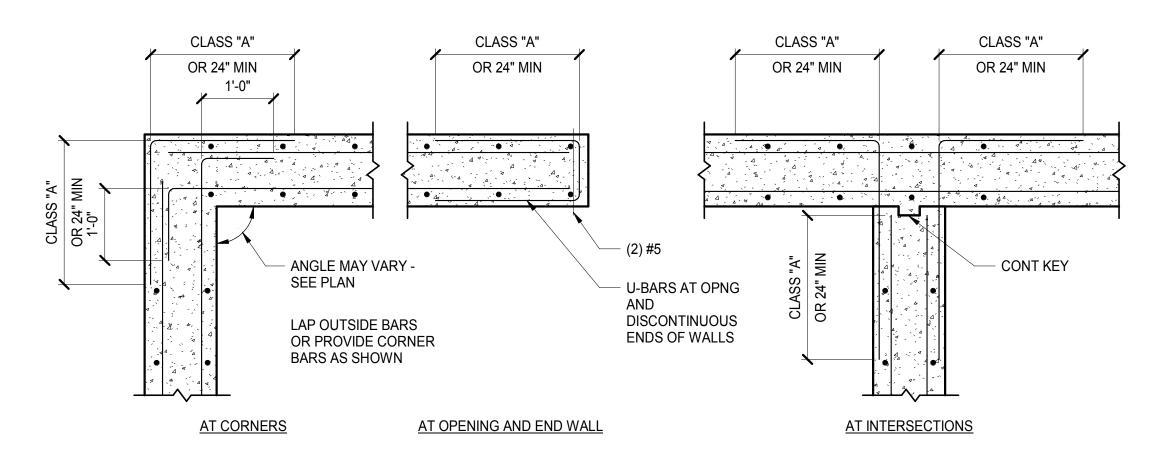

S-102 N.T.S.


AND CORNERS OF CONTINUOUS FOOTINGS, GRADE BEAMS, AND WALLS DETAIL

S-102 N.T.S.

BEAM CONNECTION SCHEDULE MINIMUM NUMBER OF ROWS OF 3/4"Ø **BEAM SIZE** A-325N BOLTS (UNO) W8 AND W10 W12 AND W14 W16 W18 W21 W24 W30

NO	<u>ES:</u>
ENC	ABLE INDICATES MINIMUM VALUES. CONNECTION INEER TO PROVIDE CALCULATIONS FOR ALL SHEAR NECTIONS.

W33

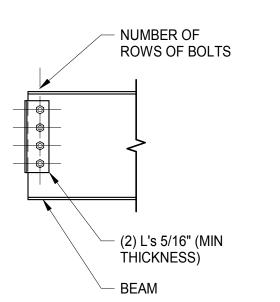


	TYPICAL BOLTS PER	
6	CONNECTION DETAIL	
S-102	3/4" = 1'-0"	

BEAM CONNECTION SCHEDULE					
BEAM SIZE	MINIMUM NUMBER OF ROWS OF 3/4"Ø A-325N BOLTS (UNO)	WELD SIZE (IN) MINIMUM	PLATE THICKNESS (T) (IN) MINIMUM		
W8 AND W10	2	1/4	5/16		
W12 AND W14	3	1/4	5/16		
W16	4	1/4	5/16		
W18	5	5/16	3/8		
W21	6	5/16	3/8		
W24 AND W27	7	3/8	7/16		
W30	8	3/8	7/16		
W33 AND W36	9	3/8	7/16		

NOTES:

1. TABLE INDICATES MINIMUM VALUES. CONNECTION ENGINEER TO PROVIDE CALCULATIONS FOR ALL SHEAR CONNECTIONS.

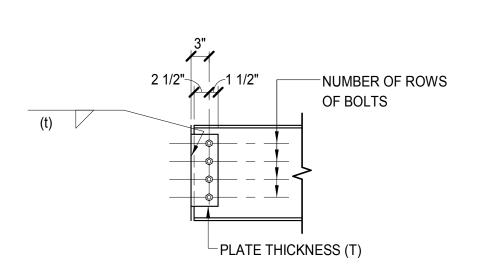

TYPICAL SINGLE SHEAR TAB CONNECTION DETAIL S-102 3/4" = 1'-0"



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ENGINEER OF RECORD:


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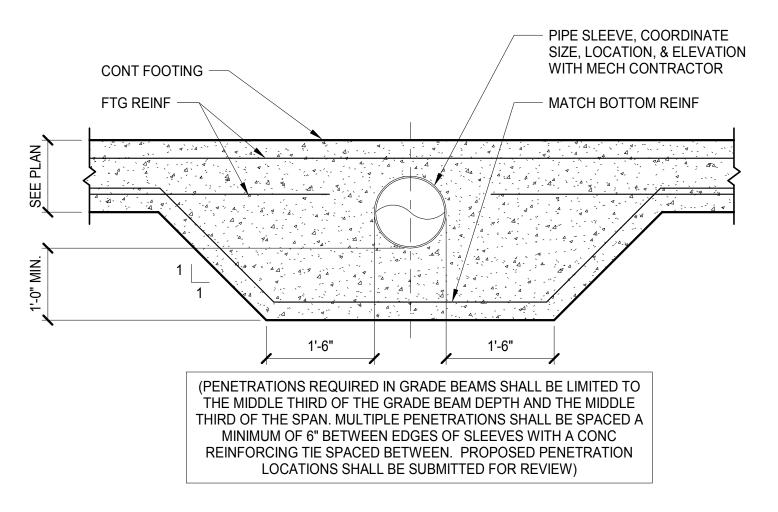
DRAWN BY: TRN

PROJECT NUMBER: **16020**


SHEET TITLE: TYPICAL DETAILS




TYPICAL DOWN SPOUT 1 NOTCH AT CONTINUOUS FOOTING DETAIL S-103 N.T.S.

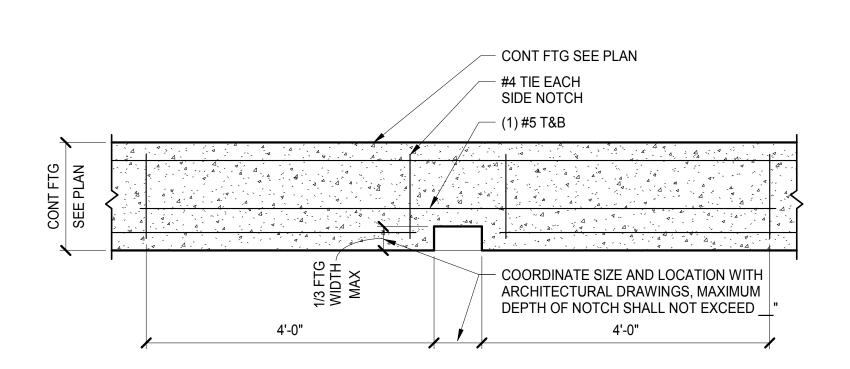


2 TYPICAL PIPE SLEEVE THRU CONTINUOUS FOOTING DETAIL N.T.S.

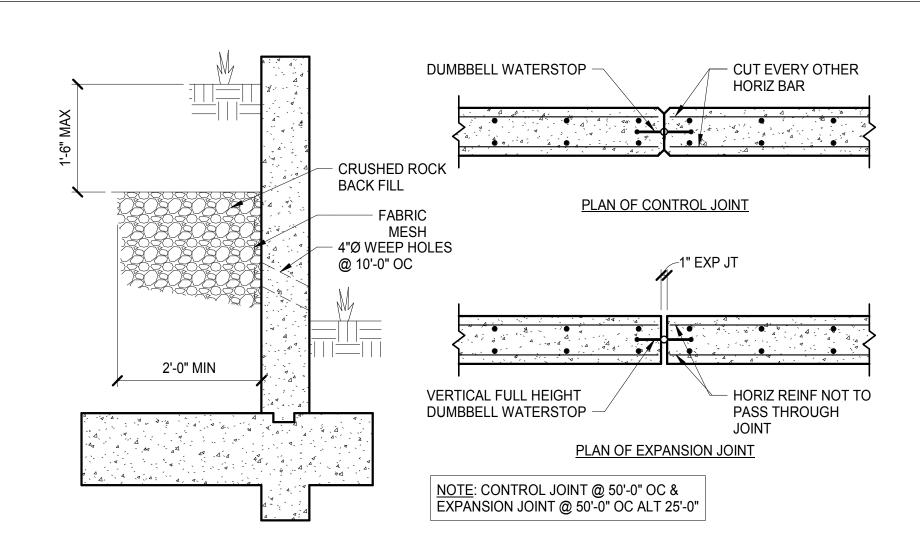


3 TYPICAL RETAINING WALL DETAILS
S-103 N.T.S.

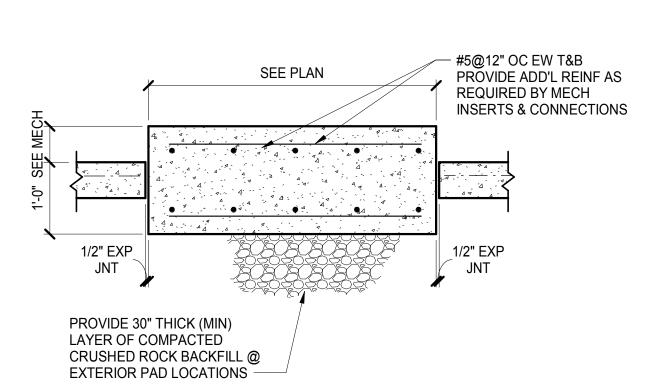


TYPICAL MECHANICAL PAD ON GRADE DETAIL
S-103 N.T.S.

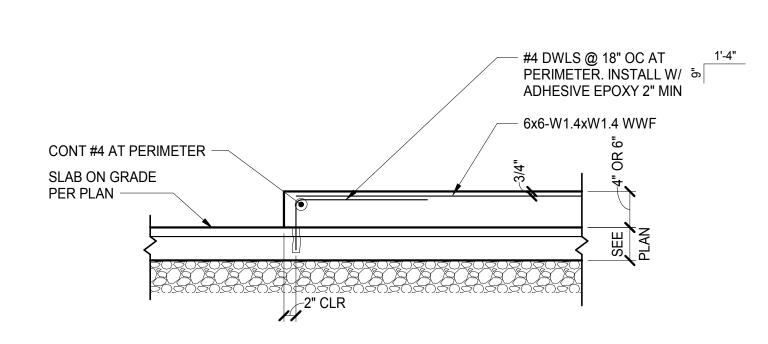


TYPICAL HOUSEKEEPING PAD ON CONCRETE SLAB ON GRADE N.T.S.

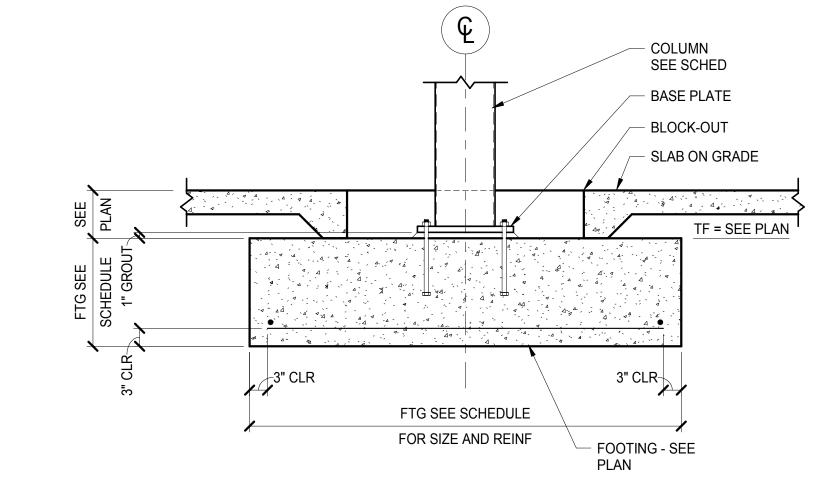

6 TYPICAL INTERIOR COLUMN AT SPREAD FOOTING DETAIL N.T.S.

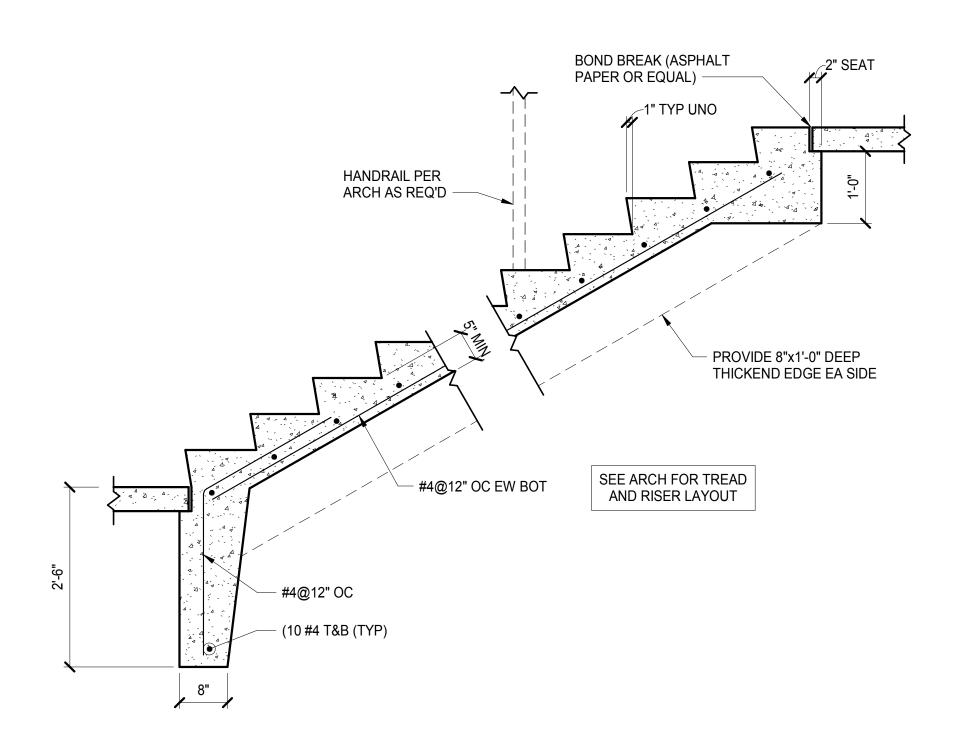

7 TYPICAL INTERIOR OR EXTERIOR CONCRETE STAIR ON GRADE N.T.S.

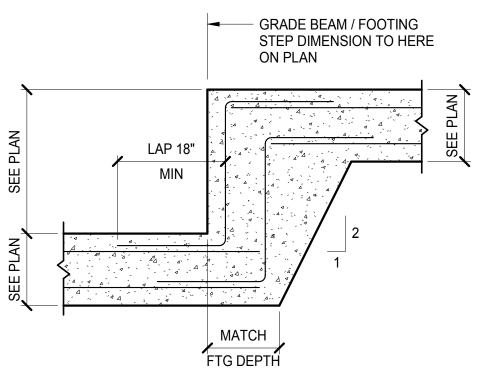

TYPICAL STEP GRADE 8 BEAM OR FOOTING DETAIL S-103 N.T.S.



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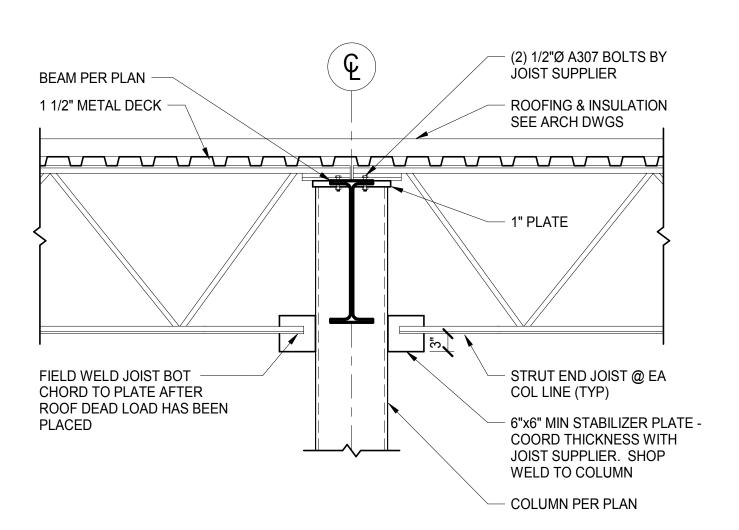
E-MAIL: DVANLEER@COCHRAN.COM STRUCTURAL ALPER AUDI, INC. 1804 BORMAN CIRCLE DRIVE ST. LOUIS, MO 63146

T (314) 432-8600 F (314) 807-2774 CONTACT: STEVE EHRETT E-MAIL: STEVE.EHRETT@ALPERAUDI.COM


MECHANICAL, ELECTRICAL, PLUMBING BRIC PARTNERSHIP, LLC 343 S. KIRKWOOD ROAD, SUITE 204 KIRKWOOD, MO 63122 T (314) 725-5889 CONTACT: BRUCE COLEMAN E: BCOLEMAN@BRICPARTNERSHIP.COM

ENGINEER OF RECORD:


SHEET TITLE: TYPICAL DETAILS



1 TYPICAL STRUT END JOIST DETAIL AT HSS COLUMN DETAIL N.T.S.

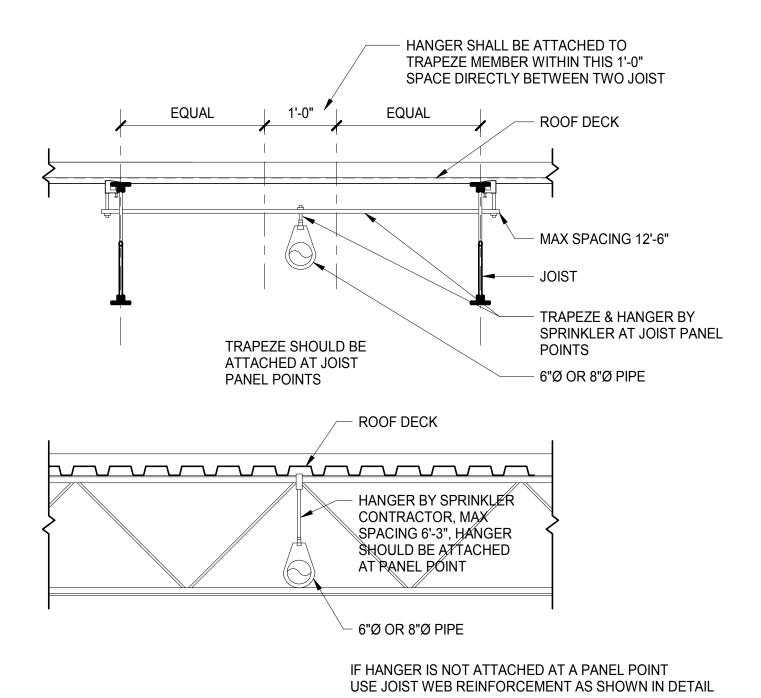


TYPICAL 6" DIA or 8" DIA SPRINKLER PIPES HANGER DETAIL N.T.S.

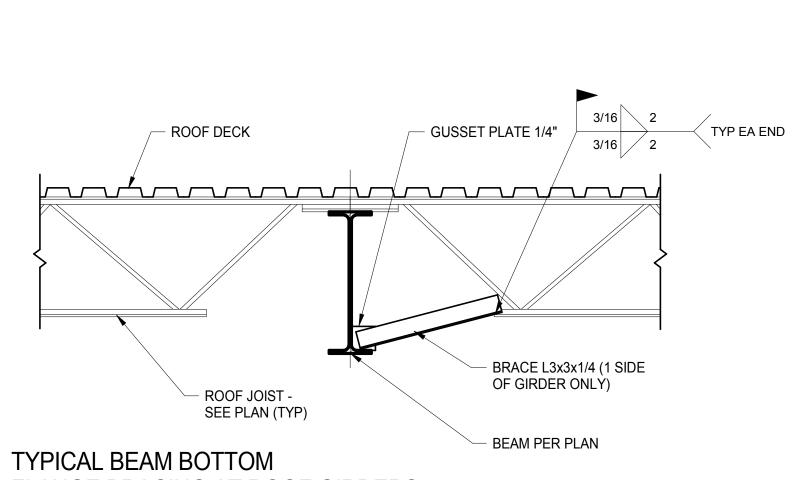

8 FLANGE BRACING AT ROOF GIRDERS

8 3/4" = 1'-0"


CING AT ROOF GIRDERS

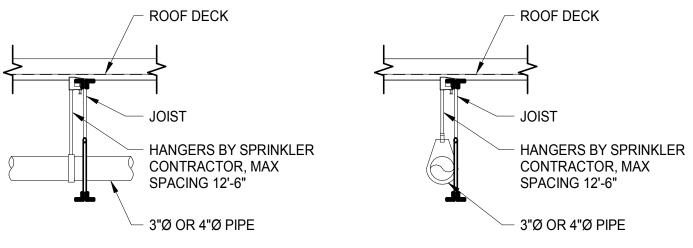


HANGERS SHALL BE ATTACHED AT JOIST PANEL POINTS OTHERWISE USE JOIST WEB REINFORCEMENT AS SHOWN IN DETAIL

NOTE:
ALL JOIST BRIDGING SHALL BE LOCATED SUCH THAT THE LEADING EDGE
OF ANY BRIDGING MEMBER IS A MINIMUM OF 1'-0 (MEASURED HORIZONTALLY)
FROM THE CENTER LINE OF ANY SPRINKLER LOCATED ABOVE THE BOTTOM
CHORD OF BAR JOISTS. COORDINATE EXACT LOCATIONS OF BRIDGING WITH
THE DIMENSIONAL INFORMATION SHOWN ON THE AUTOMATIC SPRINKLER
CONSTRUCTION DRAWINGS PREPARED BY _______. NO
VARIATION FROM THIS MINIMUM CLEARANCE WILL BE PERMITTED.


TYPICAL 3" DIA OR 4" DIA SPRINKLER PIPES HANGER DETAIL
N.T.S.

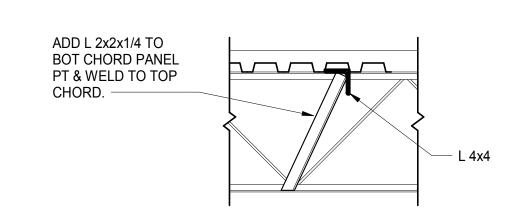


5 TYPICAL JOIST WEB REINFORCEMENT DETAIL
8-104 N.T.S.

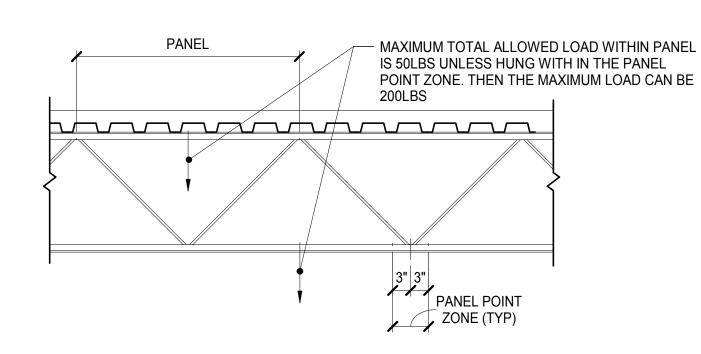

6 TYPICAL MISCELLANEOUS HANGERS DETAIL N.T.S.

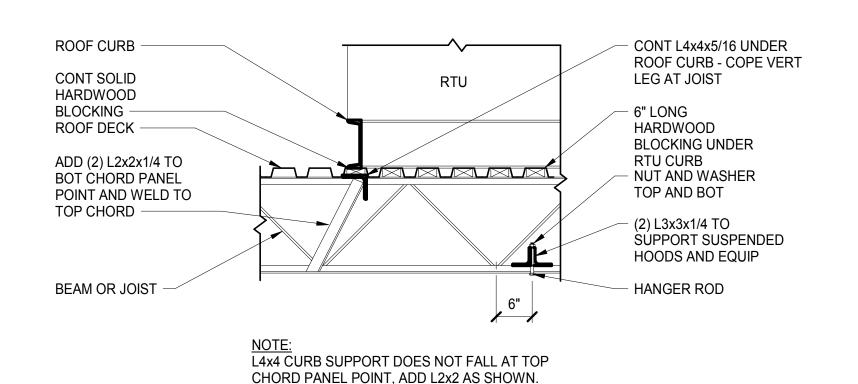


9 TYPICAL ROOF TOP UNITS DETAIL
S-104 3/4" = 1'-0"

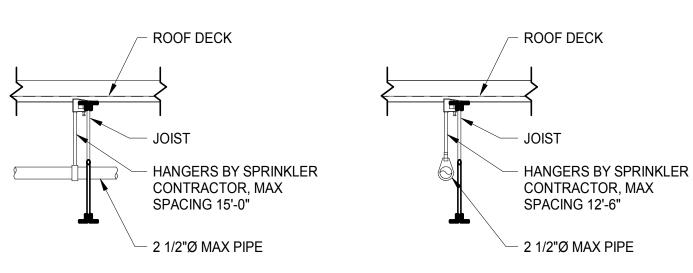


HANGERS <u>DO NOT</u> HAVE TO BE ATTACHED AT JOIST PANEL POINTS IF ONE HANGER LOAD DOES NOT EXCEED 50LBS - OTHERWISE USE TYPICAL JOIST WEB REINFORCEMENT AS DETAILED

TYPICAL 2 1/2" DIA MAX SPRINKLER PIPES HANGER DETAIL
N.T.S.

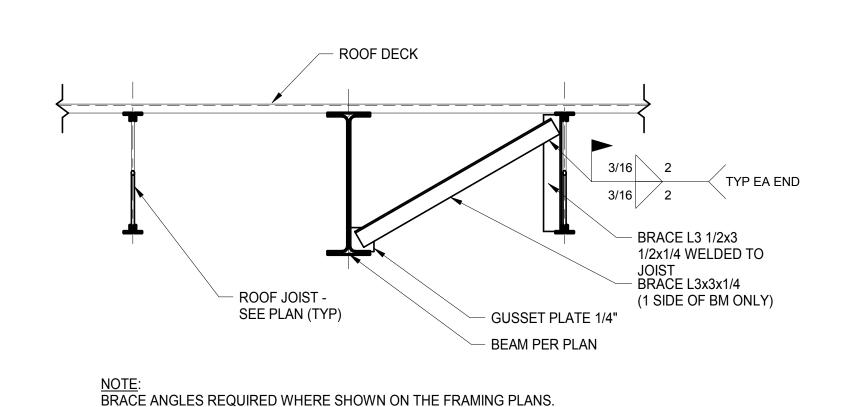


TYPICAL BEAM BOTTOM
7 FLANGE BRACING AT ROOF BEAMS

ANGLES ARE TO BE EQUALLY SPACED WITHIN THE BEAM SPAN.

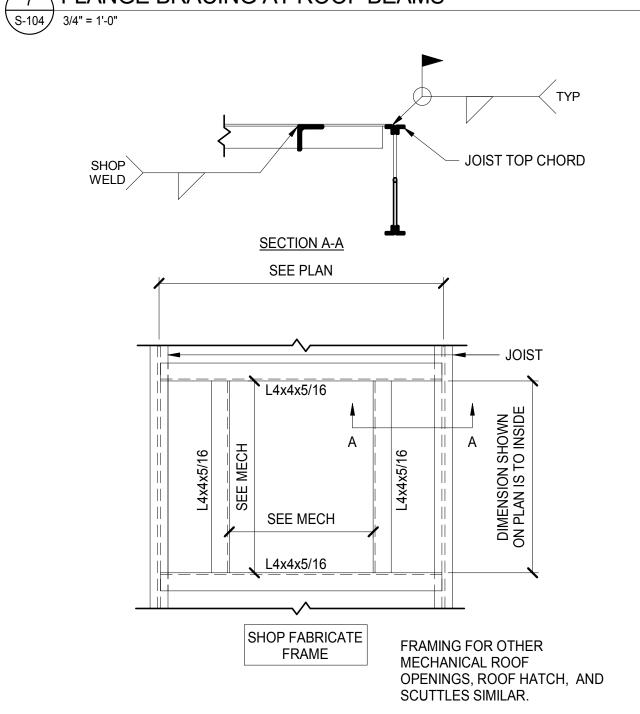

TYPICAL RTU ROOF FRAMING DETAIL
3/4" = 1'-0"

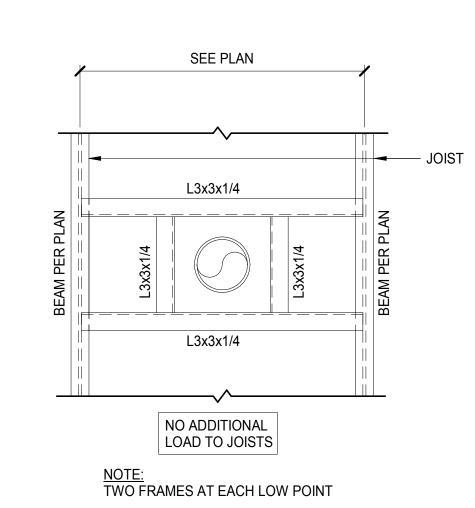

TYPICAL FRAME FOR

ROOF DRAIN AND OVERFLOW DETAIL

S-104 3/4" = 1'-0" (OTHER OPENINGS SIMILAR)

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SD architecture interior design

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ENGINEER OF RECORD:

STEVEN J. EHRETT MO STRUCTURAL LICENSE E-29025 MO CERTIFICATE OF AUTHORITY 000287

No. Date Description

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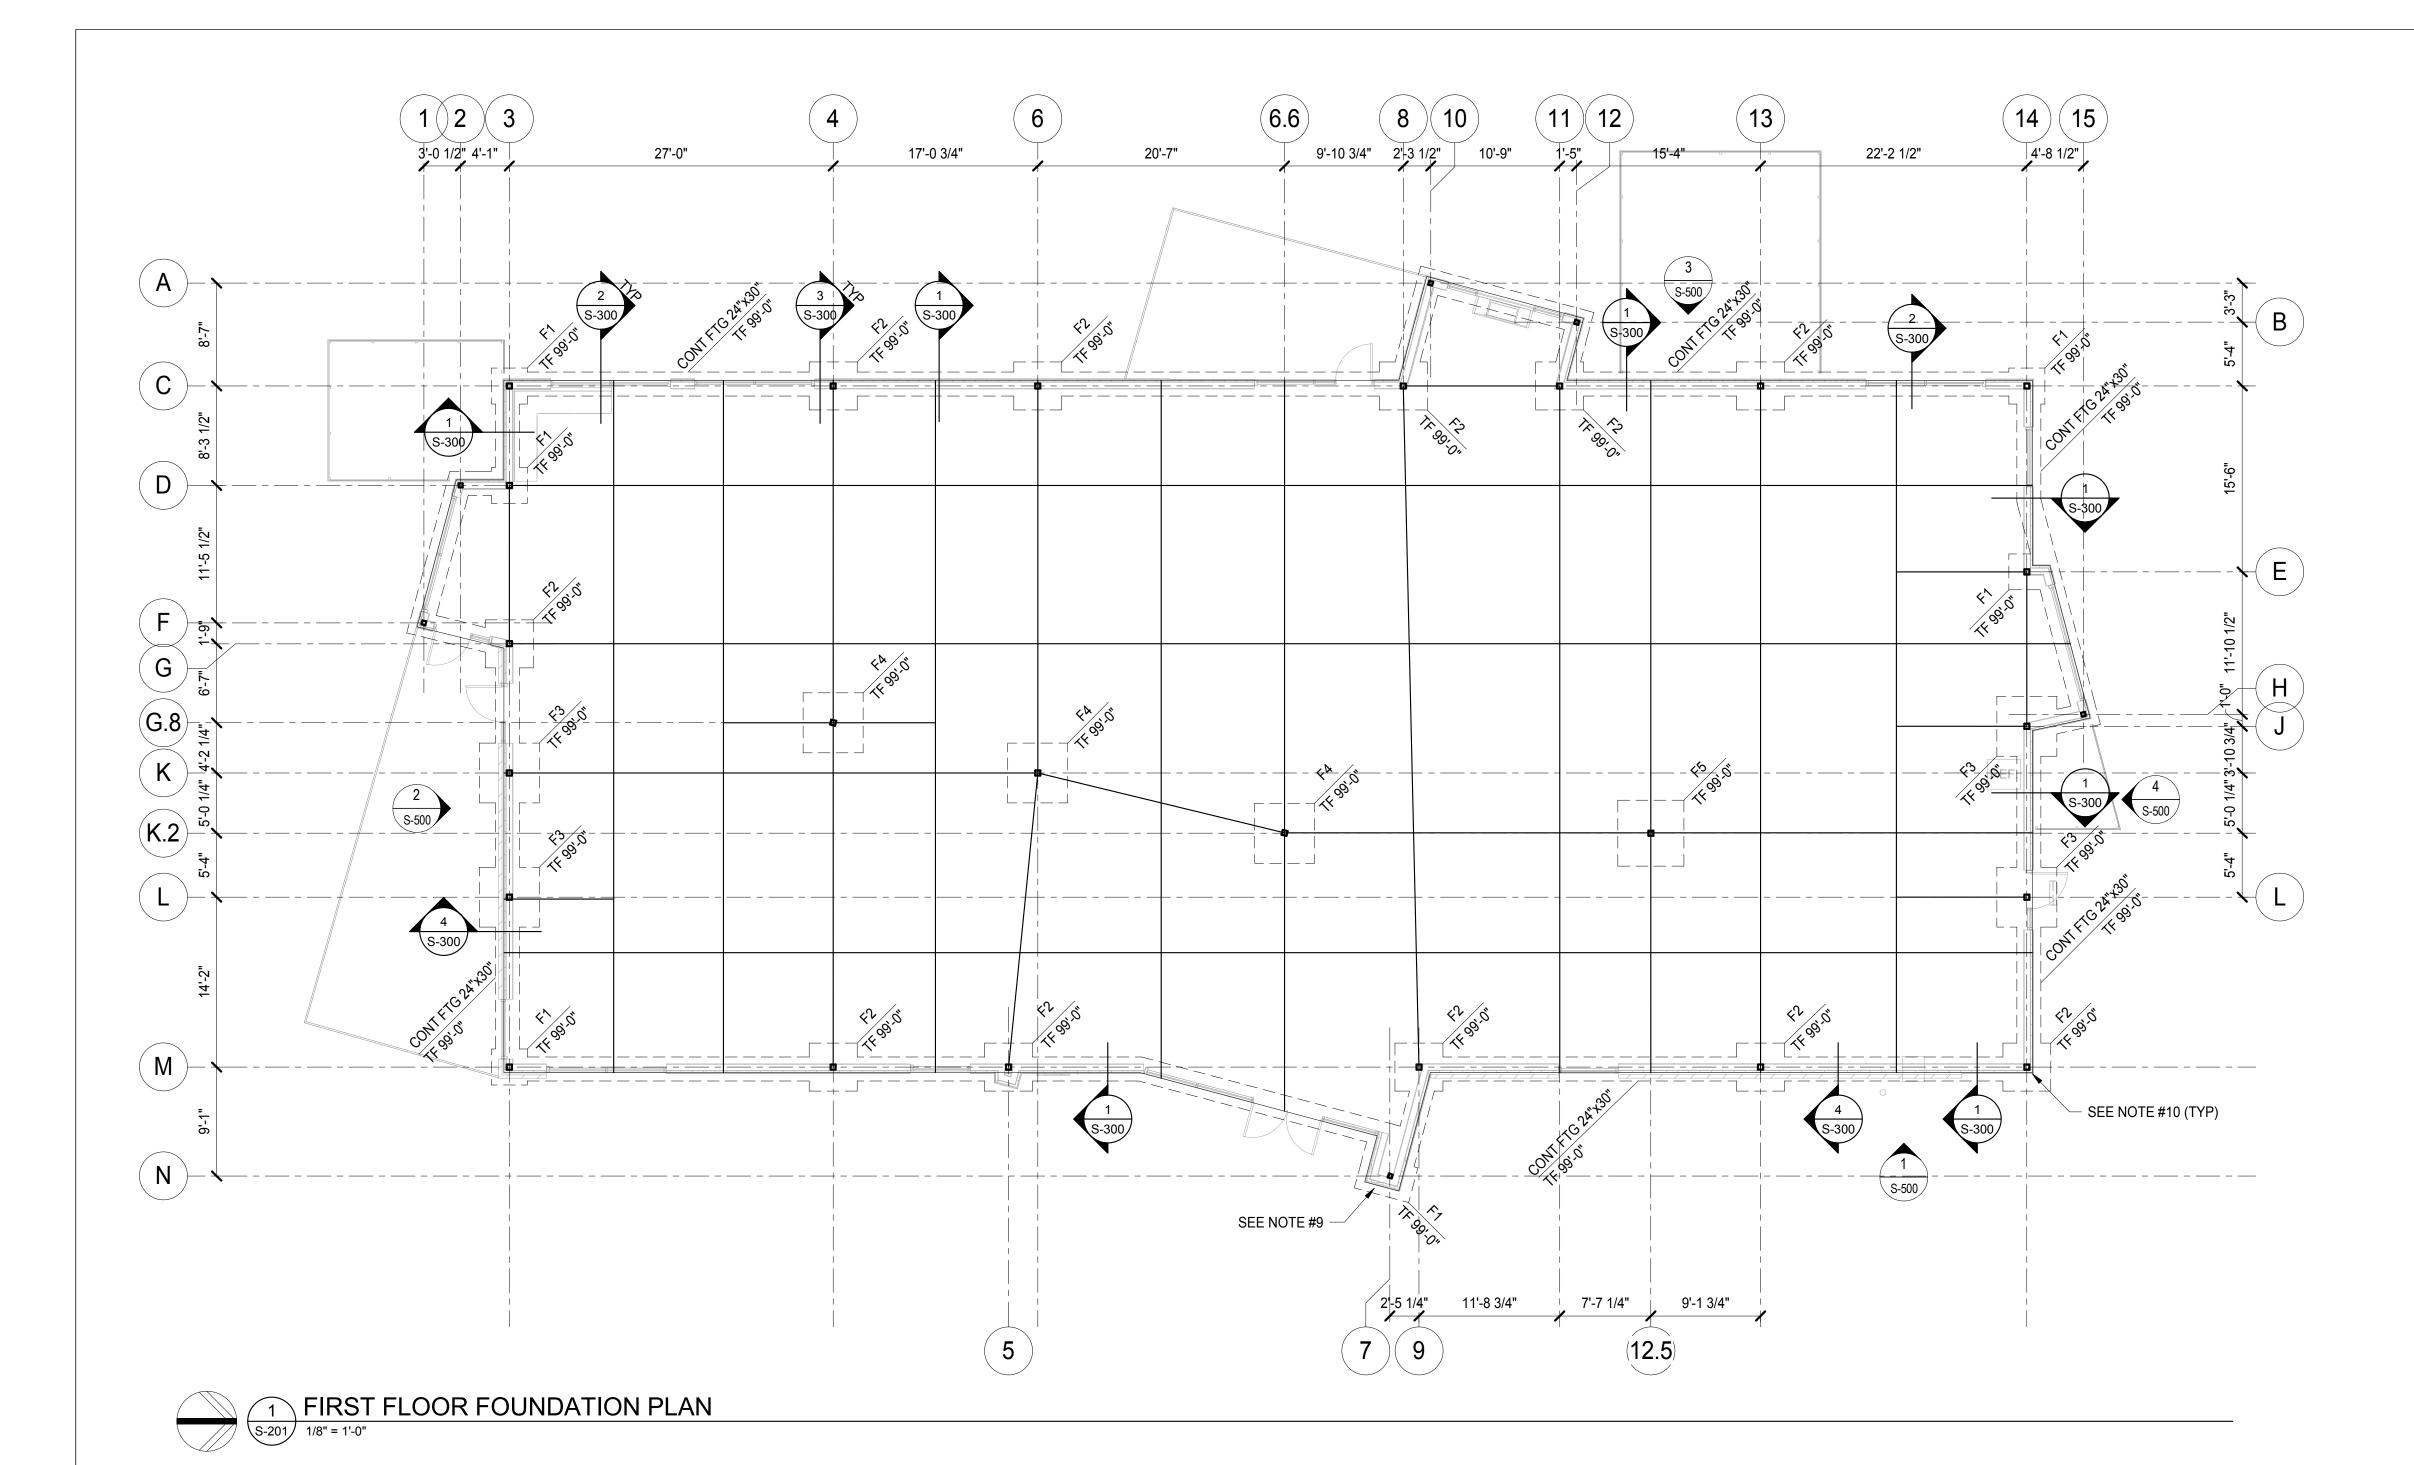
DRAWN BY: **TRN**

PROJECT NUMBER: 16020

SHEET TITLE:

TYPICAL DETAILS


S-104




FOUNDATION NOTES:

- 1. SEE SHEET SERIES S-100 FOR GENERAL NOTES AND TYPICAL DETAILS.
- 2. SEE SHEET SERIES S-500 FOR VERTICAL BRACING ELEVATIONS AND DETAILS.
- 3. SEE SHEET SERIES S-600 FOR COLUMN SCHEDULE AND BASE PLATE DETAILS.
- 4. FINISH FLOOR ELEVATION = 100'-0" (U.S.G.S. DATUM = 750.5').
- 5. SLAB CONSTRUCTION: 4 NORMAL WEIGHT CONCRETE SLAB ON GRADE ON 6 MIL. VAPOR RETARDER ON 6" MINIMUM COMPACTED GRANULAR FILL. REINFORCE SLAB WITH ONE LAYER 6x6-W2.1xW2.1 WWF CENTERED IN SLAB.
- 6. "TF" NOTED ON PLAN INDICATES TOP OF FOOTING ELEVATION.
- 7. "TC" NOTED ON PLAN INDICATES TOP OF CONCRETE ELEVATION.
- 8. "TW" NOTED ON PLAN INDICATES TOP OF WALL ELEVATION.
- 9. EXTEND FOOTING AND SLAB FOR WALL FRAMING. REINF EXTENSION W/ #5@12" OC

10. PROVIDE #4 x 4'-0"x4'-0" CORNER BARS LAPPED W/ CONTINUOUS #4 SLAB BAR @ OUTSIDE CORNER OF COLUMN. PROVIDE ASPHALTIC COATING TO EXPOSED BASE PLATE BELOW GRADE.

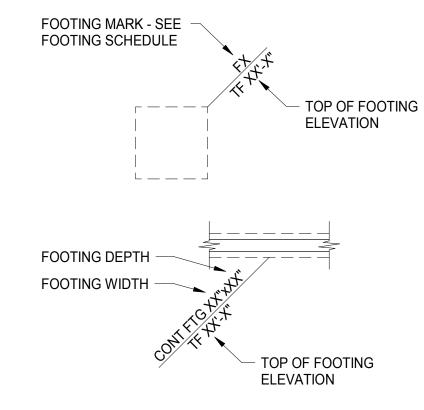


TYPICAL FOOTING DESIGNATION

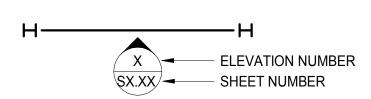

TYPICAL BRACING DESIGNATION

FOOTING SCHEDULE				
MARK	SIZE	REINFORCING EACH WAY TOP & BOTTOM UNO	REMARKS	
F1	3'-0"x3'-0"x2'-6"	(4) #5 EW		
F2	4'-0"x4'-0"x2'-6"	(5) #5 EW		
F3	5'-0"x5'-0"x2'-6"	(6) #5 EW		
F4	5'-0"x5'-0"x1'-3"	(6) #5 EW		
F5	5'-6"x5'-6"x1'-3"	(6) #5 EW		

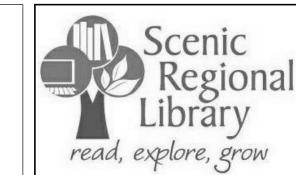

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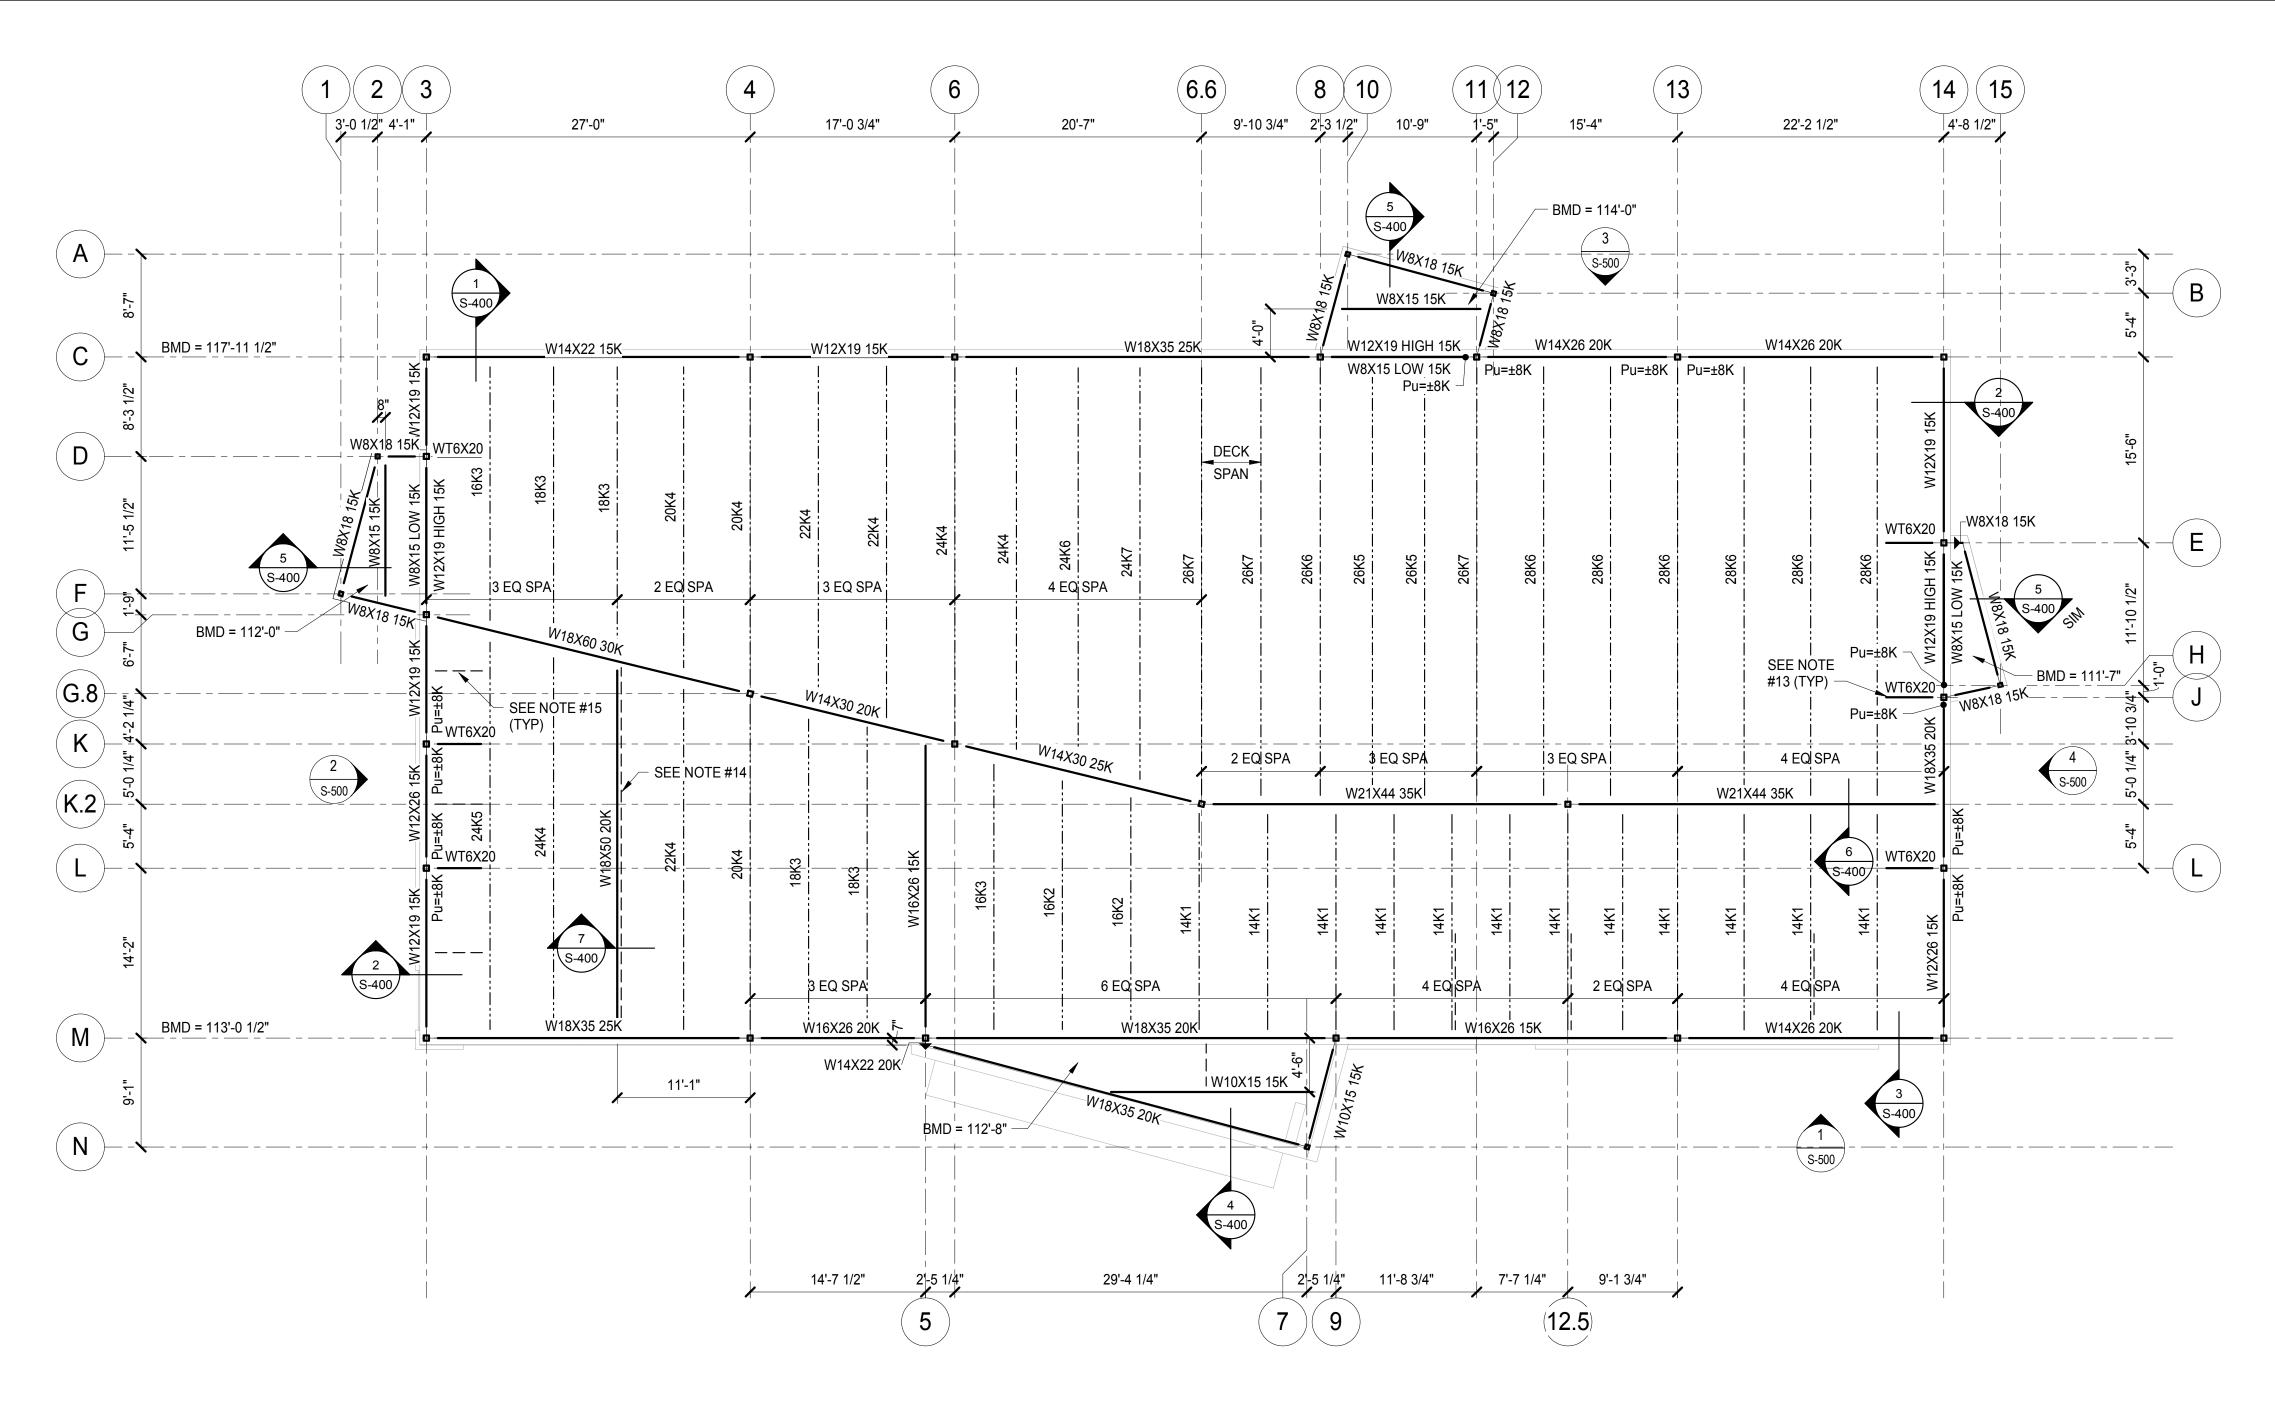
STEVEN J. EHRETT MO STRUCTURAL LICENSE E-29025 MO CERTIFICATE OF AUTHORITY 000287

No.	Date	Description
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PROJECT NUMBER: **16020**


SHEET TITLE: FIRST FLOOR FOUNDATION PLAN






FRAMING NOTES:


- 1. SEE SHEET SERIES S-100 FOR GENERAL NOTES AND TYPICAL DETAILS.
- 2. SEE SHEET SERIES S-500 FOR VERTICAL BRACING ELEVATIONS AND DETAILS.
- 3. SEE SHEET SERIES S-600 FOR COLUMN SCHEDULE AND BASE PLATE DETAILS.
- 4. SEE TYPICAL BEAM DESIGNATION FOR MOMENT CONNECTION SYMBOL
- 5. SEE TYPICAL VERTICAL BRACING DESIGNATION FOR BRACING SYMBOL.
- 6. BOTTOM OF METAL DECK ELEVATION SHOWN ON PLAN.
- 7. ROOF CONSTRUCTION: 1 1/2" x 20 GAUGE WIDE RIB PAINTED METAL DECK OVER STEEL FRAMING. WELD METAL DECK TO ALL SUPPORTING STEEL WITH 5/8" DIA PUDDLE WELDS IN A 36/7 PATTERN. SIDE LAP OF METAL DECK TO BE ATTACHED WITH (3) #10 SELF-DRILLING SCREWS FOR SPANS MORE THAN 3'-0" LONG. EDGE WELDS OF METAL DECK TO BE @ 6" OC MAXIMUM (UNO)
- 8. DESIGN ROOF JOISTS FOR A NET UPLIFT OF 18 PSF OVER ENTIRE ROOF AND A NET WIND UPLIFT OF 20 PSF OVER A 7'-0" WIDE STRIP AROUND PERIMETER.
- 9. BEAM CONNECTIONS SHALL BE DESIGNED TO TRANSFER AXIAL LOADS NOTED "P=__K" ON PLAN.
- 10. STRUT JOIST TO OCCUR ON ALL COLUMN CENTER LINES UNLESS NOTED OTHERWISE. SEE TYPICAL DETAILS.
- 11. PROVIDE HORIZONTAL JOIST BRIDGING SPACED PER LATEST S.J.I. (UNO).
- 12. "BMD" NOTED ON PLAN INDICATES BOTTOM OF METAL DECK ELEVATION.
- 13. WT6x20 WELD TO COLUMN. COPE AND LAP ONTO JOIST TOP CHORD. WELD DECK TO WT W/ 5/8"Ø PUDDLE WELDS @ 6" OC
- 14. MAX FUTURE OPERABLE PARTITION WEIGHT = 150 PLF
- 15. SEE TYPICAL DETAILS, SHEET S-104, FOR BEAM BRACING DETAILS.

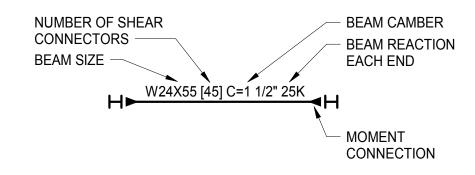


TYPICAL BEAM DESIGNATION

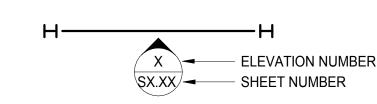

TYPICAL BRACING DESIGNATION

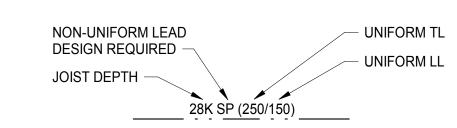

TYPICAL JOIST DESIGNATION

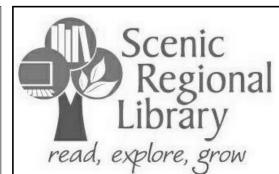

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ENGINEER OF RECORD:

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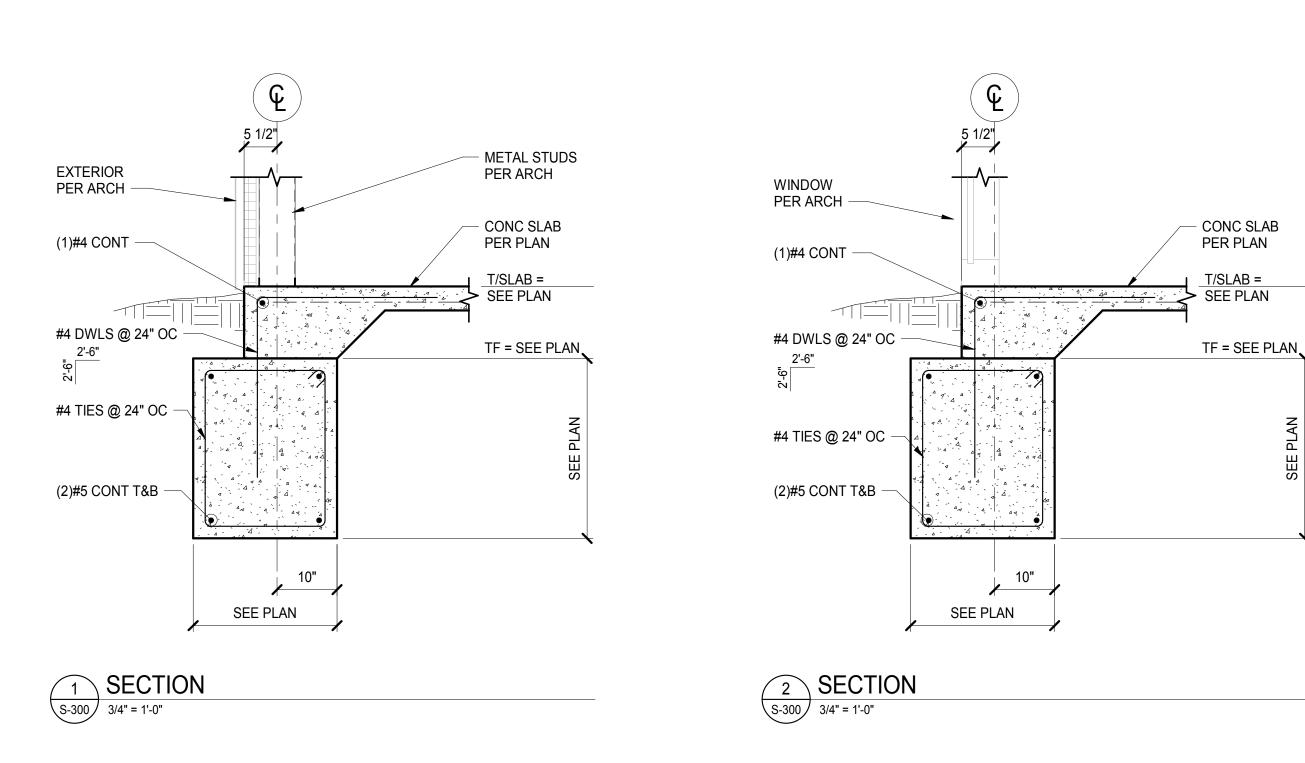
No.	Date	Description
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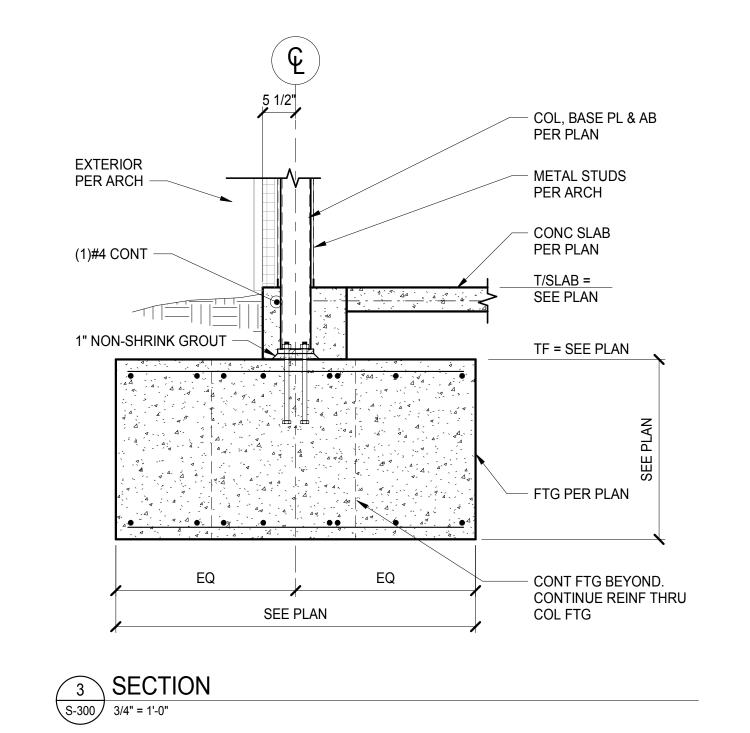
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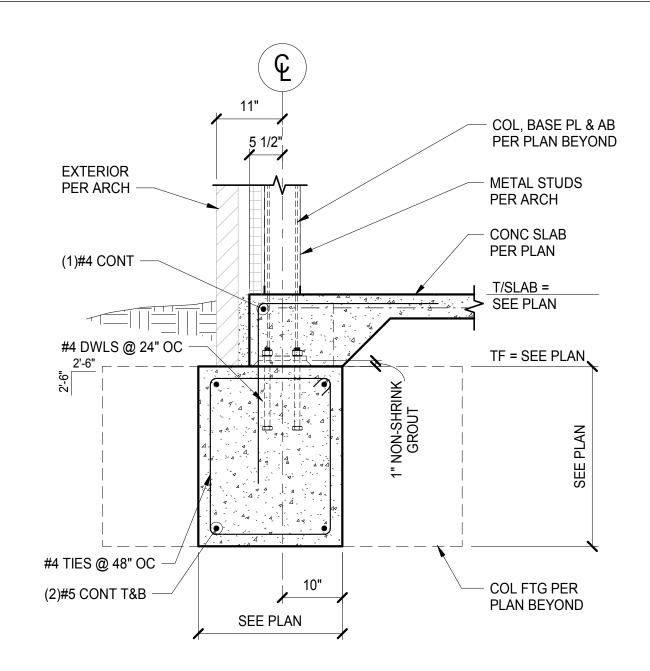
PROJECT NUMBER: 16020

SHEET TITLE:
ROOF FRAMING PLAN

S-202









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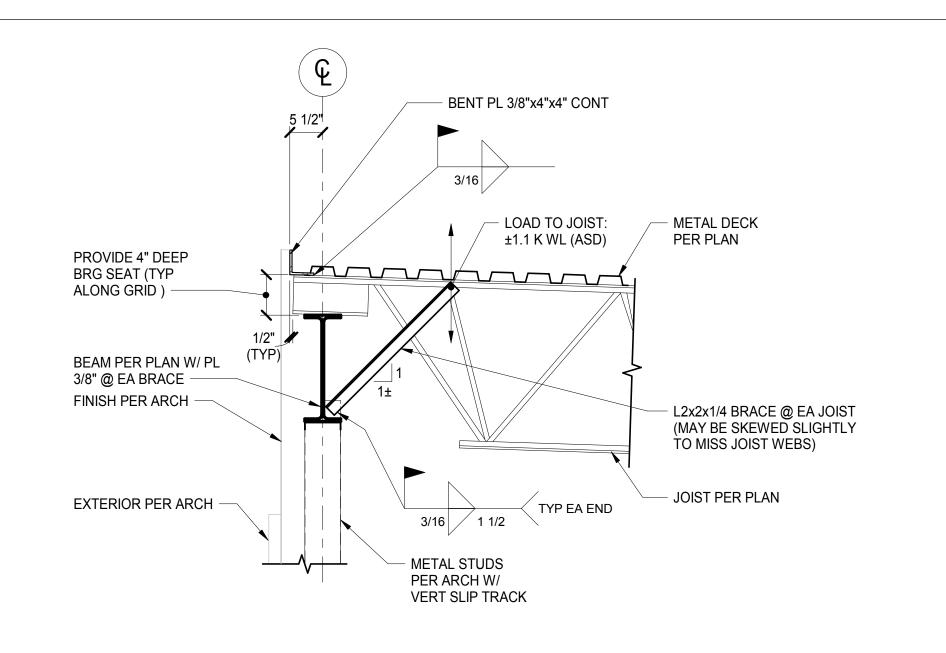
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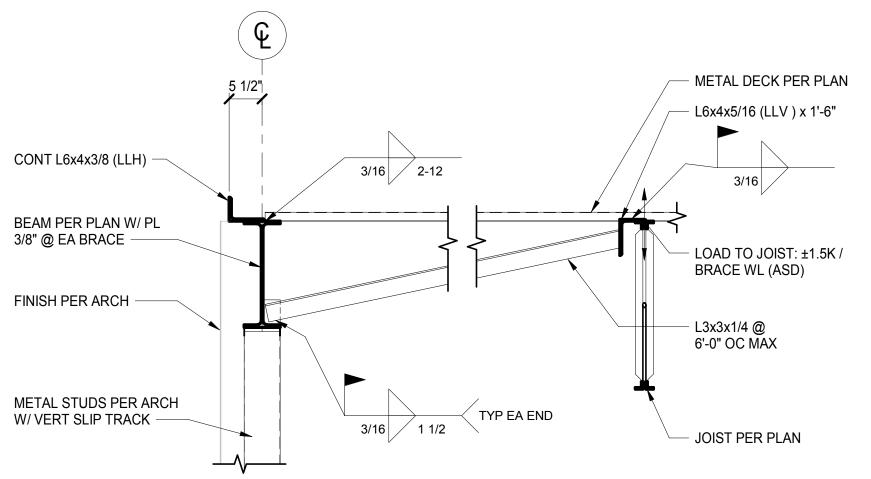
No.	Date	Description
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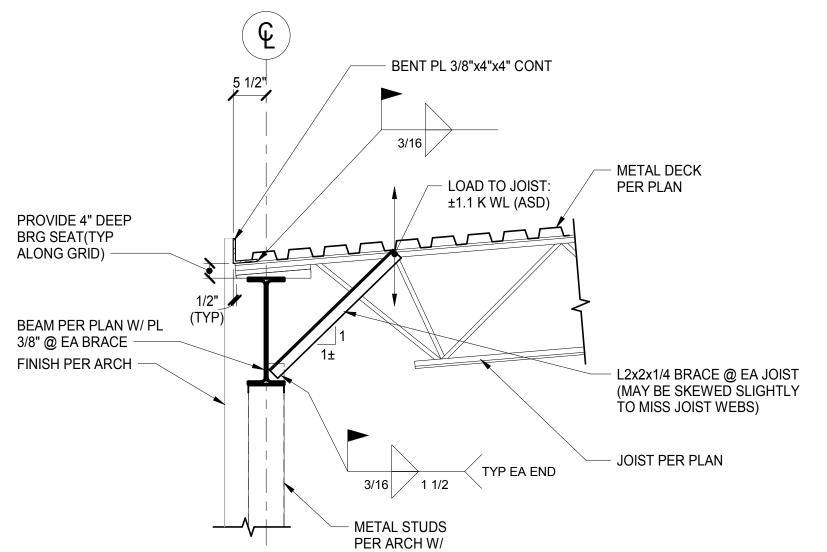
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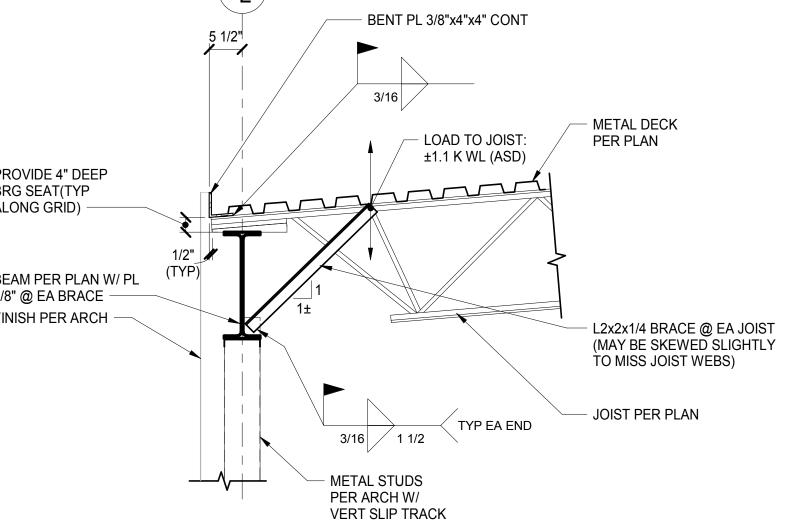
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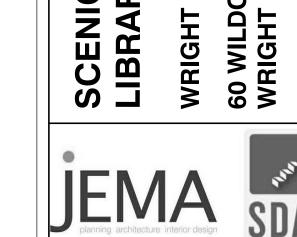
SHEET TITLE: FOUNDATION SECTIONS











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METAL DECK PER PLAN

- JOIST PER PLAN

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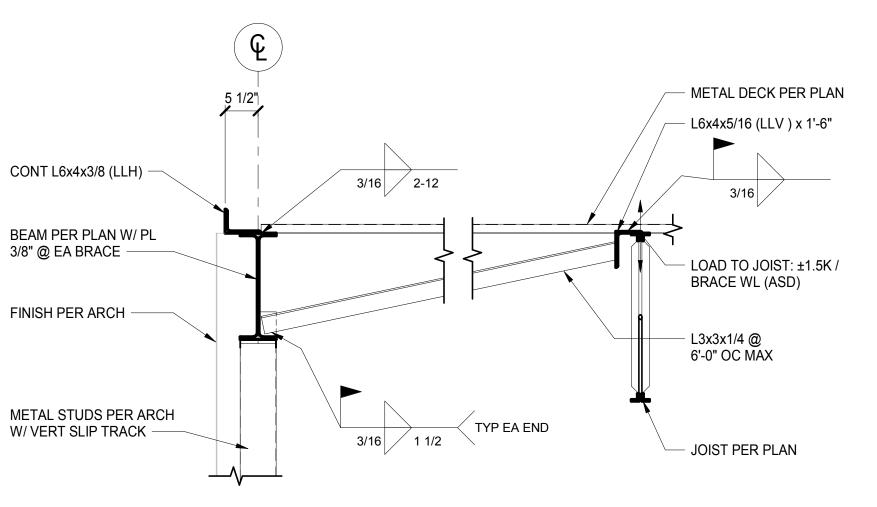
No. Date Description

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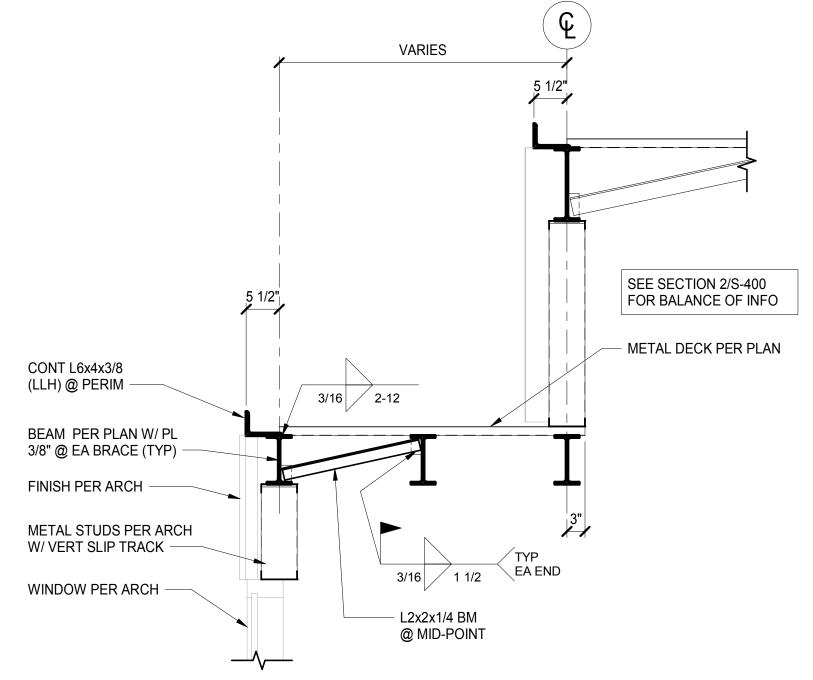
SHEET TITLE: FRAMING SECTIONS


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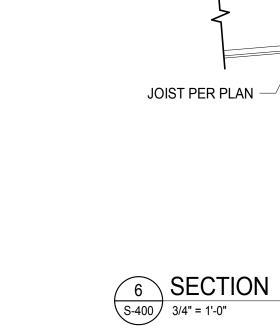




5 SECTION 3/4" = 1'-0"






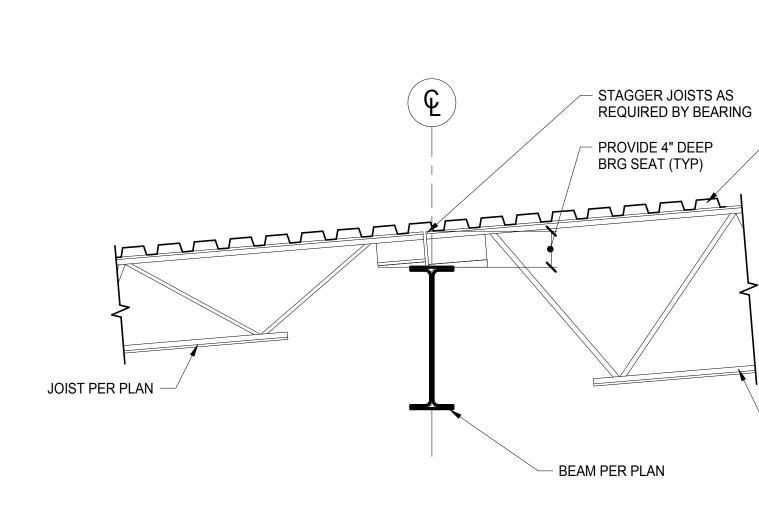

3 SECTION


S-400 3/4" = 1'-0"

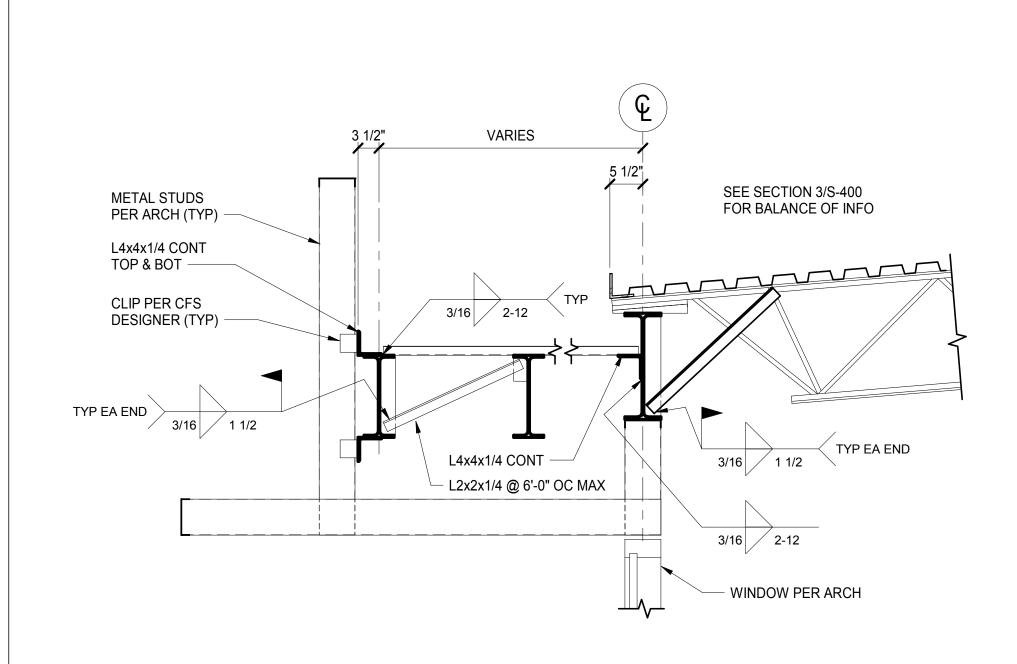



1 SECTION

S-400 3/4" = 1'-0"




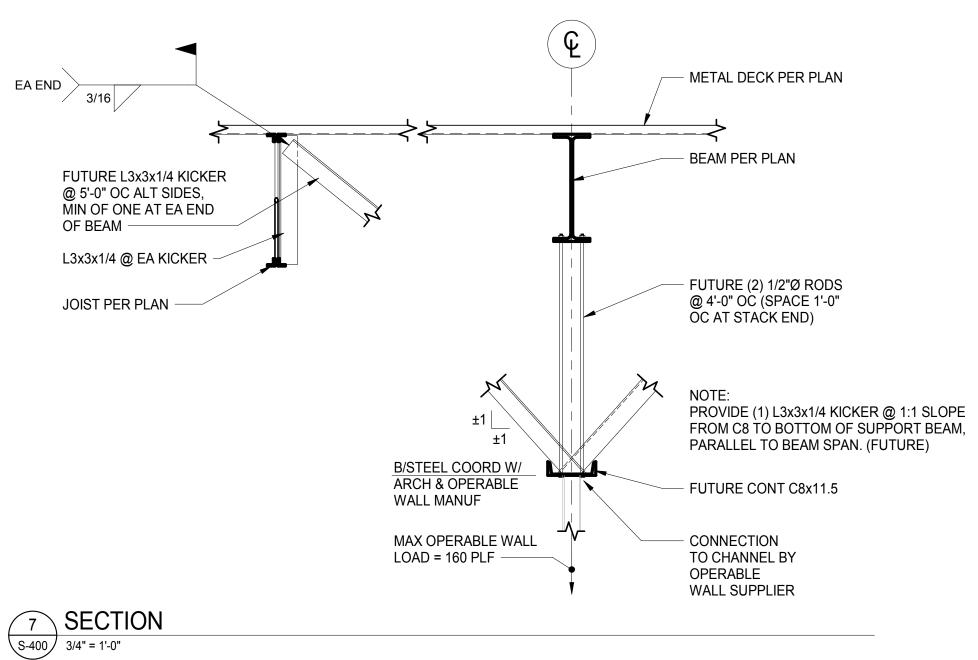


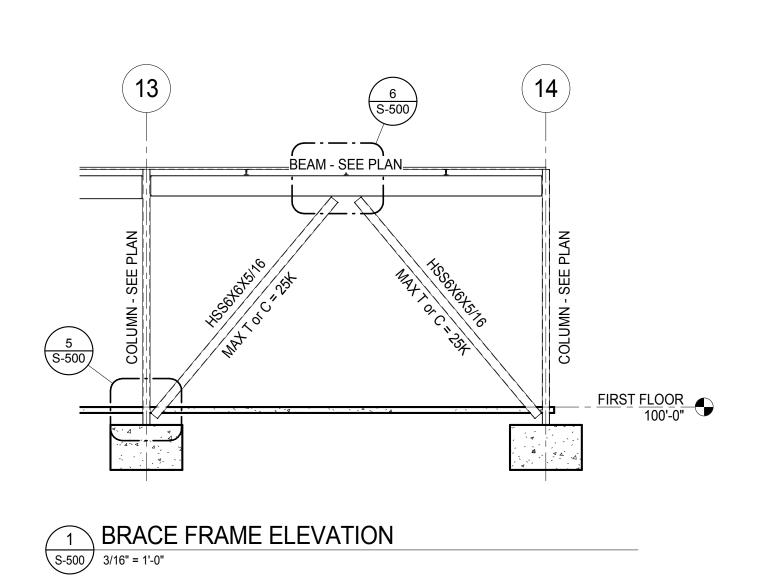

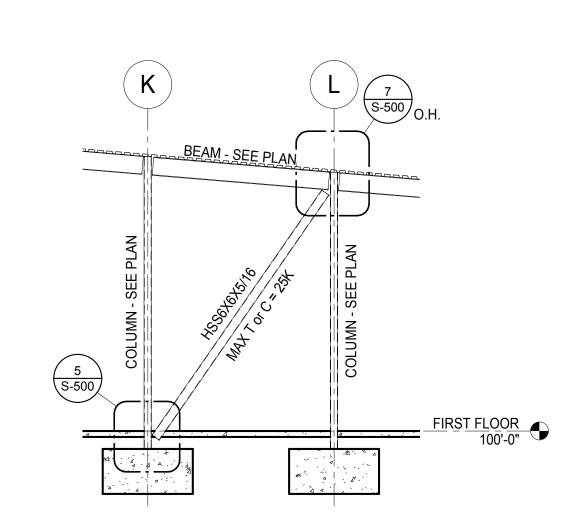

2 BRACE FRAME ELEVATION
3/16" = 1'-0"

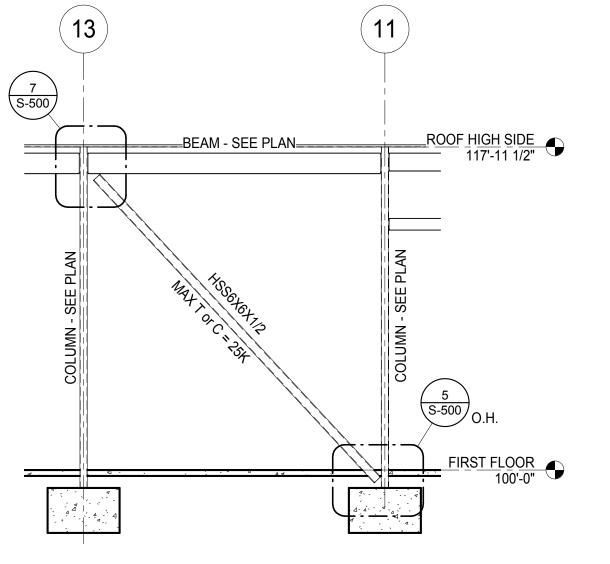

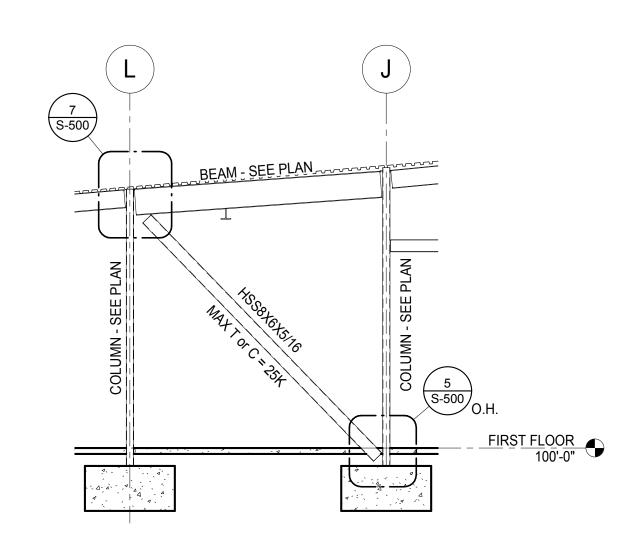

3 BRACE FRAME ELEVATION
3/16" = 1'-0"

BRACE FRAME ELEVATION

3/16" = 1'-0"

COLUMN AND BASE
PLATE - SEE SCHED


BRACE - SEE ELEVATION


GUSSET PLATE (1/2" MIN)

WORKING POINT

ERECTION BOLT

SEE BRACING ELEVATION FOR ORIENTATION OF GUSSET PLATE.

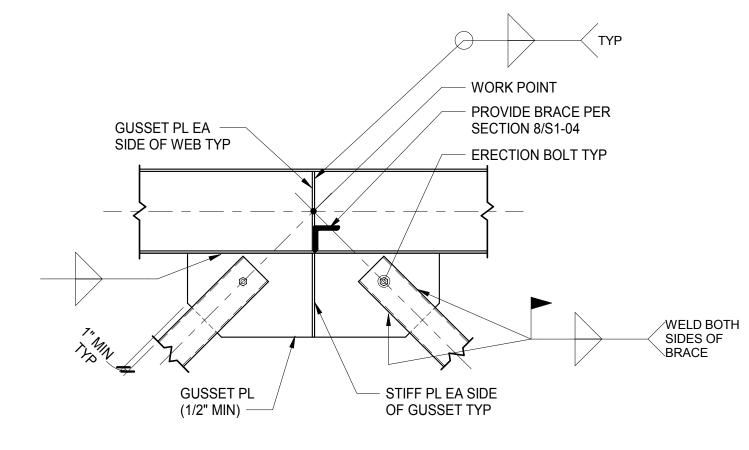

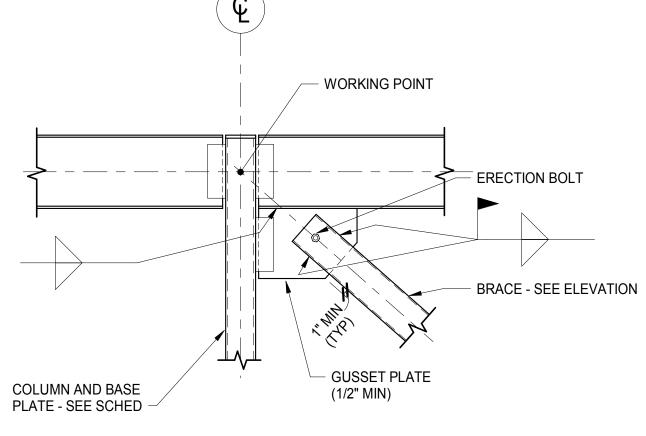

5 BRACE DETAIL

NOTE:

S-500 3/4" = 1'-0"

6 BRACE DETAIL
S-500 3/4" = 1'-0"

7 BRACE DETAIL

3/4" = 1'-0"

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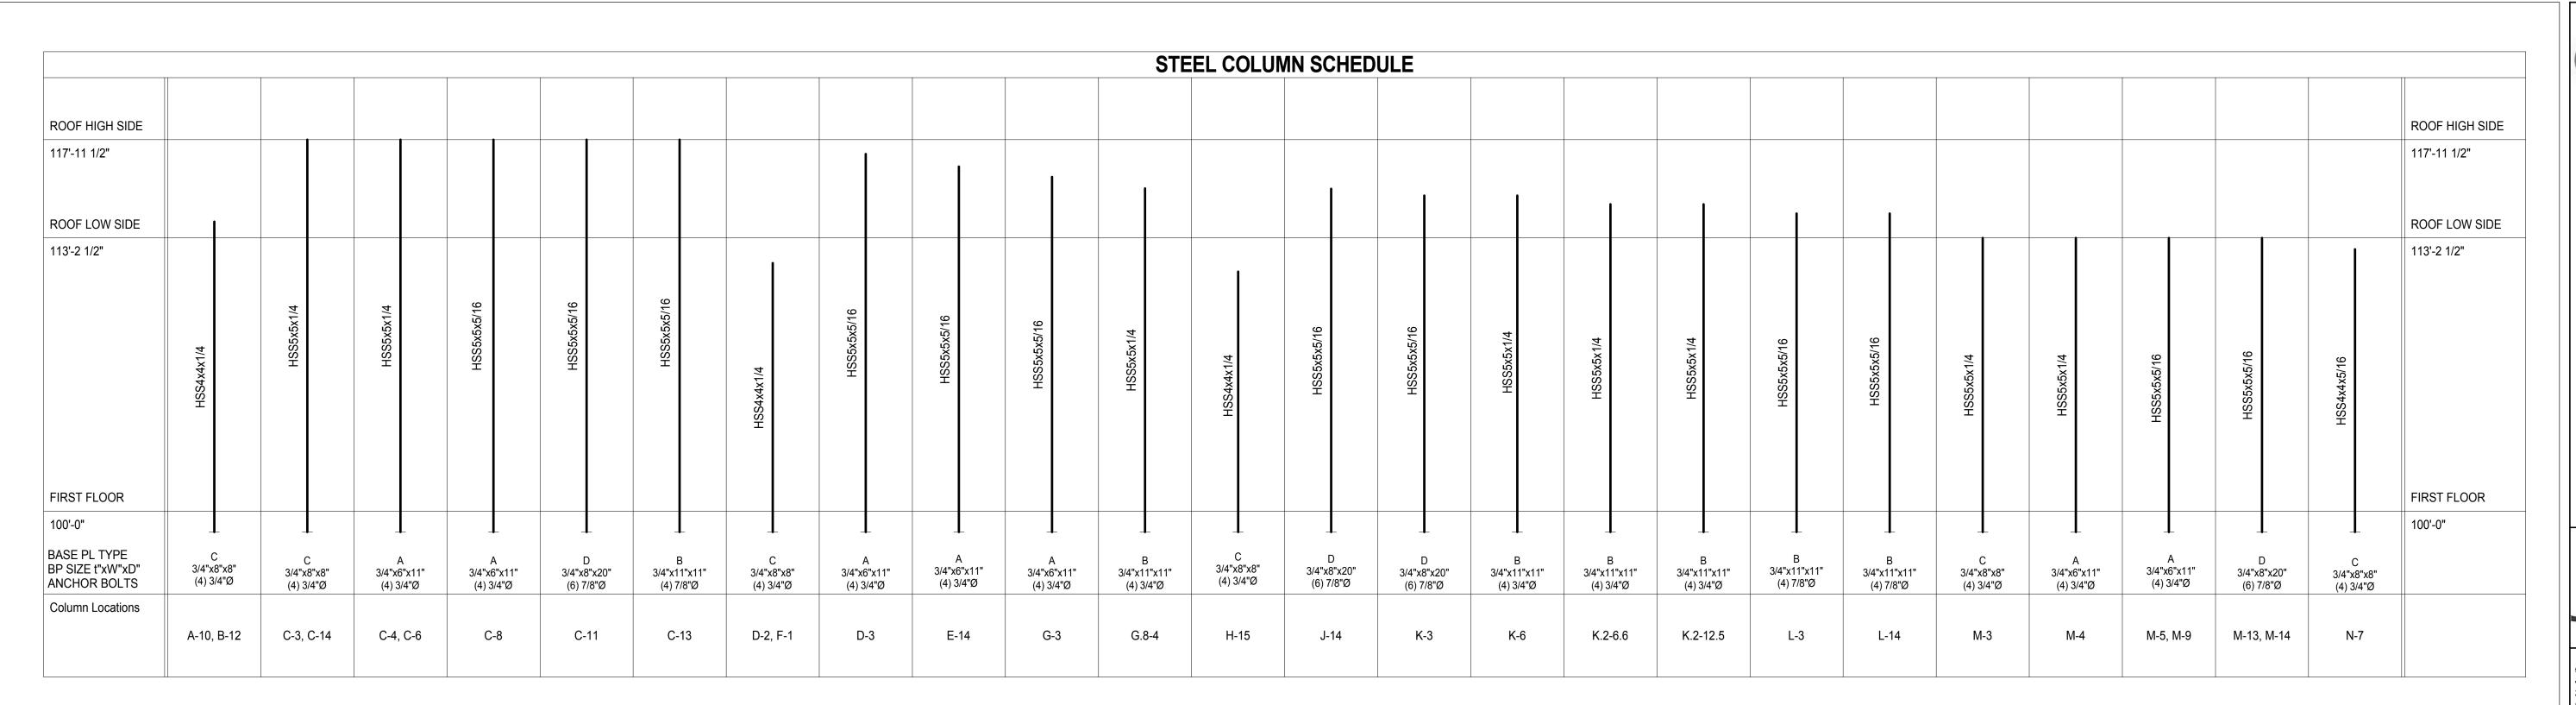
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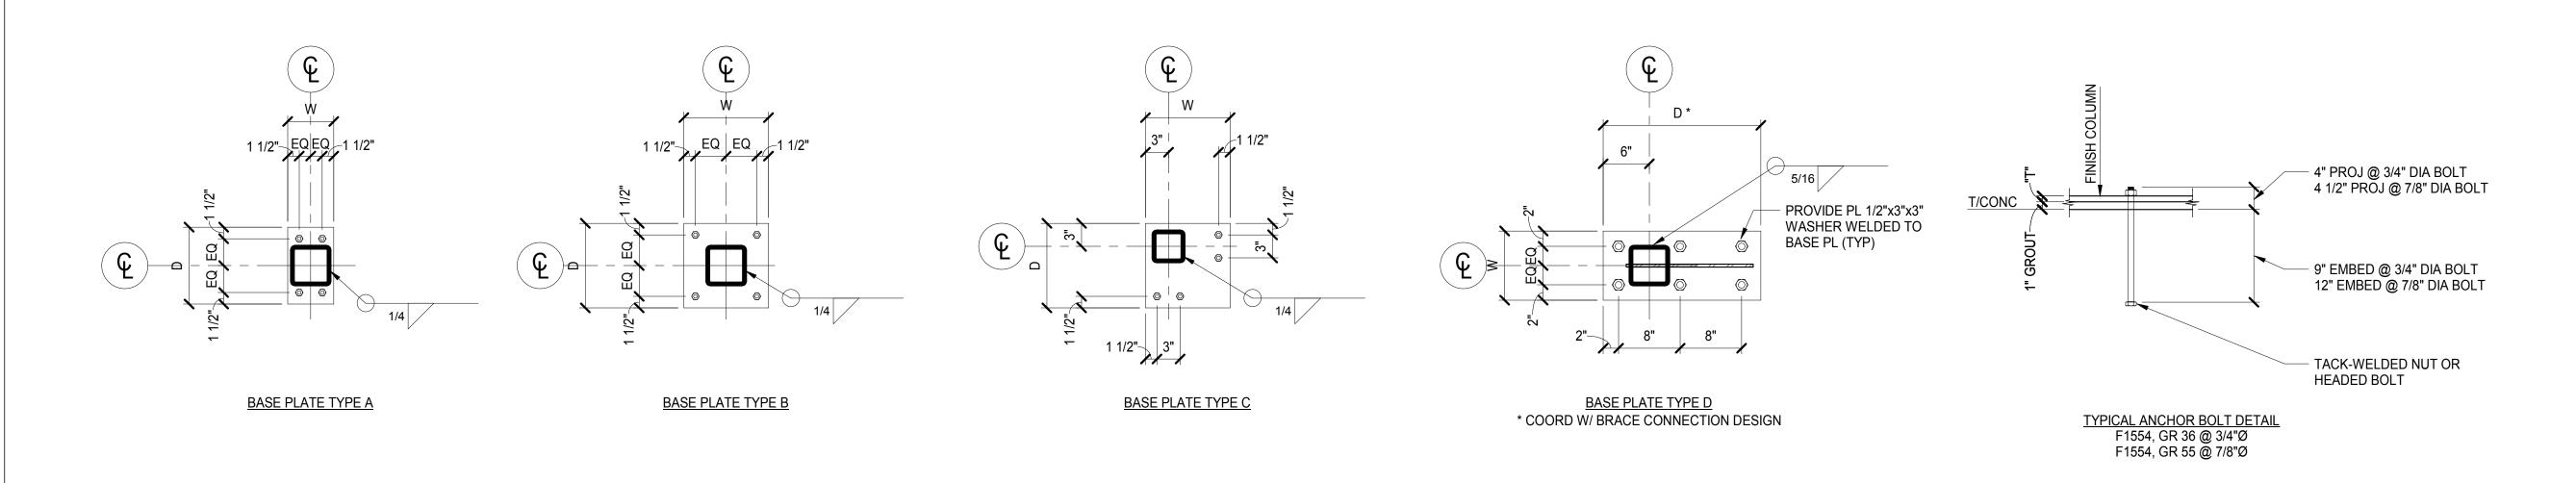
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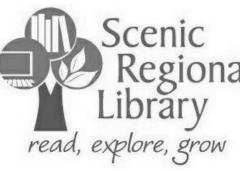
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Date	Description
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DRAWN BY: **TRN**

PROJECT NUMBER: **16020**

SHEET TITLE: COLUMN SCHEDULE & DETAILS

GENERAL NOTES

- 1. THE SPACE ALLOWED FOR MECHANICAL (HVAC, PLUMBING, FIRE PROTECTION) AND ELECTRICAL WORK ABOVE THE SUSPENDED CEILING IS CRITICAL AND REQUIRES COORDINATION BETWEEN TRADES. CONTRACTORS SHALL THOROUGHLY FAMILIARIZE THEMSELVES WITH THE ARCHITECTURAL, STRUCTURAL, MECHANICAL, AND ELECTRICAL DRAWINGS PRIOR TO FABRICATION OR INSTALLATION OF ANY MATERIALS. DUCTWORK SHALL BE HUNG AS CLOSE AS POSSIBLE TO THE STRUCTURE ABOVE UNLESS INDICATED OTHERWISE. REWORK OF PIPING, DUCTWORK, EQUIPMENT LOCATION, CONDUIT, ETC. AS A RESULT OF POOR PLANNING, COORDINATION, OR SCHEDULING SHALL BE THE RESPONSIBILITY OF THE CONTRACTOR.
- 2. PIPES/DUCTS/ETC. PENETRATING EXTERIOR WALLS AND ROOFS SHALL BE SEALED WEATHER PROOF.
- 3. CONTRACTOR TO FIRESTOP ALL PENETRATIONS THROUGH FIRE-RATED FLOORS AND WALLS CREATED BY NEW WORK WITH "SPECSEAL SSS"
- 4. PROVIDE OPENING IN DRY WALL ABOVE CEILING TO ALLOW SUPPLY AIR TO RETURN TO HEAT PUMPS OR AIR HANDLERS.
- 5. REFRIGERANT PIPING TO BE SIZED BY EQUIPMENT MANUFACTURER AND INSTALLED PER THE MANUFACTURER'S INSTALLER'S GUIDE. CONTRACTOR TO SUBMIT DRAWINGS SHOWING ROUTING. SEE SPECIFICATIONS.
- 6. THERMOSTATS AND ROOM TEMPERATURE SENSORS SHALL BE MOUNTED AT 48" A.F.F. TO THE TOP OF THERMOSTAT UNLESS NOTED OTHERWISE. DO NOT MOUNT IN DIRECT SUNLIGHT OR NEAR HEAT PRODUCING EQUIPMENT.
- 7. INSTALL H.V.A.C. SYSTEM IN ACCORDANCE WITH ALL STATE AND LOCAL
- 8. THE CONTRACTOR SHALL BE RESPONSIBLE FOR THE COORDINATION OF ANY FRAMING REVISIONS, EQUIPMENT LOCATIONS, ADDITION OF CONTROLS, ELECTRICAL CIRCUITING REVISIONS, ETC. THAT RESULT FROM USING EQUIPMENT OTHER THAN INDICATED ON THE DRAWINGS APPROVAL OF THE SHOP DRAWINGS BY THE ENGINEER WILL NOT WAIVE THE CONTRACTOR OF THIS RESPONSIBILITY.
- 9. THE CONTRACTOR SHALL HAVE THE FINAL RESPONSIBILITY FOR SYSTEM START UP AND TURN OVER TO THE OWNER.
- 10. ALL ITEMS INCLUDED ON THESE DRAWINGS AND THE SPECIFICATIONS SHALL BE INCLUDED IN THE CONTRACTOR'S BID. IF THE CONTRACTOR DOES NOT CLEARLY UNDERSTAND THESE PLANS OR IS NOT SURE OF THEIR MEANING, THE CONTRACTOR SHOULD OBTAIN THE ENGINEER'S WRITTEN EXPLANATION AND INTERPRETATION PRIOR TO BID TIME. THE CONTRACTOR WILL BE HELD TO THE INTERPRETATION OF THE
- 11. FIRE CAULK ALL PENETRATIONS THRU FIRE RATED PARTITIONS TO MAINTAIN FIRE RATING OF PARTITION.
- 12. CAULK ALL PENETRATIONS THRU WALLS TO MINIMIZE SOUND PENETRATION THRU WALLS.
- 13. IT SHALL BE THE CONTRACTOR'S RESPONSIBILITY TO COORDINATE ALL TEMPERATURE CONTROL SYSTEM REQUIREMENTS.
- 14. ROUTE LINE SIZE PVC CONDENSATE DRAIN PIPING FROM AIR HANDLING UNIT TO NEAREST FLOOR DRAIN. PROVIDE TRAP AT CONNECTION TO AIR HANDLING UNIT
- 15. CONTRACTOR WILL BE RESPONSIBLE FOR ALL CUTTING AND PATCHING OF ROOFS/WALLS/FLOORS AND CORE DRILLS REQUIRED TO COMPLETE
- 16. THE CONTRACTOR SHALL BE RESPONSIBLE FOR PROVIDING ANY TEMPORARY FENCING AROUND THE LIFT SITE DURING LIFTS.

GENERAL NOTES (AIR SIDE)

- 1. NOTE, ALL DUCTWORK OFFSETS ARE NOT SHOWN. THE CONTRACTOR SHALL MODIFY DUCTS AND OFFSETS TO COORDINATE WITH THE BUILDING STRUCTURE AND ALL TRADE REQUIREMENTS.
- 2. ALL DUCTWORK SHALL BE CONSTRUCTED AND INSTALLED PER THE LATEST VERSION OF THE S.M.A.C.N.A. H.V.A.C. DUCT CONSTRUCTION STANDARDS, UNLESS SPECIFIED MORE STRINGENTLY IN THESE CONSTRUCTION DOCUMENTS. MINIMUM DUCT GAUGE SHALL BE 24.
- 90° DUCT ELBOWS SHALL BE EQUIPPED WITH SINGLE THICKNESS TURNING VANES MOUNTED TO A PREFABRICATED VANE RAIL.
- 4. ALL ELBOWS SHALL BE SUPPLIED WITH TURNING VANES, WHETHER SHOWN ON DOCUMENTS OR NOT.
- 5. ALL 90° AND 45° RECTANGULAR RADIUS ELBOWS TO BE FABRICATED WITH AN INSIDE RADIUS NO LESS THAN 1/2 OF THE WIDTH OF THE DUCT - WHERE THE WIDTH OF THE DUCT IS DEFINED AS THE DIMENSION OF THE DUCT IN THE PLANE IN WHICH THE DUCT IS
- 6. RECTANGULAR DUCTWORK SHALL BE SUPPORTED PER THE S.M.A.C.N.A STANDARDS AND AT EACH CHANGE IN DIRECTION.
- 7. PROVIDE MANUAL, SINGLE BLADE, BALANCING DAMPERS WITH LOCKING QUADRANT AND INTEGRAL POSITION INDICATOR ON ALL RUNOUTS TO SUPPLY AND EXHAUST AIR DEVICES - EXCEPT THOSE LOCATED IN AREAS WITH PLASTER CEILINGS AND ARE NOT ACCESSIBLE (DAMPER SHALL BE INTEGRAL WITH THE AIR DEVICE IN THESE CASES.)
- PROVIDE MANUAL OPPOSED BLADE DAMPERS WITH LOCKING QUADRANT AND INTEGRAL POSITION INDICATOR ON ALL RECTANGULAR BRANCH DUCTS AND AIR DEVICE RUNOUTS THAT EXCEED 12" IN HEIGHT.
- 9. MANUAL SPLITTER DAMPERS ARE NOT ACCEPTABLE.
- 10. NOT ALL OF THE ACCESS DOORS IN THE DUCT SYSTEMS OR PLENUMS ARE SHOWN. PROVIDE ACCESS DOORS IN ALL DUCT SYSTEMS OR PLENUMS WHERE REQUIRED TO ACCESS AND MAINTAIN MOTORIZED OR AUTOMATIC DAMPER BLADES AND LINKAGES.
- 11. ALL DUCTWORK SHALL BE SUPPORTED FROM ROOF OR FLOOR STRUCTURE ABOVE. DUCTWORK SHALL NOT LAY ON TOP OF CEILING OR LIGHT FIXTURES.
- 12. FLEXIBLE DUCT RUNOUTS TO AIR DEVICES SHALL NOT EXCEED 5'-0" IN LENGTH. FLEXIBLE RUNOUTS SHALL BE TRIMMED TO THE MINIMUM LENGTH NECESSARY TO MAKE THE CONNECTION.
- 13. WHERE DAMPER ACTUATORS ARE MOUNTED TO DUCTWORK OR PLENUMS PROVIDE A HEAVY GAGE BASE PLATE, ANGLE STIFFENERS, OR MOUNTING AS REQUIRED TO ELIMINATE DEFLECTION OF DUCTWORK DURING ACTUATOR OPERATION.
- 14. FLEXIBLE DUCT CONNECTIONS TO EQUIPMENT ARE NOT SHOWN ON THE DRAWINGS. PROVIDE EXTRA WIDE FLEXIBLE CONNECTIONS ON THE SUPPLY DUCT AND THE RETURN DUCT OF EACH MAKE-UP AIR UNIT, ROOFTOP UNIT, AND EACH AIR HANDLING UNIT. PROVIDE STANDARD FLEXIBLE CONNECTIONS ON ALL BLOWER COILS. EXHAUST FANS, SUPPLY FANS, AND DUST COLLECTOR.

(HATCHING DESIGNATES ZERO THROW)

SHOE DUCT TAP FROM RECT. MAIN

DAMPERED SHOE DUCT TAP FROM RECT. MAIN

STRAIGHT RECT. DUCT TAP FROM RECT. MAIN

(AIR DEVICE TYPE) - (SCHEDULE NUMBER)

STRAIGHT RECT. DUCT TAP FROM ROUND MAIN S - SUPPLY DIFFUSER

SIDEWALL AIR DEVICE

45° DAMPERED DUCT TAP

45° DUCT TAP

SADDLE TAP

(AIR FLOW IN CFM)

SPECIFIED.)

NOTE: NOT ALL SYMBOLS OR ABBREVIATIONS MAY BE USED.

FLAT OVAL DUCT

DUCT SIZE DESIGNATION:

1ST FIGURE SIDE SHOWN. (SIZE

ALLOWANCE HAS NOT BEEN MADE

FOR INTERIOR INSULATION WHERE

SHOWN IS FREE AREA SIZE.

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1000

24" x 12" RA

24"/12"

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AIR DEVICE TYPE:

T - TRANSFER GRILL

R - RETURN GRILLE

E - EXHAUST GRILLE

DUCT SYSTEM TYPE:

SA - SUPPLY AIR

RA - RETURN AIR

EA - EXHAUST AIR

TA - TRANSFER AIR

OA - OUTDOOR AIR

AFM

CVR

- 15. PROVIDE 45° FLARED TAKEOFFS FOR ALL RECTANGULAR BRANCH CONNECTIONS TO THE MAIN DUCT.
- 16. ALL DAMPER ACTUATORS FOR DUCT SYSTEMS OR EQUIPMENT THAT COMMUNICATES DIRECTLY WITH THE OUTDOORS SHALL BE SPRING RETURN TYPE TO CLOSE IN THE EVENT OF A POWER FAILURE.
- 17. PROVIDE 1-1/2 HOUR RATED FIRE DAMPERS IN THE DUCTWORK WHERE INDICATED ON THE PLANS AND REQUIRED BY CODE. FIRE DAMPERS SHALL BE PROVIDED WITH AN ACCESS PANEL LARGE ENOUGH TO PERMIT INSPECTION AND MAINTENANCE OF THE DAMPER. ACCESS PANELS TO FIRE DAMPERS SHALL BE PERMANENTLY IDENTIFIED ON THE EXTERIOR BY A NAMEPLATE WITH THE WORDS "FIRE DAMPER". THE LETTERS ON THE FIRE DAMPER LABELS SHALL NOT BE LESS THAN 1/2 INCH IN HEIGHT.
- 18. THE SPACE ABOVE THE SUSPENDED CEILINGS SHALL BE USED AS A RETURN AIR PLENUM. IT IS THE RESPONSIBILITY OF THE MECHANICAL CONTRACTOR TO COORDINATE THE WORK OF OTHER TRADES TO PROVIDE ADEQUATE SPACE FOR THE FLOW OF RETURN AIR (250 FPM MAXIMUM VELOCITY). WHERE PARTITIONS EXTEND TO THE CONSTRUCTION ABOVE, OPENINGS SHALL BE PROVIDED IN THE PARTITION ABOVE THE CEILING.
- 19. DUCT DIMENSIONS NOTED ON THE DRAWINGS ARE NET FREE AREA. WHERE ACOUSTIC LINER IS INDICATED OR SPECIFIED THE SHEET METAL SIZE MUST BE INCREASED TO ACCOMMODATE THE LINER.
- 20. AREAS ABOVE THE CEILING SERVE AS A RETURN AIR PLENUM. ALL MATERIALS EXPOSED IN THE PLENUM SHALL HAVE A 25/50

SMOKE/FLAME SPREAD RATING.

- 21. ALL DUCT RUNOUTS TO AIR DEVICES ARE TO BE THE SAME SIZE AS THE NECK OF THE AIR DEVICE UNLESS NOTED OTHERWISE.
- 22. DIRECTIONAL ARROWS ON AIR DEVICES INDICATE THROWS FOR AIR DEVICE. VERIFY PROPER ADJUSTMENT OF THROW DEFLECTION VANES OF ALL AIR DEVICES PRIOR TO BEGINNING BALANCING. WHERE NO ARROWS SHOW, THROW SHALL BE 4-WAY.
- 23. ALL BATHROOM EXHAUST DUCTWORK SHALL BE EXTERNALLY INSULATED.
- 24. EXPOSED GALVANIZED DUCTWORK SHALL BE PAINTABLE. GENERAL CONTRACTOR TO PAINT ALL EXPOSED DUCTWORK. FINAL COLOR TO BE APPROVED BY THE ARCHITECT.

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MISCELLANEOUS SYMBOLS

RISER DESIGNATION

- (RISER NUMBER)

(DETAIL NUMBER)

DETAIL DESIGNATION

(SECTION NUMBER)

KEYED NOTES

REVISIONS

AP ACCESS PANEL

NEW CONNECTION

AIR FLOW MEASURING STATION

CONSTANT VOLUME REGULATOR

SECTION DESIGNATION

EQUIPMENT OR PLUMBING FIXTURE DESIGNATION

(SHEET NUMBER WHERE DETAIL IS FOUND)

(SHEET NUMBER WHERE SECTION IS FOUND)

TEE (SIDE OUTLET UP) TEE (SIDE OUTLET DOWN) ELBOW (TURNED UP) ELBOW (TURNED DOWN) B) BMD COMBINATION BALANCING & MEASURING DEVICE ECR ECCENTRIC REDUCER ——(M)—— FMD FLOW MEASURING DEVICE \longrightarrow STEAM TRAP — (RISER INDICATION P=PLUMBINGKP =KITCHENAP =ACID) $\longrightarrow \bigvee \longrightarrow$ **BALANCING VALVE** FLEXIBLE CONNECTION **ELBOW** \vdash TEE **ABBREVIATIONS** FINISH FLOOR ELEVATION AFF ABOVE FINISH FLOOR TOP ELEVATION **BOTTOM ELEVATION** FLOW LINE INVERT ELEVATION CENTER LINE GENERAL CONSTRUCTION CONTRACTOR HAC **HEATING & AIR CONDITIONING CONTRACTOR** PC PLUMBING CONTRACTOR ELECTRICAL CONTRACTOR ACS AUTOMATIC CONTROL SUB-CONTRACTOR FIRE PROTECTION CONTRACTOR HSC HALON SUB-CONTRACTOR KEC KITCHEN EQUIPMENT CONTRACTOR MC MECHANICAL CONTRACTOR TEMPERATURE CONTROL CONTRACTOR



WRIGHT RA



<u>ARCHITECT</u>

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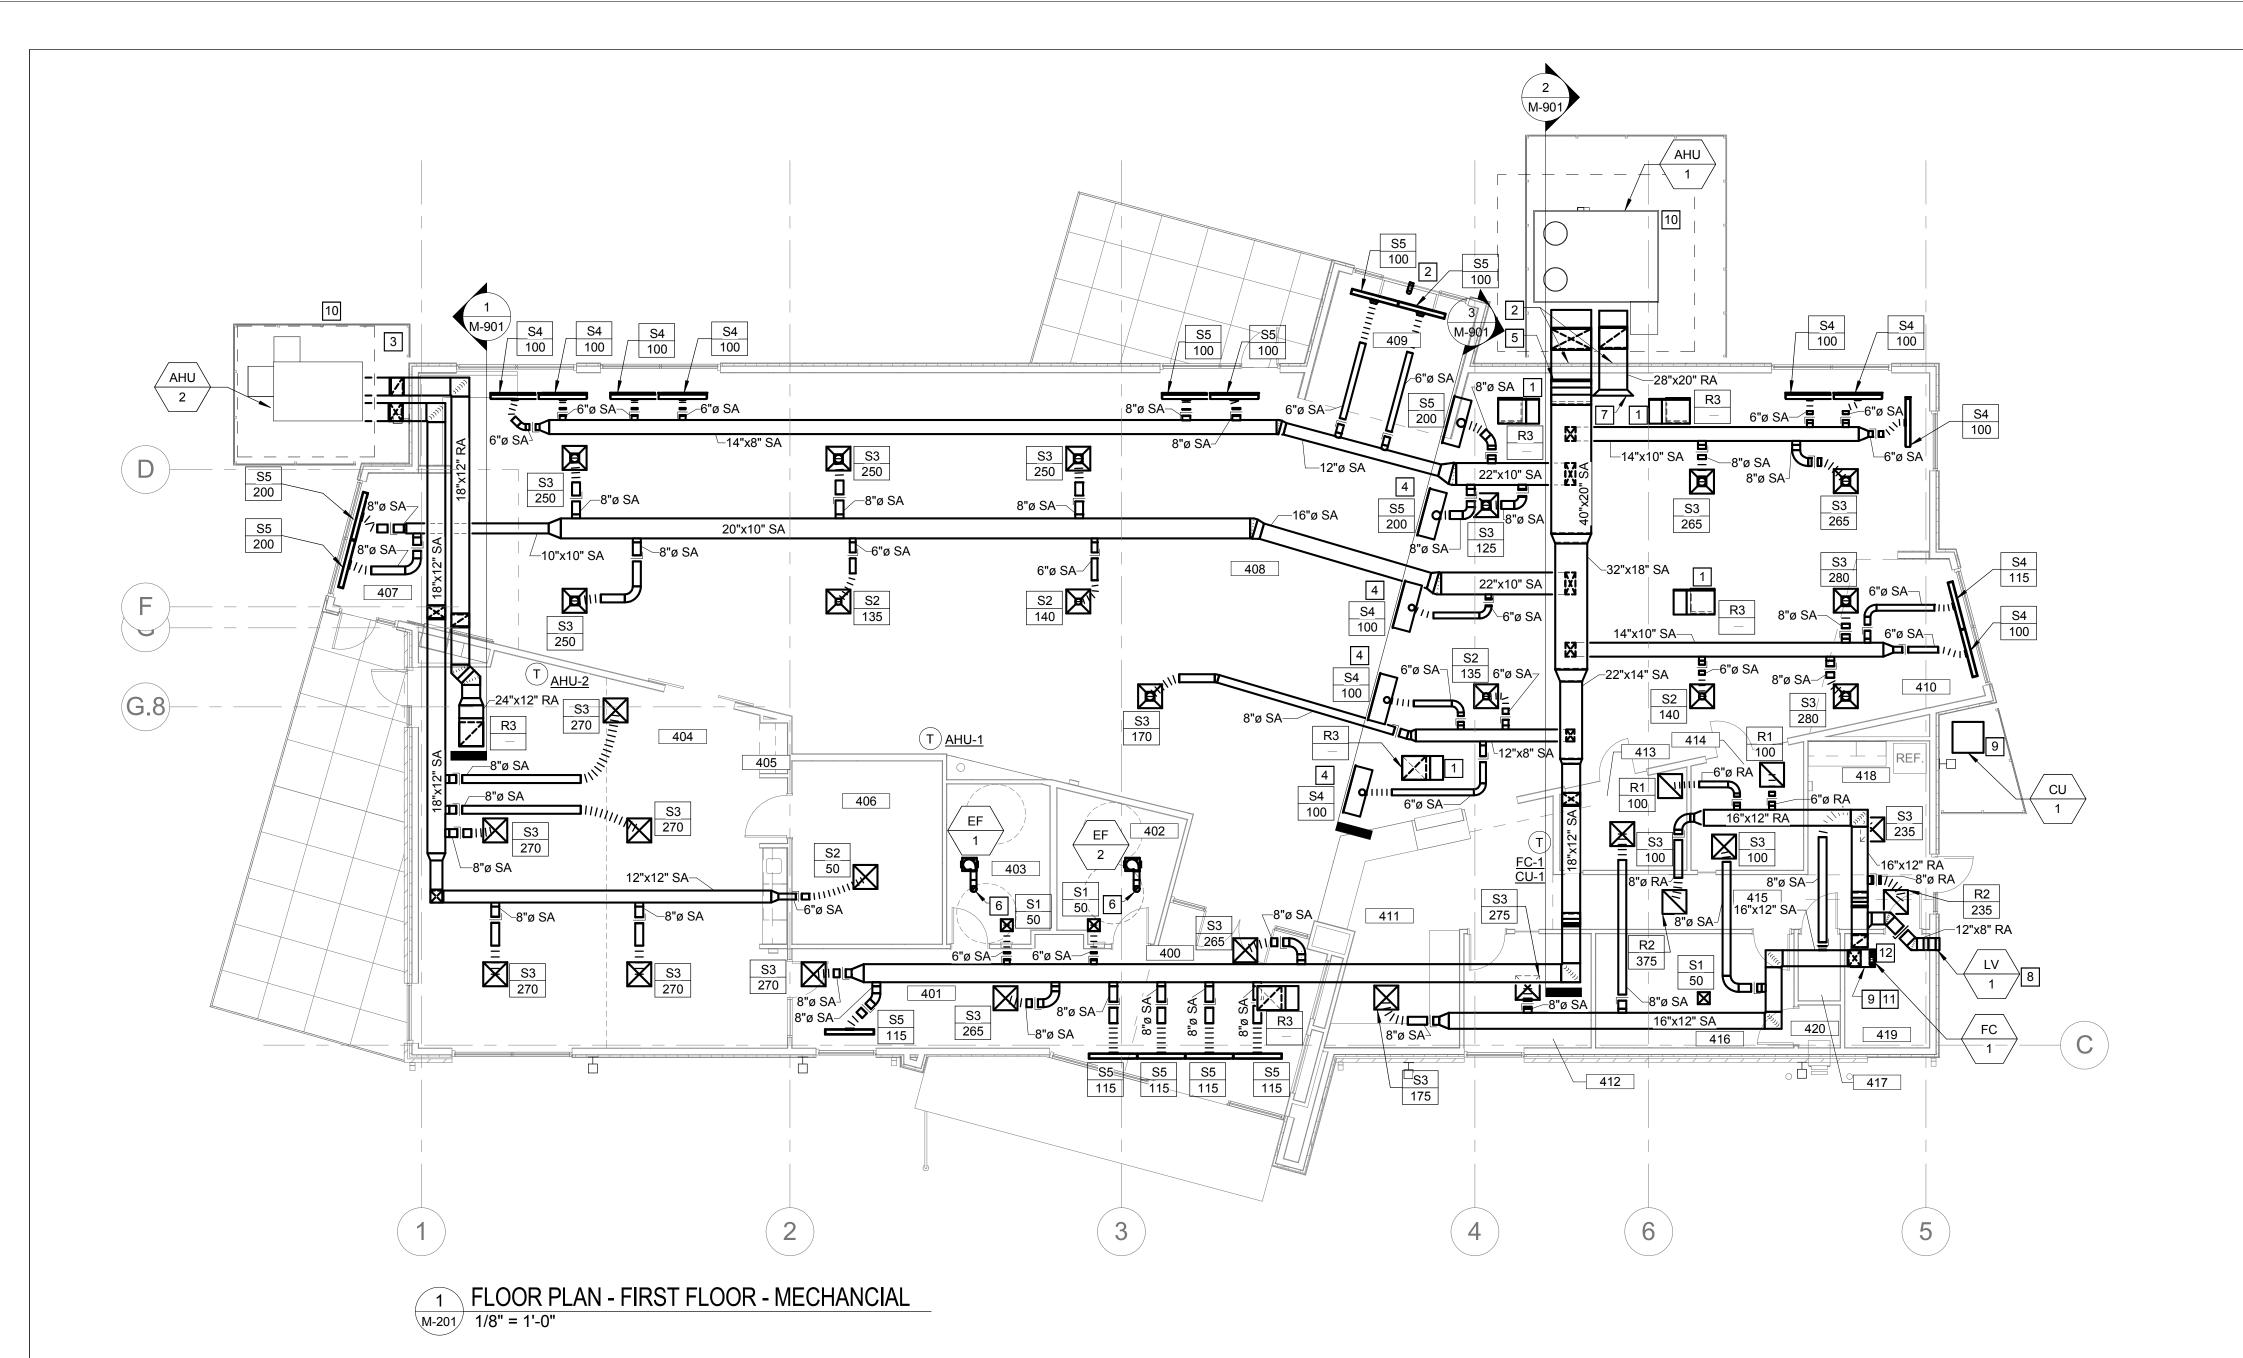
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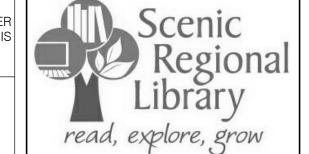
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PROJECT NUMBER: **16-1161.03**

SHEET TITLE: LEGEND, SYMBOLS, NOTES, & **ABBREVIATIONS - MECHANICAL**



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GENERAL NOTES

SEE SHEET M-001 FOR GENERAL NOTES THAT APPLY TO THIS

KEYED NOTES

- ROUTE SUPPLY AND RETURN DUCTWORK UP EXTERIOR WALL PENETRATE THROUGH WALL WITH BOTTOM OF DUCT AT 15'-1" AFF. PROVIDE DRAINABLE ALUMINUM JACKET OVER INSULATION.
- FOR MOUNTING HEIGHTS. SLOPE DUCT WITH ROOF. SEE SECTION FOR FURTHER DETAILS.
- 6 8" Ø EXHAUST DUCT UP THROUGH ROOF. TERMINATE WITH GOOSENECK. SEE DETAILS FOR FURTHER REQUIREMENTS.
- TRANSITION DUCT AS REQUIRED TO CONNECT TO LOUVER. TOP
- MINIMUM OF 12" LONG. CONTRACTOR SHALL FIELD ROUTE REFRIGERANT PIPING
- ROUTED ON INTERIOR OF BUILDING UNTIL PENETRATION IS PROVIDED WITH PAINTABLE ALUMINUM JACKETS.

- PROVIDE RETURN AIR BOOT. SEE DETAIL FOR ADDITIONAL
- ROUTE SUPPLY AND RETURN DUCTWORK UP EXTERIOR WALL.
 PENETRATE THROUGH WALL WITH BOTTOM OF DUCT AT 4'-8" AFF.
 PROVIDE DRAINABLE ALUMINUM JACKET OVER INSULATION.
- MOUNT SLOT DIFFUSER TO SIDEWALL OF SOFFIT. SEE SECTION
- PROVIDE 45°, 6" LONG BELL MOUTH FITTING AT INLET OF RETURN
- OF DUCT SHALL BE FLUSH WITH TOP OF LOUVER; SLOPE BOTTOM OF DUCT DOWN TOWARDS LOUVER. TRANSITION SHALL BE A
- BETWEEN FC-1 AND CU-3. REFRIGERANT PIPING SHALL BE WITHIN FENCED IN REGION. ALL PIPING INSULATION SHALL BE 10 ROUTE CONDENSATE PIPING TO FRENCH DRAIN. LOCATE
- FRENCH DRAIN A MINIMUM OF 2'-0" AWAY FROM SLAB EDGE. PROVIDE SUPPORTS FOR CONDENSATE PIPING AT A MINIMUM OF 5'-0" INTERVALS. DRAIN PIPING SHALL BE COPPER. 11 ROUTE CONDENSATE DRAIN PIPING TO FLOOR DRAIN IN ROOM.

DRAIN PIPING SHALL BE COPPER.

12 4" Ø FLUE UP FROM FC-1 THROUGH ROOF.

WRIGHT



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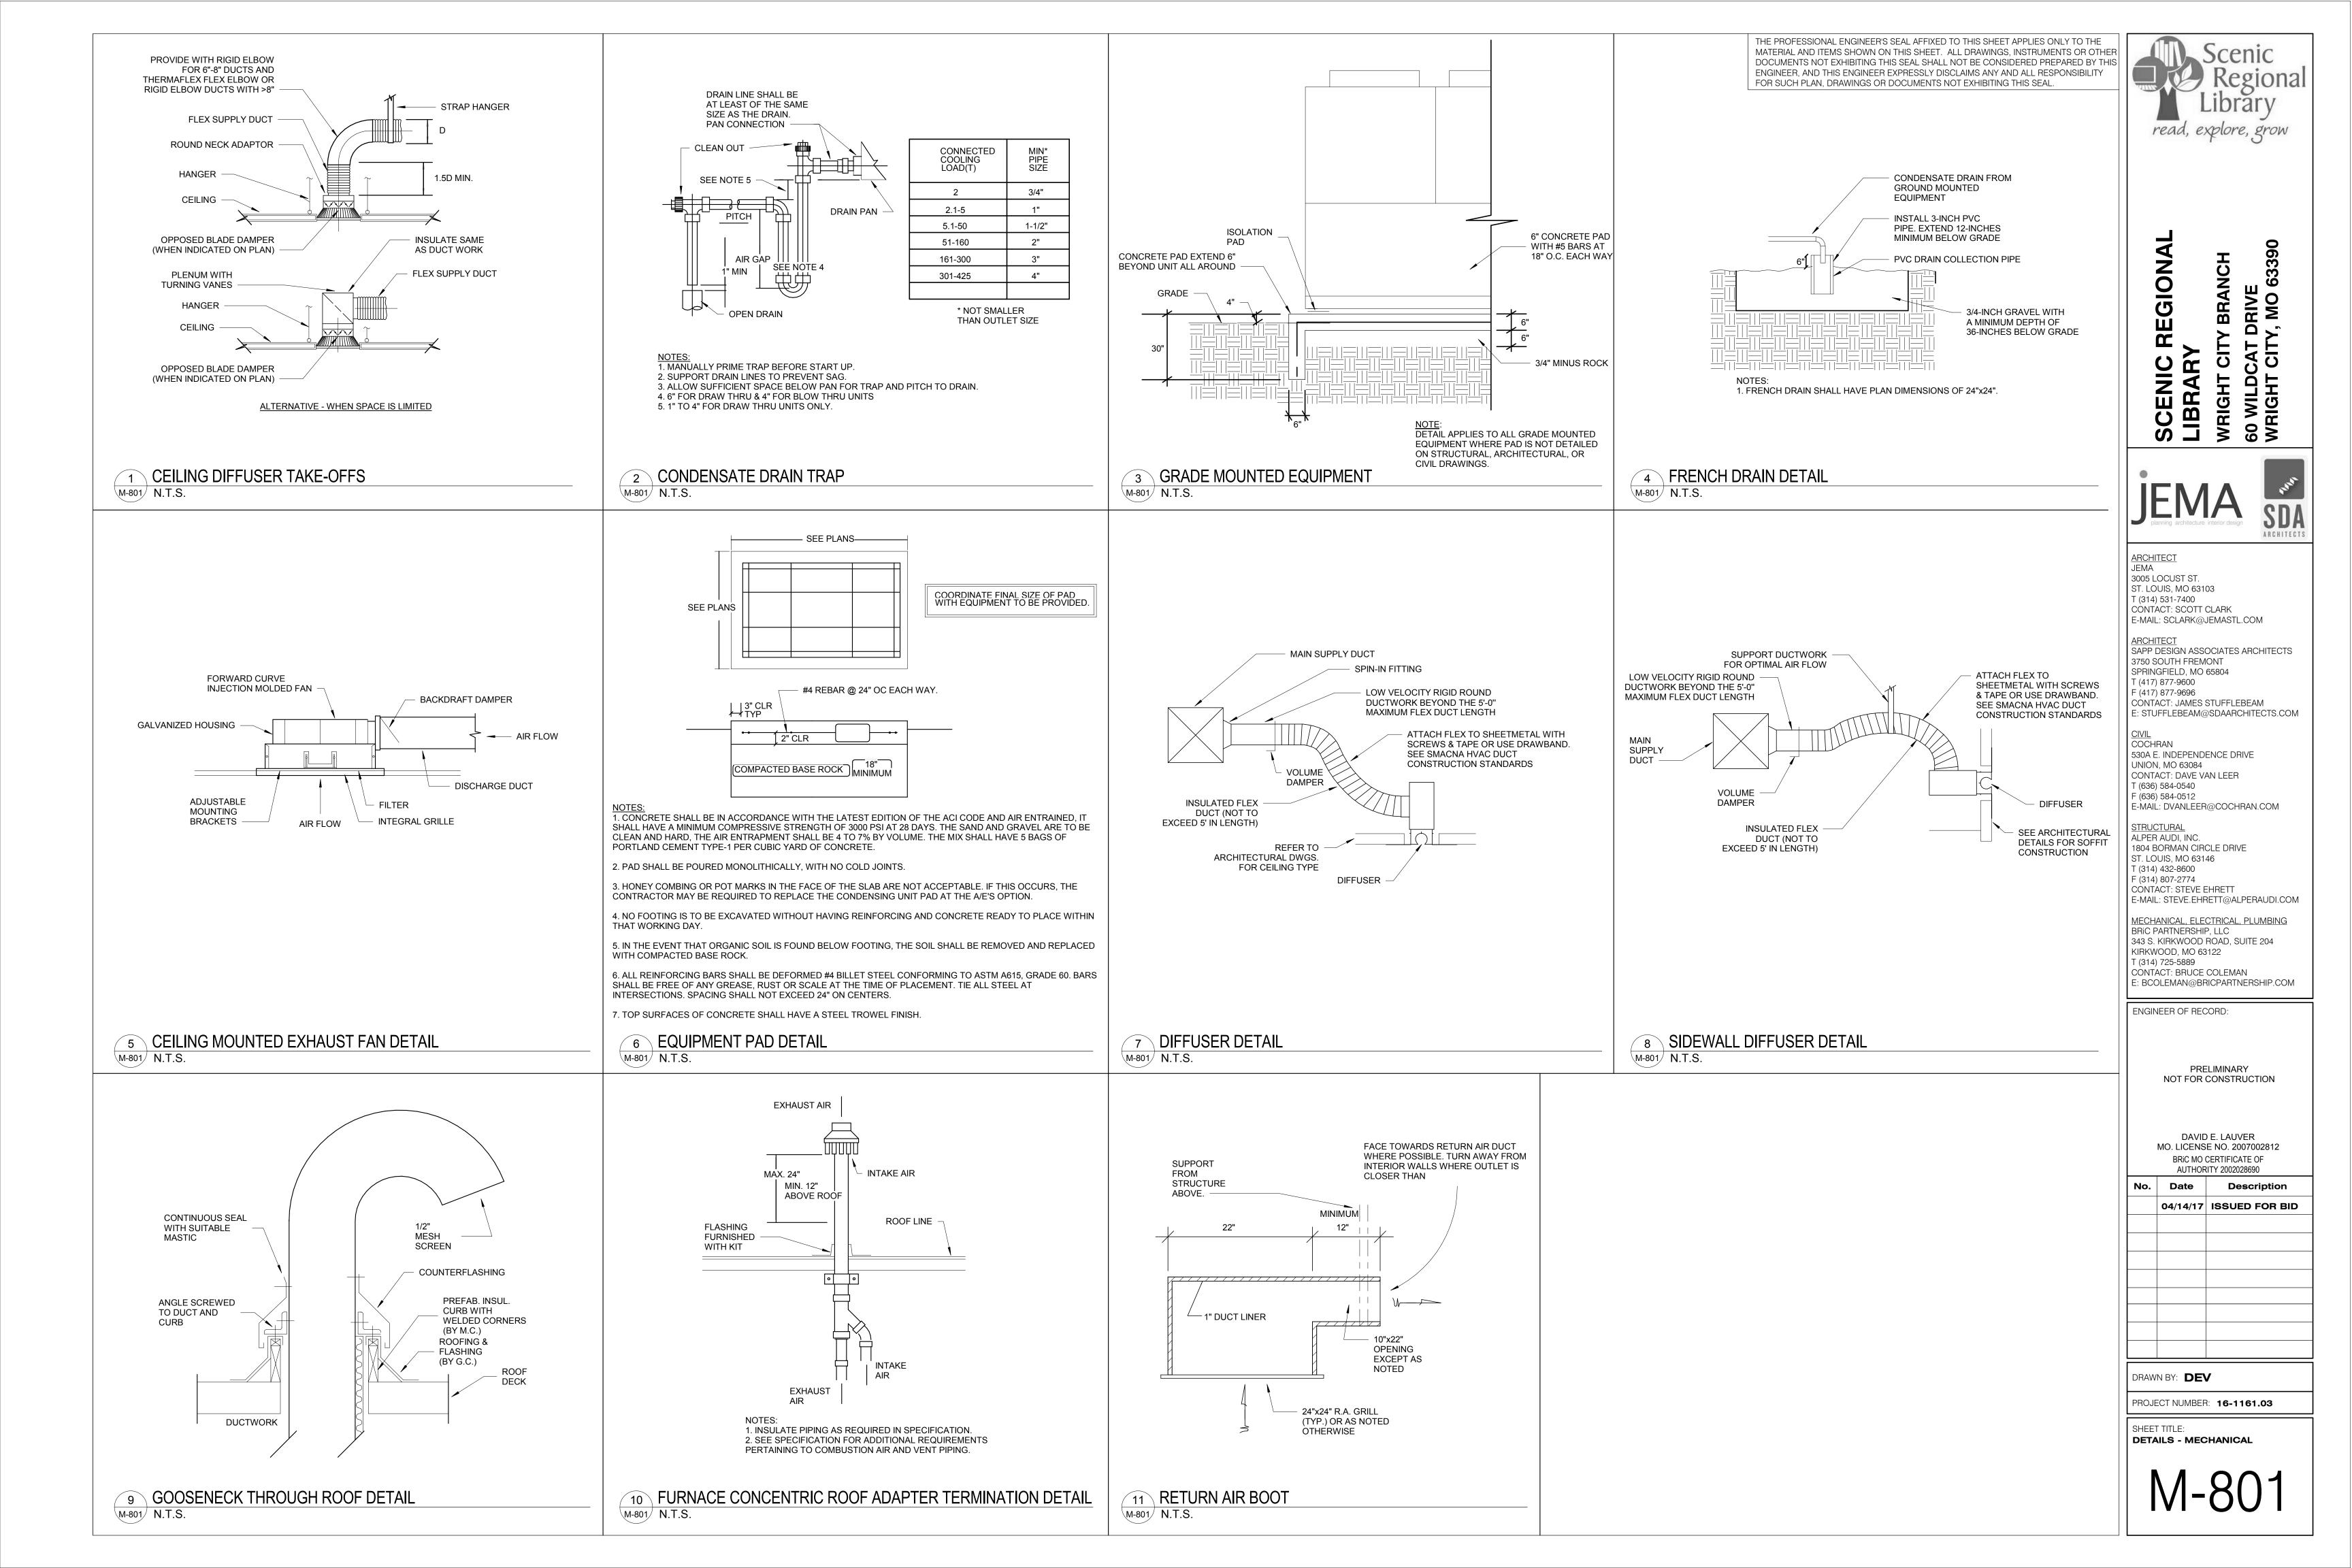
MECHANICAL

FLOOR PLAN - FIRST FLOOR -

ROOM SCHEDULE

Number	Name
00	CIRCULATION
00	VESTIBULE
01	CORRIDOR
02	MENS
03	WOMENS
04	MEETING ROOM
05	COATS
06	STORAGE
07	CHILDREN AREA
08	CIRCULATION
09	ADULT AREA
10	TEEN AREA
11	WORK ROOM
12	OFFICE
13	STUDY
14	STUDY
15	CORRIDOR
16	STORAGE
17	JANITORS CLOSET
18	BREAK ROOM
19	MECH / ELEC

BOOK DROP



1, 2, 3

read, explore, grow

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MECHANICAL

SCHEDULES & SECTIONS -

PACKAGED AIR HANDLING UNIT COOLING PERFORMANCE HEATING PERFORMANCE **EXTERNAL** STATIC TOTAL **INPUT** OUTPUT OPERATING **PRESSURE** CAPACITY CAP. CAP. REFRIGERANT WEIGHT (IN. WG) (MBh) (MBh) EDB (F°) | EWB (F°) | AMBIENT (F°) | LDB (F°) | DWB (F°) (MBh) USED (LBS) NOTES

PLAN MARK

AHU 2

SEE SHEET E-901 FOR ELECTRICAL REQUIREMENTS.

HEATING PERFORMANCE BASED ON FULL FLOW AND MINIMUM OUTSIDE AIRFLOW. PROVIDE WITH INTEGRAL CONTROLS TO PROVIDE SINGLE ZONE VAV FAN OPERATION AS DEFINED BY ASHRAE 90.1

MODEL

ZST15N30

ZVTA4N06

SUPPLY

AIRFLOW

CFM

6580

1400

MINIMUM

OUTSIDE AIR

FLOW CFM

MINIMUM

HEATING

CFM

2500

SECTION 6.4.3.10 TO MAINTAIN SPACE TEMPERATURE AND SPACE CO2 SET POINT. SPACE SENSOR SHALL BE 7 DAY PROGRAMMABLE TYPE WITH PASSWORD PROTECTION.

MANUFACTURER

JOHNSON CONTROLS

JOHNSON CONTROLS

PROVIDE STAINLESS STEEL OR COMPOSITE DRAIN PAIN TO MEET ASHRAE 62.1. PROVIDE WITH 14" SEISMIC CURB FOR GRADE MOUNTING OF UNIT.

PROVIDE WITH 100% ECONOMIZER WITH POWER EXHAUST AND BAROMETRIC RELIEF KIT.

UNIT SHALL BE CONFIGURED FOR HORIZONTAL SUPPLY AND RETURN. PROVIDE WITH SINGLE POINT POWER CONNECTION, DISCONNECT SWITCH, AND CONVENIENCE OUTLET.

PROVIDE WITH STAINLESS STEEL OR ALUMINIZED STEEL BURNER.

ROOF HIGH SIDE 17' - 11 1/2" 12"x18" SA —12"x18" RA └24"x24" RA

	FURNACE SCHEDULE																
PLAN MARK SUPPLY FAN					D-X CIRCUITING					GAS HEATING COIL							
			SUPPLY	OUTSIDE	MOTOR	CAP.	MBH	E	ΑΤ	L.A	ΑΤ	MBH	MBH			WEIGHT	
	MANUFACTURER	MODEL	CFM	AIR CFM	H.P	TOTAL	SENS.	DB (°F)	WB (°F)	DB (°F)	WB (°F)	INPUT	OUTPUT	EAT (°F)	LAT (°F)	(LBS.)	NOTES
FC 1	GUARDIAN	RGF19060	1200	120	0.5	34.2	22.9	80	67	62.3	58.1	60	57	60	104	122	1

SEE SHEET E-901 FOR ELECTRICAL REQUIREMENTS.

CONDENSING UNIT SCHEDULE									
PLAN MARK			ASSOCIATED	COOLING	REFRIGERANT	UNIT WEIGHT			
	MANUFACTURER	MODEL	INDOOR UNIT	CAPACITY (MBh)	TYPE	(LBS)	NOTES		
CU 1	GUARDIAN	RAC	FC-1	36.0	R410A	160.00	1		

300.0

240.0


R-410A

R-410A


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SEE SHEET E-901 FOR ELECTRICAL REQUIREMENTS.

1 AHU-2 DUCTWORK THROUGH 408 CIRCULATION

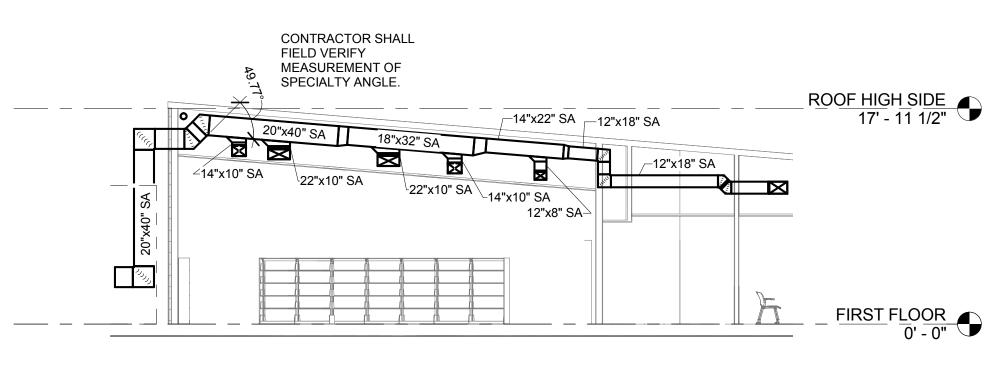

2 AHU-1 DUCTWORK THROUGH 408 CIRCULATION M-901 1/8" = 1'-0"

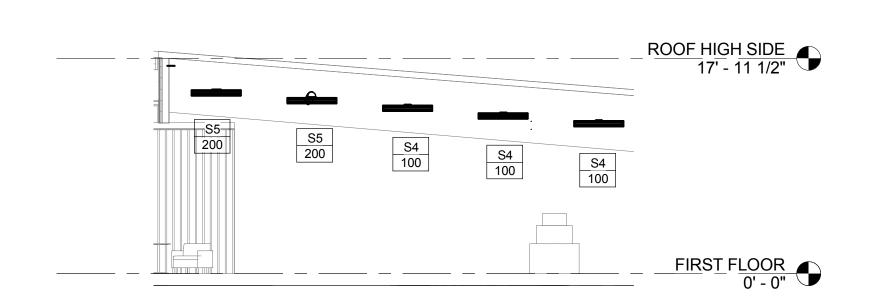

3 SIDEWALL DIFFUSERS IN CIRCULATION 408 M-901/1/8" = 1'-0"

						AIR D	EVICE SC	HEDULE	Ξ					
					FA	CE				AIR TERMINAL				
TYPE MARK	MANUFACTURER	MODEL	STYLE	CONNECTION SIZE	LENGTH	WIDTH	MAXIUMUM AIRFLOW (CFM)	THROW (FT)	MAX NC LEVEL	STATIC PRESSURE (IN-WG)	MATERIAL	FINISH	MOUNTING TYPE	NOTES
S1	TITUS	OMNI	SQUARE PLAQUE	6"ø	12"	12"	100	8	30	0.10	STEEL	BWE	SURFACE MOUNT	1
S2	TITUS	OMNI	SQUARE PLAQUE	6"ø	24"	24"	160	7	30	0.10	STEEL	BWE	LAY-IN	1
S3	TITUS	OMNI	SQUARE PLAQUE	8"ø	24"	24"	300	12	30	0.10	STEEL	BWE	LAY-IN	1
S4	TITUS	FL-10	ONE 1" SLOT HIGHTHROW	6"ø	48"	3 3/4"	150	16	20	0.10	STEEL	BWE	LAY-IN OR SURFACE MOUNT	1
S5	TITUS	FL-10	TWO 1" SLOT HIGHTHROW	8"ø	48"	5 5/16"	300	25	30	0.10	STEEL	BWE	LAY-IN OR SURFACE MOUNT	1
R1	TITUS	350RL	GRILL	6"ø	24"	24"	160	-	30	0.10	STEEL	BWE	LAY-IN	1
R2	TITUS	350RL	GRILL	8"ø	24"	24"	280	-	30	0.10	STEEL	BWE	LAY-IN	1
R3	TITUS	350RL	GRILL	22"x22"	24"	24"	1500	-	30	0.10	STEEL	BWE	LAY-IN	1

1. PROVIDE WITH EARTHQUAKE TABS.

	LOUVER SCHEDULE										
PLAN MARK						MAX P.D.					
	MANUFACTURER	MODEL	CFM	DIMENSIONS	FREE AREA (%)	IN W.C.	MATERIAL	NOTES			
LV 1	RUSKIN	ELF6375DX	120	12"x12"	57	0.10	ALUMINUM	1,2			

COLOR TO BE SELECTED BY ARCHITECT. STYLE: CONTINUOUS DRAINABLE STATIONARY LOUVER, EXTENDED ALUMINUM.

EXHAUST FAN SCHEDULE												
PLAN	MARK	MANUFACTURER	MODEL	AIRFLOW (CFM)	EXTERNAL STATIC PRESSURE (IN-WC)	FAN RPM	INLET SONES	MOTOR POWER WATTS	NOTES			
EF	1	LOREN COOK	GC-162	150	0.12	1200	3.4	98	1			
EF	2	LOREN COOK	GC-162	150	0.12	1200	3.4	98	1			

1. SEE SHEET E-901 FOR ELECTRICAL REQUIREMENTS.

PLUMBING GENERAL NOTES - PLUMBING SHEETS ONLY

- 1. PIPING DRAWINGS ARE TO BE CONSIDERED SCHEMATIC AND ARE NOT INTENDED TO INDICATE ALL CHANGES IN DIRECTION. ALL NECESSARY FITTINGS TO BE FURNISHED AND INSTALLED BY THIS CONTRACTOR. PIPE AND FITTINGS MUST BE INSTALLED SO THAT ALL PIPE AND/OR INSULATION COMPLETELY CLEARS ALL NEARBY STRUCTURES, PIPING AND ITEMS BY OTHER CONTRACTORS.
- 2. CONTRACTOR SHALL VERIFY EXACT LOCATION, CONDITION, ELEVATION AND SIZES OF UTILITIES AT SITE BEFORE PROCEEDING WITH WORK.
- PLUMBING CONTRACTOR TO COORDINATE THE INSTALLATION OF ALL PIPING, VALVES, AND EQUIPMENT WITH GENERAL CONTRACTOR AND RELATED STRUCTURAL, MECHANICAL, ELECTRICAL, AND FIRE PROTECTION CONTRACTORS.
- 4. ALL FIXTURES AND PIPING SHALL BE SIZED, VENTED, TRAPPED AND INSTALLED IN ACCORDANCE WITH INTERNATIONAL PLUMBING CODE 2003 EDITION AND INTERNATIONAL BUILDING CODE 2003 EDITION.
- 5. CONTRACTOR SHALL PROTECT ALL ADJACENT AREAS DURING ALL PHASES OF CONSTRUCTION.
- 6. ANY HOLES LEFT IN WALL CONSTRUCTION DUE TO WORK SHALL BE PATCHED AND PAINTED BY THIS CONTRACTOR TO MATCH CONSTRUCTED CONDITIONS. COORDINATE FINISH AND MATERIALS WITH ARCHITECT.
- 7. PLUMBING CONTRACTOR TO FURNISH AND INSTALL SUPPLY STOP SHUT-OFF VALVES ON ALL FIXTURE WATER SUPPLY LINES. FURNISH AND INSTALL WATER HAMMER ARRESTORS AS INDICATED ON PLANS. INSTALL VALVES IN ACCESSIBLE LOCATION. IF LOCATION IS NOT READILY ACCESSIBLE, COORDINATE ACCESS PANEL REQUIREMENTS WITH GENERAL CONTRACTOR.
- 8. PLUMBING CONTRACTOR TO FURNISH AND INSTALL SHUT-OFF VALVES AND ACCESS PANELS AT THE BASE OF ALL WATER SUPPLY PIPING
- 9. PLUMBING CONTRACTOR TO PROVIDE CLEANOUT AT THE BASE OR NO MORE THAN 4 FT ABOVE FLOOR OF ALL WASTE, AND SANITARY STACKS.
- 10. PLUMBING CONTRACTOR SHALL VERIFY THAT ALL VALVES IN THE COLD AND HOT WATER SUPPLY PIPING ARE IN THE FULLY OPEN POSITION. CONTRACTOR TO VERIFY ALL BALANCING VALVES ON HOT WATER CIRCULATING PIPING ARE OPEN AND ADJUSTED AS NOTED TO ASSURE PROPER CIRCULATION.
- 11. PLUMBING CONTRACTOR TO FURNISH AND INSTALL EQUIPMENT DRAINS FOR ALL APPLIANCES (AIR HANDLERS, WATER HEATERS, KITCHEN EQUIPMENT, (ETC.) AND ROUTE TO THE NEAREST FLOOR DRAIN. PROVIDE INDIRECT CONNECTION AT DRAIN AS REQUIRED. FINAL CONNECTION TO EQUIPMENT SHOULD BE MADE BY CONTRACTOR PROVIDING EQUIPMENT UNLESS OTHERWISE NOTED.
- 12. WATER TEMPERATURE SETTING FOR WATER HEATER AND THERMOSTATIC MIXING VALVES SHALL BE AS FOLLOWS: WATER HEATER 140 DEG F
 THERMOSTATIC MIXING VALVE 110 DEG F
- 13. ALL PIPING SHALL BE CONCEALED IN CHASE, WALLS, CEILING, FLOORING, ETC. UNLESS OTHERWISE NOTED. PIPING SHOWN OUTSIDE OF WALL FOR CLARITY ONLY.

- 14. REFER TO PLUMBING FIXTURE SCHEDULE FOR WASTE, VENT AND SUPPLY SIZES TO INDIVIDUAL FIXTURES.
- 15. EQUIPMENT AND FIXTURE SYMBOLOGY MAY NOT REFLECT ACTUAL TYPE. REFER TO SPECIFICATIONS AND SCHEDULES FOR FIXTURE OR EQUIPMENT TYPE.
- 16. FIRE CAULK ALL PIPING PENETRATIONS THROUGH FIRE RATED PARTITIONS TO MAINTAIN FIRE RATING OF PARTITION. CONTRACTOR TO FIRESTOP ALL PENETRATIONS THROUGH FIRE-RATED FLOORS AND WALLS CREATED BY NEW WORK WITH "SPECSEAL SSS" OR EQUAL.
- 17. PLUMBING CONTRACTOR SHALL FURNISH AND INSTALL CONCRETE EQUIPMENT PAD FOR ALL EQUIPMENT SUPPLIED BY THIS CONTRACTOR. PAD SHOULD BE A MINIMUM OF 4" THICK.
- 18. ALL ITEMS INCLUDED ON THESE DRAWINGS AND THE SPECIFICATIONS SHALL BE INCLUDED IN THE CONTRACTOR'S BID. ANY ITEMS THAT ARE UNCLEAR OR FOUND TO BE INCORRECT BY THE CONTRACTOR SHALL BE BROUGHT, IN WRITING, TO THE ATTENTION OF THE ARCHITECT AND ENGINEER PRIOR TO THE BID DUE DATE.
- 19. CAULK ALL PIPING PENETRATIONS THROUGH WALLS TO MINIMIZE SOUND PENETRATION THROUGH WALLS.
- 20. INVERT ELEVATIONS ARE BASED ON FIRST FLOOR LEVEL BEING SET AT 100'-0".
- I. LOCATIONS OF ROOF DRAINS, FLOOR DRAINS, FLOOR SINKS, TRENCH DRAINS, ETC. INDICATED ON THESE DRAWINGS ARE CONSIDERED APPROXIMATE. THIS CONTRACTOR SHALL BE RESPONSIBLE FOR COORDINATION OF FINAL AND EXACT LOCATIONS WITH ALL OTHER TRADES AND EQUIPMENT SUPPLIERS PRIOR TO INSTALLATION. DRAINS, ETC., NOT CORRECTLY LOCATED AS DETERMINED BY THE ARCHITECT/ENGINEER/OWNER SHALL BE REMOVED AND RELOCATED AT THIS CONTRACTOR'S EXPENSE.
- 22. ALL VTR'S SHALL BE LOCATED A MINIMUM OF 12'-0" FROM AIR INTAKES ON MECHANICAL ROOFTOP EQUIPMENT. COORDINATE WITH ALL TRADES PRIOR TO INSTALLATION.
- 23. AREA ABOVE CEILINGS SERVE AS A RETURN AIR PLENUM. ALL MATERIALS EXPOSED IN THE PLENUM SHALL HAVE A 25/50 SMOKE/FLAME SPREAD RATING. NO PVC PIPING ALLOWED ABOVE CEILING. ALL SANITARY AND VENT PIPING TO BE CAST IRON ABOVE CEILING. ALL GAS PIPING ABOVE CEILING TO BE STEEL WITH WELDED JOINTS. ALL POLYPROPYPLENE WATER PIPING ABOVE CEILING SHALL BE WRAPPED TO ACHIEVE 25/50 SMOKE/FLAME SPREAD RATING.
- 24. MAKE ALL FINAL PLUMBING CONNECTIONS TO PLUMBING FIXTURES AND EQUIPMENT SHOWN ON PLANS.
- 25. EXCAVATION, BEDDING AND BACKFILL ASSOCIATED WITH BELOW SLAB PIPING INSTALLATION SHALL BE CONSIDERED PART OF THE PLUMBING CONTRACTOR'S WORK.
- 26. STARTING ELEVATION FOR SANITARY SEWER PIPING TO BE NOT LESS THAN 1'-6" BELOW FINISHED FLOOR UNLESS NOTED OTHERWISE.
- 7. ALL PLUMBING PIPING IN FINISHED ROOMS, OPEN TO STRUCTURE SHALL BE PAINTED TO MATCH STRUCTURE. DOMESTIC WATER PIPING SHALL BE PAINTED WITH PAINT THAT HAS ELASTOMERIC PROPERTIES, SUITABLE FOR PAINTING PLASTIC MATERIALS. FOLLOW PAINT MANUFACTURER'S INSTRUCTIONS FOR PIPE SURFACE PREPARATION AND PAINT APPLICATION.

	PLUMBING FIXTURE SCHEDULE (BASIS OF DESIGN)											
MARK	DESCRIPTION	MANUFACTURER	MODEL NUMBER	WASTE	VENT	COLD WATER	HOT WATER	NOTES				
WC-1	WATER CLOSET, FLOOR MOUNT	KOHLER	K-4405	4"	2"	-	-	ADA COMPLIANT, FLOOR MOUNT, FLOOR DISCHARGE				
	FLUSH VALVE	SLOAN	WES-111-W	-	-	1-1/4"	-	1.1 TO 1.6 gpf DUAL FLUSH MANUAL FLUSHOMETER				
LA-1	LAVATORY (WALL HUNG)	KOHLER	K-2005	1-1/2"	1-1/2"	-	-	WALL HUNG, ADA COMPLIANT, PROVIDE CARRIER				
	FAUCET	CHICAGO FAUCETS	895-317CP	-	-	1/2"	1/2"	ADA COMPLIANT LEVER HANDLES				
SK-1	SINK	ELKAY	LR1919	1-1/2"	1-1/2"			SINGLE BASIN, SS SINK				
	FAUCET	CHICAGO FAUCETS	895-317GN8AE29VPCP	-	-	1/2"	1/2"	2.2 GPM, WRIST BLADE PADDLES, 8" GOOSENECK				
WH-1	HOSE BIBB	WOODFORD	24	-	-	1/2"	-	INTERIOR, ANTI-SIPHON WALL HYDRANT				
OB-1	OUTLET BOX	OATEY	39140	-	-	1/2"	-					
TMV-1	THERMOSTATIC MIXING VALVE	LEONARD	TM-420 B-LF-DT	-	-	3/4"	3/4"	SET TO 110 DEGREE OUTLET TEMP.				
MSB-1	MOP SINK BASIN	FIAT	TSB3003	2"	1-1/2"	-	-	24" X 36" FLOOR SET, SS CAPS				
	MOP SINK FAUCET	FIAT	830-AA	-	-	1/2"	1/2"	-				
EWC-1	ELECTRIC WATER COOLER	ELKAY	EZH20	1-1/2"	1"	1/2"	-	BI-LEVEL ADA COOLER WITH BOTTLE FILLER				
GD-1	GARBAGE DISPOSAL	INSINKERATOR	EVOLUTION	-	-	-	-	INSTALL BELOW COUNTER				
OB-1	OUTLET BOX	SIOUX CHEIF	696-G1010MF	-	-	-	-	REFRIGERATOR/ICEMAKER OUTLET BOX; WITH ARRESTORS				

DRAIN SCHEDULE (BASIS OF DESIGN)							
MARK	MANUFACTURER	MODEL#	GRATE	BODY	STRAINER	NOTES	
FD-1	JAY R. SMITH	2110	NB	CI	SS	PROVIDE WITH TRAP GUARD TRAP SEAL, SURESEAL OR ENGINEER APPROVED EQUAL.	
FCO	SIOUX CHIEF	834-64DNR	N/A	DUCTILE IRON	N/A	NICKLE BRONZE ROUND COVER PLATE.	

NOTES

NB NICKEL BRONZE


SS STAINLESS STEEL

CI CAST IRON

- INDICATES NOT APPLICABLE

ELECTRIC WATER HEATER SCHEDULE							
MARK	MANUFACTURER	MODEL NO.	STORAGE	OUTLET TEMPERATURE ° F	RECOVERY AT 100° F RISE	INPUT	NOTES
EWH-1	A.O. SMITH	DEL-10D-4.5	10 GAL	140	18 GAL	4.5 KW	

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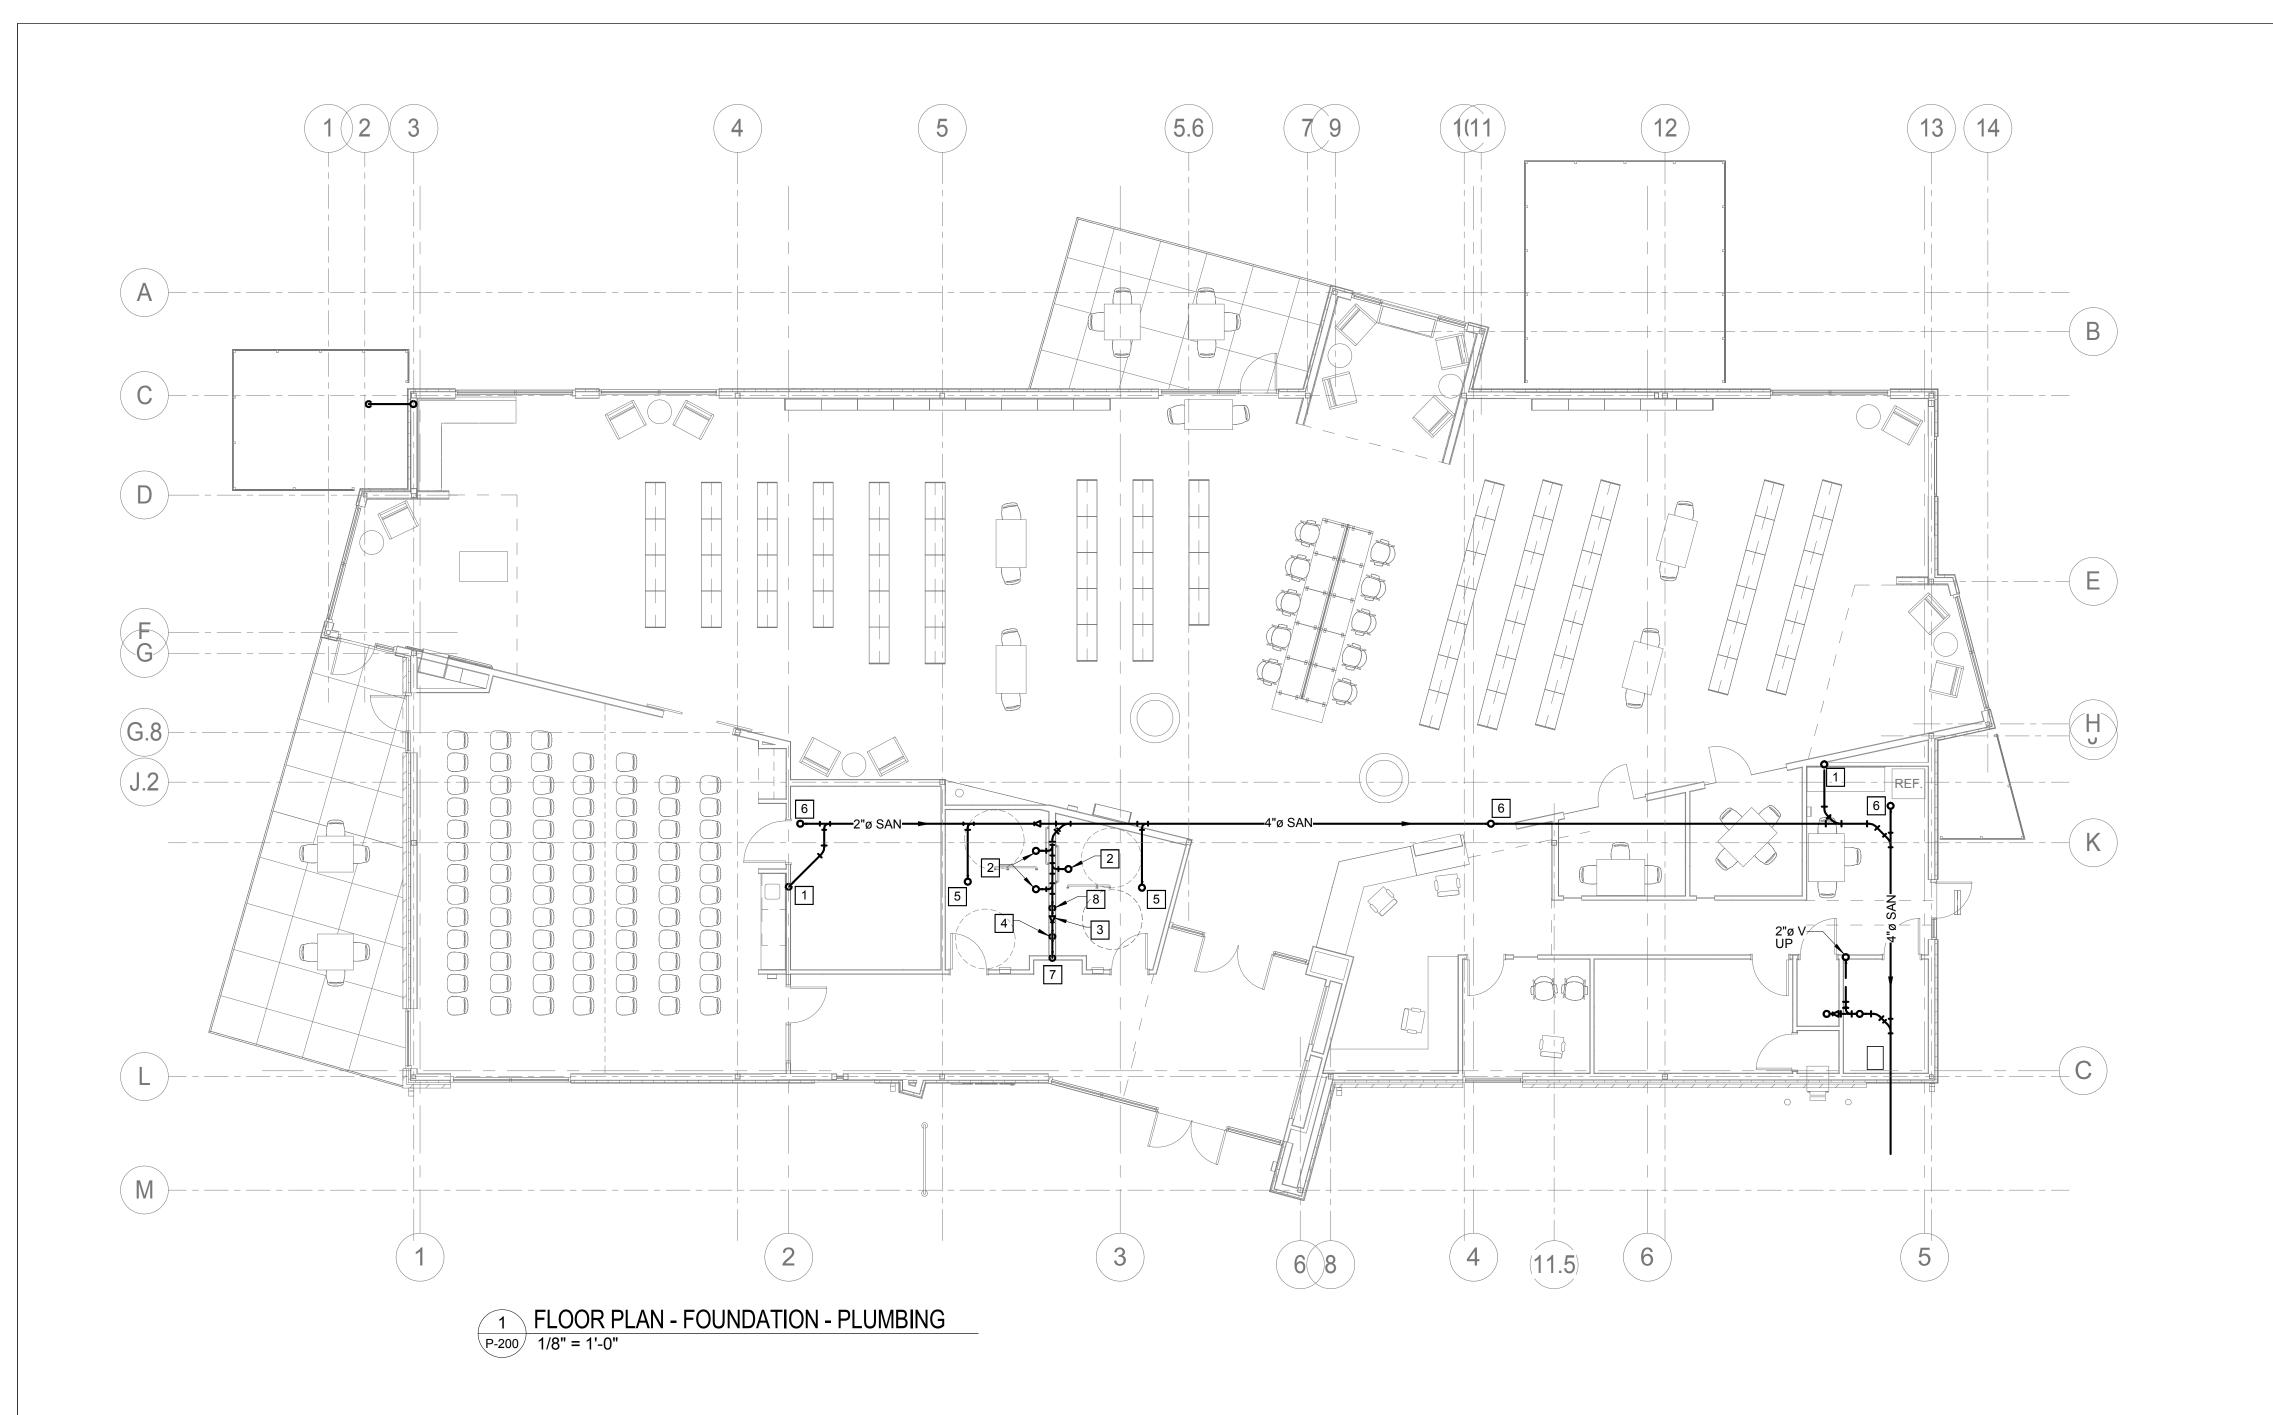
DRAWN BY: **DEV**PROJECT NUMBER: **16-1161.03**

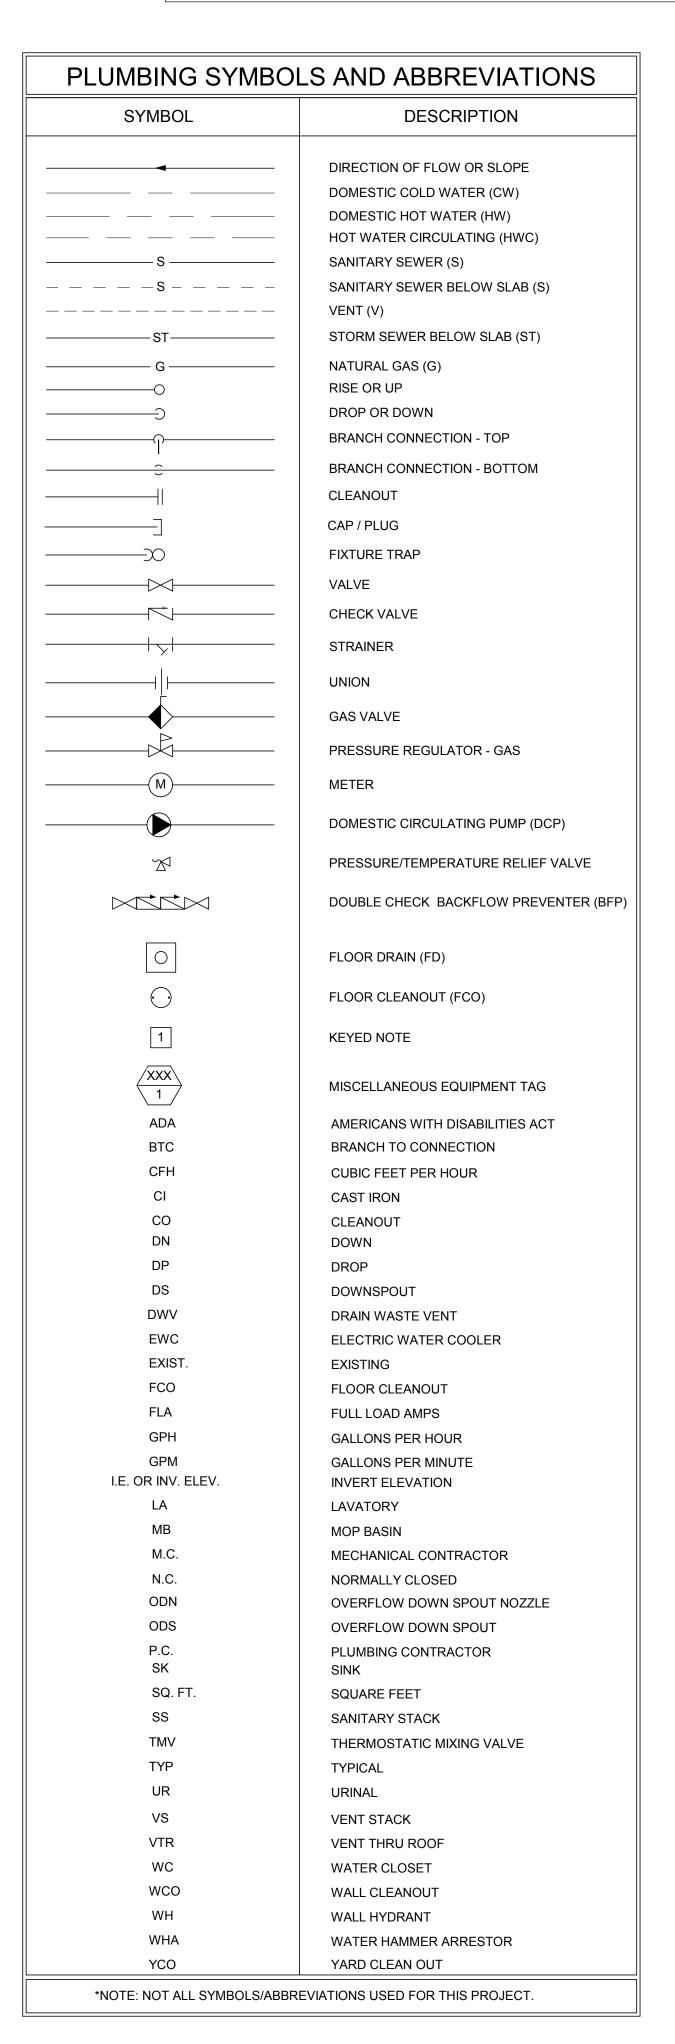SHEET TITLE:

LEGEND, SYMBOLS, NOTES,

ABBREVIATIONS, & SCHEDULES -

P-001



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1 SEE SHEET P-001 FOR GENERAL NOTES THAT APPLY TO THIS SHEET.

GENERAL NOTES

KEYED NOTES

- 2 4" SANITARY UP TO WC-1
- 3 CONNECT 2" SANITARY TO 4" SANITARY FROM WC-1.
- 4 2" SANITARY UP TO TWO LAV-1. 5 4" SANITARY UP TO FD-1.
- 6 2" SANITARY UP TO FCO.
- 7 2" SANITARY UP TO EWC-1. 8 2" SANITARY UP TO UR-1.

- 1 2" SANITARY UP TO SK-1.

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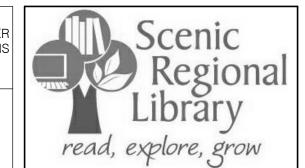
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FLOOR PLAN - FOUNDATION -PLUMBING

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GENERAL NOTES

SEE SHEET P-001 FOR GENERAL NOTES THAT APPLY TO THIS SHEET.

KEYED NOTES

- 1 3/4" NG DOWN TO FIREPLACE. ROUTE IN WALL. COORDINATE EXACT LOCATION WITH FIREPLACE CONNECTION.
- LOCATION OF GAS METER. SEE DETAIL FOR ADDITIONAL REQUIREMENTS.
- CONNECT 3/4" NG TO AHU-1. PENETRATE WALL 18" AFF. ROUTE TO AHU-2. SUPPORT PIPING ON GROUND.
- ROOF AND CEILING SLOPE.

- 7 1/2" CW AND HW DOWN TO AND 1 1/2" VENT UP FROM TWO LAV-1. 8 1/2" CW AND HW DOWN, AND 1 1/2" VENT UP FROM SK-1.
- 9 1 1/4" CW DOWN AND 2" VENT UP FROM WC-1.
- 10 1/2" CW AND HW, AND 1 1/2" VENT UP FROM EWC-1.
- 11 3/4" CW DOWN TO WH-1. MOUNT WH-1 18" ABOVE GRADE. 12 SEE DETAIL FOR EWH-1 PIPING REQUIREMENTS.
- REQUIREMENTS. 14 1/2" CW DOWN TO OB-1. INSTALL OB-1 UNDER COUNTER.

- DROP PIPING THROUGHOUT CIRCULATION TO COORDINATE WITH
- 5 3/4" NG DOWN THROUGH WALL. PENETRATE WALL 18" AFF. ROUTE TO AHU-2. SUPPORT PIPING ON GROUND.
- 6 3/4" NG DOWN TO FC-1.

- 13 REFER TO DETAIL ON SHEET P-801 FOR ADDITIONAL



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Description

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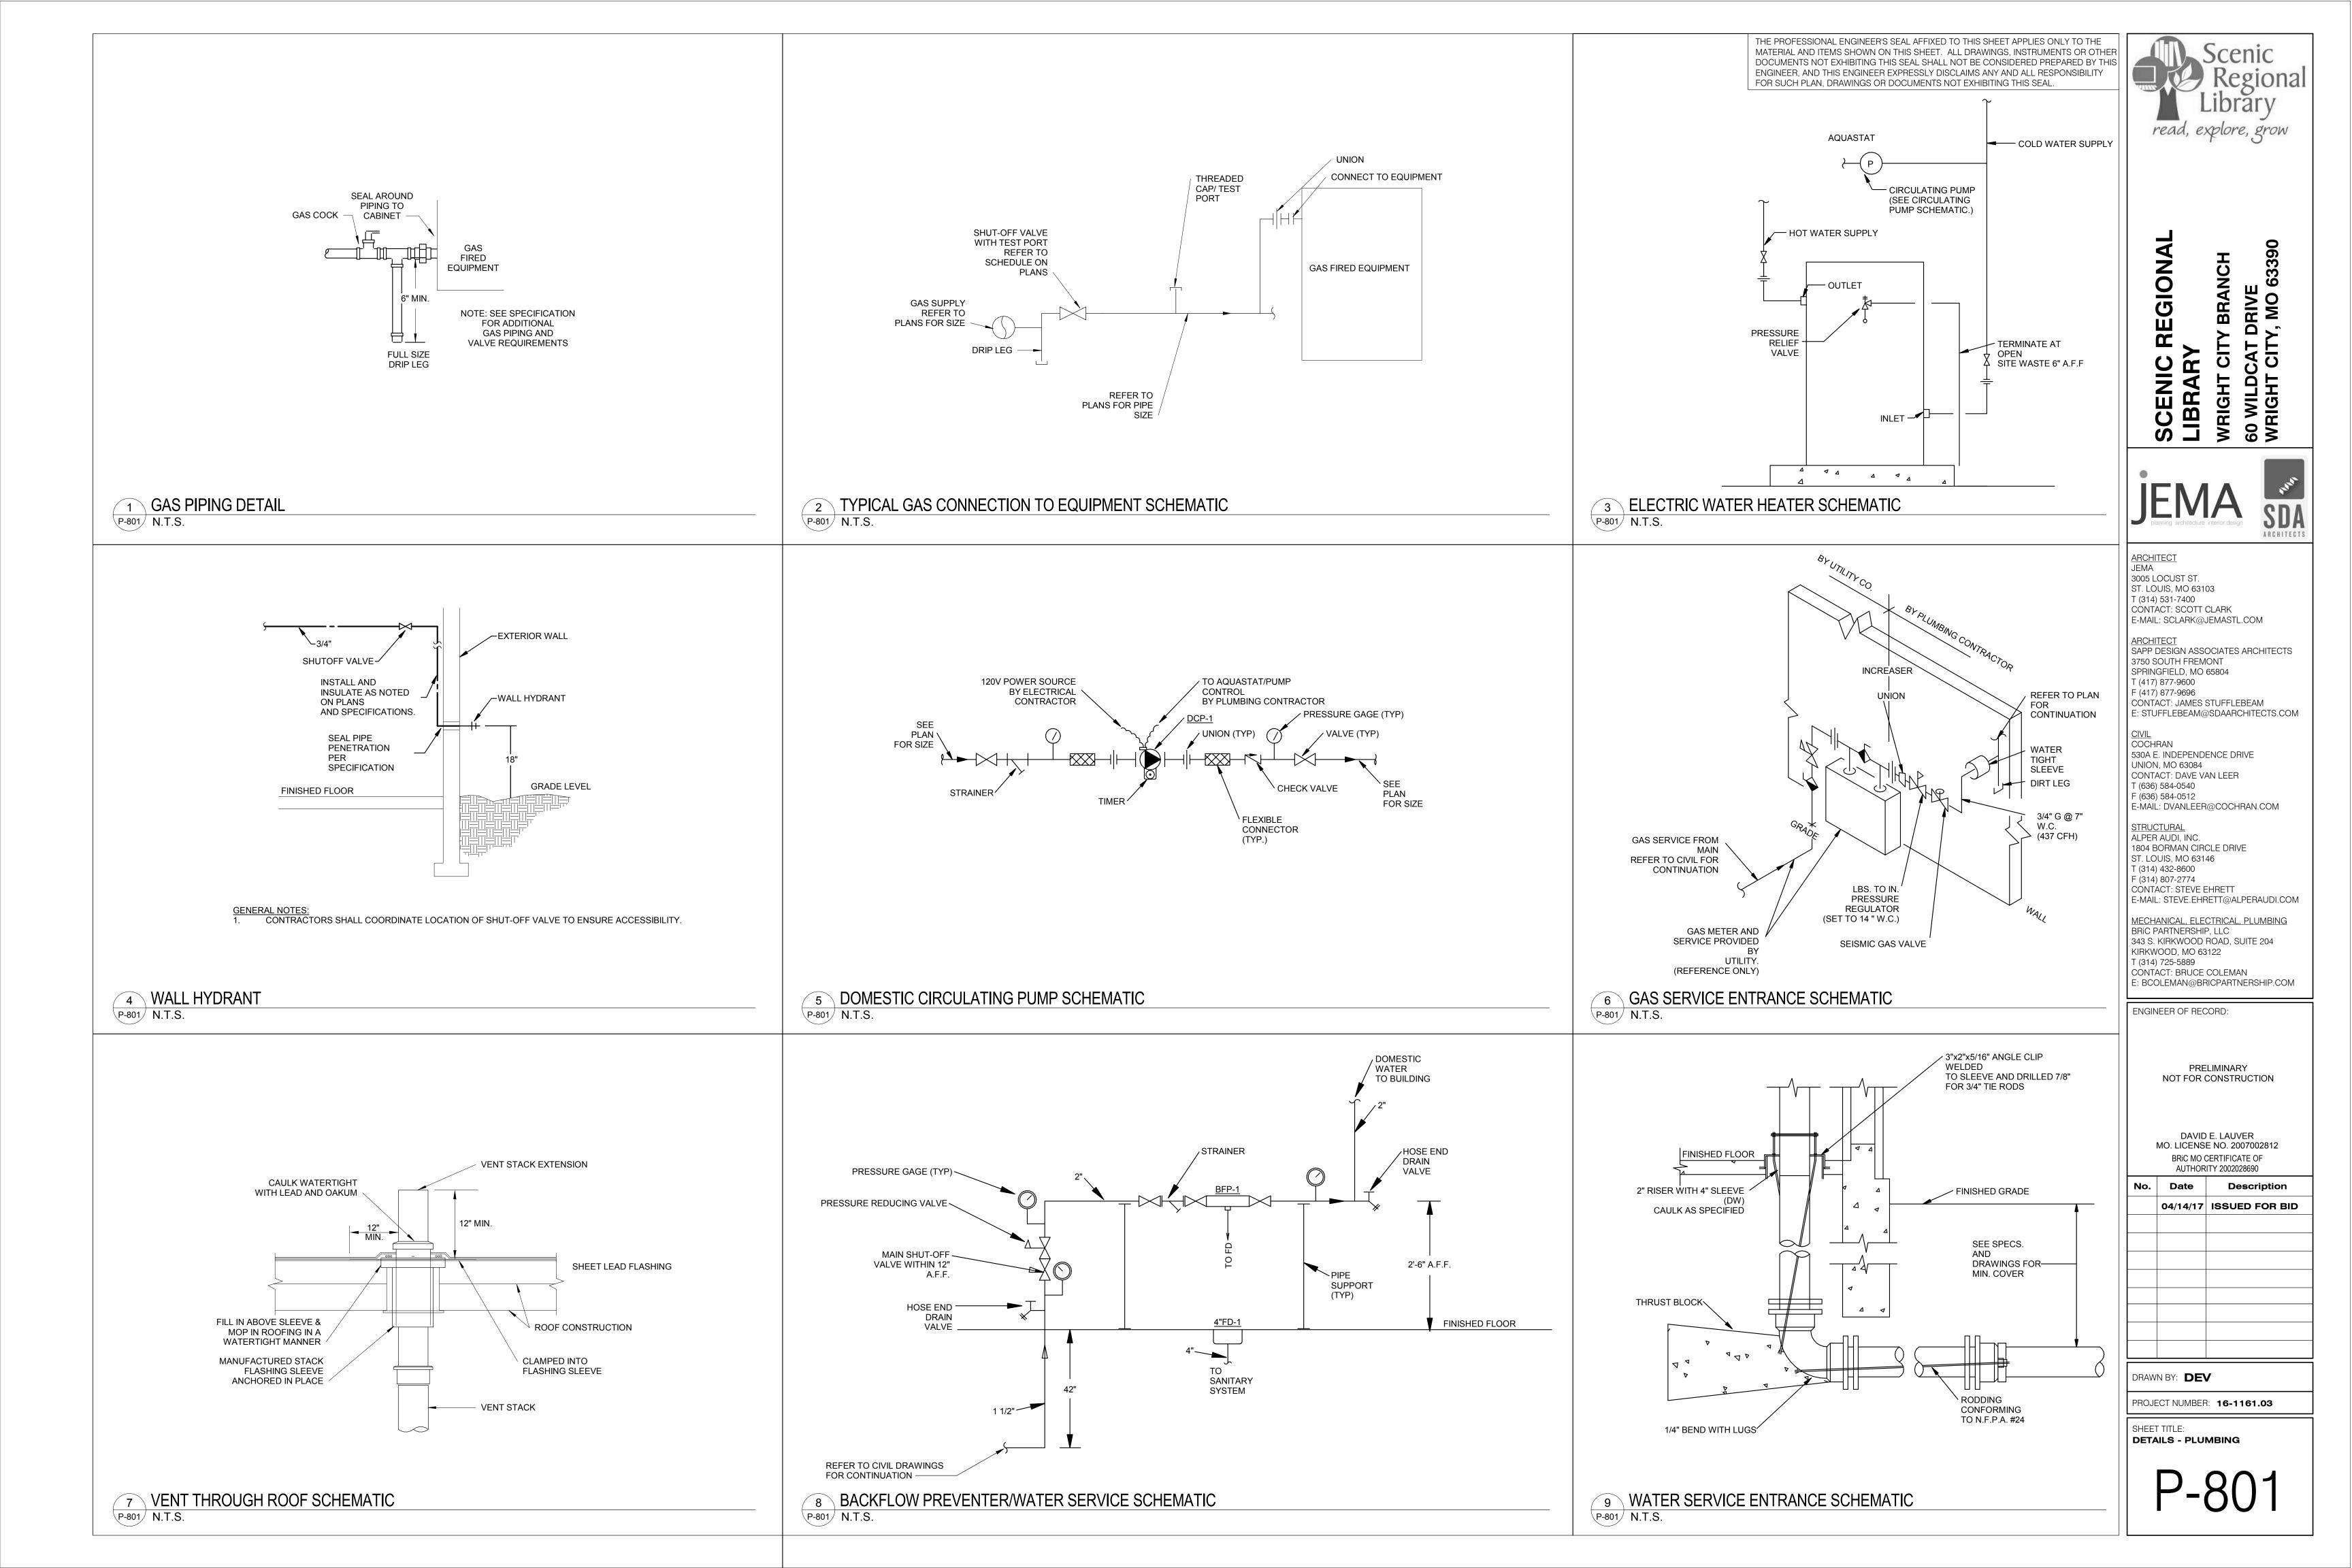
FLOOR PLAN - FIRST FLOOR -

PLUMBING

ROOM SCHEDULE

Number	Name
00	CIRCULATION
00	VESTIBULE
)1	CORRIDOR
)2	MENS
)3	WOMENS
)4	MEETING ROOM
)5	COATS
)6	STORAGE
)7	CHILDREN AREA
)8	CIRCULATION
9	ADULT AREA
0	TEEN AREA
1	WORK ROOM
2	OFFICE
3	STUDY
4	STUDY
5	CORRIDOR
6	STORAGE
7	JANITORS CLOSET
8	BREAK ROOM
9	MECH / ELEC

BOOK DROP



ELECTRICAL ABBREVIATIONS:

- A.F. AMP FUSE. USED IN CONJUNCTION WITH "A.S."
- A.F.F. ABOVE FINISHED FLOOR.
- A.S. AMP SWITCH USED IN CONJUNCTION WITH "A.F." OR "N.F."
- IN STATEMENT IS ABBREVIATION FOR "CONDUIT."
- CAFCI COMBINATION ARC FAULT CIRCUIT INTERRUPTER BREAKER.
- CKT CIRCUIT.
- INSTALL DEVICE EITHER AT OR 12" BELOW FINISHED CEILING.
- E.C. ELECTRICAL CONTRACTOR (DIVISION 16)
- E.M. EQUIPMENT MANUFACTURER.
- ETR EXISTING TO REMAIN.
- INDICATES DEVICE IS EXISTING.
- F.B.O. FURNISHED BY OTHERS
- FS FUSIBLE SWITCH.
- GARAGE DOOR INSTALLER.
- GROUND FAULT INTERRUPT PROTECTION.
- ISOLATED / INSOLATED GROUND DEVICE.
- LVC LOW VOLTAGE CONTRACTOR
- MECHANICAL CONTRACTOR (DIVISION 15). NOT FUSED / NON-FUSIBLE SWITCH.
- NOT IN CONTRACT.
- 6" OVER (ABOVE) COUNTER LEVEL.
- P.C. PLUMBING CONTRACTOR (DIVISION 15).
- TV TELEVISION
- U.N.O. UNLESS NOTED OTHERWISE.
- UCR UNDER COUNTER REFRIGERATOR.
- UPS UNINTERRUPTIBLE POWER SUPPLY.
- VARIABLE FREQUENCY DRIVE.
- WALL MOUNTED DEVICE (48" A.F.F.)
- WEATHERPROOF IN-USE COVER

ELECTRICAL INSTALLATION NOTES:

- THE COMPLETE INSTALLATION SHALL BE IN ACCORDANCE WITH THE ADAAG (AMERICANS WITH DISABILITIES ACT ACCESSIBILITY GUIDELINES).
- 2. CIRCUIT NUMBERS ARE SHOWN FOR CIRCUIT IDENTIFICATION. CIRCUITING SHALL AGREE WITH NUMBERING ON THE PANEL PROVIDED. COMMON NEUTRALS MAY BE USED FOR BRANCH CIRCUITS. BALANCE THE LOAD ON PANEL AS EVENLY AS POSSIBLE BETWEEN EACH PHASE.
- 3. CONCEAL ALL CONDUIT IN WALLS, PARTITIONS, ABOVE CEILING, AND IN FLOOR SLAB, ETC. UNLESS OTHERWISE INDICATED ON THE PLANS OR IN THE SPECIFICATIONS. CONDUIT IN MECHANICAL ROOMS, AND STORAGE ROOMS WITHOUT CEILINGS MAY BE EXPOSED ON BUILDING STRUCTURE.
- 4. BOXES LOCATED ON OPPOSITE SIDE OF NON-RATED WALLS SHALL BE OFFSET A MINIMUM OF 6" HORIZONTALLY. BOXES ON OPPOSITE SIDES OF FIRE RATED WALLS SHALL BE OFFSET A MINIMUM OF 24" HORIZONTALLY. "THRU-THE-WALL" BOXES SHALL NOT BE ALLOWED WITHOUT PRIOR WRITTEN APPROVAL OF THE ARCHITECT / ENGINEER.
- 5. CONTRACTOR SHALL COORDINATE THE LOCATION OF ALL DETECTORS AND . OR SPEAKERS WITH LUMINARIES, SPRINKLER, AND CEILING DIFFUSERS. CENTER ALL DEVICES IN CEILING TILE PATTERN. SMOKE DETECTORS SHALL BE LOCATED NO CLOSER THAN 3 FEET TO AN AIR SUPPLY DIFFUSER OR RETURN GRILLE.
- 6. CONTRACTOR SHALL VERIFY ALL FURNITURE, MODULAR FURNITURE, AND EQUIPMENT LOCATIONS WITH ARCHITECTURAL PLANS, ELEVATIONS AND REVIEW SHOP DRAWINGS. PRIOR TO MAKING THE ACTUAL ELECTRICAL INSTALLATION THIS CONTRACTOR SHALL ADJUST RECEPTACLES, OUTLETS, OR CONNECTION LOCATIONS TO ACCOMMODATE FURNITURE AND / OR EQUIPMENT.
- 7. WALL MOUNTED DEVICES (STROBES, PULL STATIONS, SPEAKERS, SENSORS. RECEPTACLES, LIGHT SWITCHES, ETC.) THAT ARE LOCATED WITHIN +/- 2' HORIZONTALLY OFF A LOWER DEVICE(S), ALL DEVICES SHALL BE ALIGNED VERTICALLY AND RACEWAYS ROUTED AS REQUIRED TO ALLOW THE DEVICES TO BE MOUNTED VERTICALLY.
- 8. ELECTRICAL EQUIPMENT SHALL BE MOUNTED TO AVOID THE IMPEDANCE OF OPERATION AND / OR ACCESS TO ELECTRICAL AND MECHANICAL EQUIPMENT. ALL MOUNTING OF ELECTRICAL GEAR ON EQUIPMENT SUPPLIED BY ANOTHER CONTRACTOR SHALL BE APPROVED IN ADVANCE BY THE OTHER CONTRACTOR.
- TELECOMMUNICATIONS EQUIPMENT SHALL BE MOUNTED TO ALLOW ACCESS TO ELECTRICAL AND MECHANICAL EQUIPMENT. ALL MOUNTING OF TELECOMMUNICATION DEVICES ON EQUIPMENT SUPPLIED BY ANOTHER CONTRACTOR SHALL BE APPROVED IN ADVANCE BY THE OTHER CONTRACTOR.
- 10. ALL FINAL ELECTRICAL CONNECTIONS TO MOTORS SHALL BE MADE WITH FLEXIBLE METAL CONDUIT. USE LIQUIDTIGHT CONDUIT AND FITTING WHERE SUBJECT TO MOISTURE. ROUTE GROUND WIRE FROM CIRCUIT GROUND TO MOTOR GROUND THROUGH FLEXIBLE CONDUIT. FLEXIBLE CONDUIT SHALL NOT EXCEED 6' IN LENGTH.
- 11. CONTRACTOR SHALL BE RESPONSIBLE FOR ALL OPENINGS REQUIRED IN WALLS. ALL OPENINGS SHALL BE REPAIRED TO MATCH EXISTING BY A QUALIFIED CONTRACTOR AT THE EXPENSE OF THIS CONTRACTOR. ALL CONDUITS THROUGH WALLS SHALL BE GROUTED OR SEALED INTO OPENINGS.
- 12. ALL MATERIALS USED TO SEAL PENETRATIONS OF FIRE RATED WALLS AND FLOOR SHALL BE TESTED AND CERTIFIED AS A SYSTEM PER ASTM E814 STANDARDS FOR FIRE TESTS OF THROUGH-PENETRATION FIRESTOP.
- 13. CONTRACTOR SHALL INSTALL AT EACH SERVICE ENTRANCE A PERMANENT DIRECTORY ACCORDING TO ARTICLE 230 OF THE NATIONAL ELECTRIC CODE.
- 14. CONTRACTOR SHALL REMOVE AND REINSTALL ALL CEILING TILES AS REQUIRED FOR THE EXECUTION OF ELECTRICAL WORK THAT IS OUTSIDE THE CONTRACT LIMITS OF CONSTRUCTION. CONTRACTOR SHALL REPLACE CEILING TILES WITH IDENTICAL MATERIAL WHERE DAMAGED BY THIS CONTRACTOR.
- 15. UNLESS OTHERWISE STATED, THE MINIMUM CIRCUIT SHALL BE (2) #12 AND (1) #12 GND IN 3/4" CONDUIT FOR IN DOORS OR IN 1" CONDUIT FOR EXTERIOR APPLICATIONS.

ELECTRICAL SYMBOLS:

ALL CIRCUITS SHALL BE (2) #12's WITH (1) #12 GND MINIMUM U.N.O.

- CEILING-MOUNTED JUNCTION BOX (4"x4"x1-1/2" MIN.)
- WALL-MOUNTED JUNCTION BOX (4"x4"x1-1/2" MIN.)

FB# INDICATES FLOOR BOX REQUIREMENTS

- FB1 FLOOR BOX
- (1) 5-20 DUPLEX RECEPTACLES.
- COMMUNICATIONS:
- (1) DATA OUTLETS (RJ-45). FB2 - FLOOR BOX
 - (2) 5-20 DUPLEX RECEPTACLES.
 - COMMUNICATIONS: (2) DATA OUTLETS (RJ-45).
- FB3 FLOOR BOX
- (2) 5-20 DUPLEX RECEPTACLES.
- FB4 FLOOR BOX
 - (1) 208V/2P BREAKER WITH 120V WHIP (3) #12, (1) #12 GND, 1" C WITH SHARED NEUTRAL.
 - **COMMUNICATIONS:** PROVIDE CAT6 DATA CONNECTION PER FLOOR PLAN.
- PANELBOARD LOCATION ON PLANS. "LNL1" INDICATES DESIGNATION.
- FEEDER SCHEDULE NOTE. "A" INDICATES FEEDER IN SCHEDULE.
- MECHANICAL EQUIPMENT DESIGNATION. "CU-1" INDICATES ITEM IN MECHANICAL EQUIPMENT DATA SCHEDULE. REFER TO MECHANICAL EQUIPMENT SCHEDULE FOR ADDITION REQUIREMENTS.
- CIRCUIT CONDUIT ROUTING. "I INDICATES ONE (1) GROUND CONDUCTOR, ONE (1) NEUTRAL CONDUCTOR AND TWO (2) PHASE CONDUCTORS RESPÉCTIVELY. ") "INDICATES ISOLATED GROUND CONDUCTOR. ALL CONDUCTORS SHALL BE #12 AWG MINIMUM U.N.O



CONDUIT ROUTED IN CEILING SPACE OF LEVEL BELOW

CONDUIT ROUTED EXPOSED AS SHOWN.

---- CONDUIT ROUTED UNDER SLAB.

CONDUIT TURNING UP.

— CONDUIT TURNING DOWN.

- GROUND CONNECTION OR LIGHTNING PROTECTION GROUND ROD LOCATION.
- MOTOR STARTING SWITCH. MOUNT AT 48" A.F.F. U.N.O. "M" INDICATES MOTOR. "P" INDICATES WITH PILOT LIGHT.
- MOTOR CONNECTION. "1" INDICATES HORSEPOWER.
- POWER POKE-THRU DEVICE. PROVIDE ADAPTER PLATE FOR FLEXIBLE CONDUIT CONNECTION.
- 1. 90A ELECTRICAL DISCONNECT. SUBTEXT DENOTES DISC. AMP RATING AND $^{
 m J}$ 3-POLE NUMBER OF CONDUCTORS.
- PUSHBUTTON

COMMUNICATION SYMBOLS:

- COMMUNICATION ROUGH-IN ONLY WALL BOX. PROVIDE MINIMUM 4" x 4" x 2-1/8" DEEP BOX MOUNTED 18" ABOVE FLOOR. UNLESS NOTED OTHERWISE PROVIDE SINGLE GANG MUD RING AND 3/4" CONDUIT WITH BUSHING ROUTED INTO AN ACCESSIBLE CEILING SPACE. PROVIDE PULL STRING AND BLANK FACEPLATE.
- COMMUNICATION OUTLET IN RECESSED WALL BOX. PROVIDE MINIMUM 4" x 4" x 2-1/8" DEEP BOX MOUNTED 18" ABOVE FLOOR. UNLESS NOTED OTHERWISE PROVIDE SINGLE GANG MUD RING AND 3/4" CONDUIT WITH BUSHING ROUTED INTO AN ACCESSIBLE CEILING SPACE. PROVIDE CABLING AND JACKS AS DENOTED (SEE BELOW), "#A" (TYPICAL) INDICATES CABLING AND CONNECTIVITY REQUIREMENTS.

CABLING REQUIREMENTS

- "#A" TELEPHONE CABLE (CAT 5e)
- "WA" WALL PHONE, MOUNT 48" A.F.F. FACEPLATE SHALL HAVE BASE UNIT MOUNTING STUDS
- "#D" DATA CABLE (CAT 6).
- "WAP" WIRELESS ACCESS POINT. PROVIDE CAT6 WITH MALE

NOTE: NUMBER (#) BEFORE CABLE TYPE INDICATES QUANTITY

- TV CONNECTION. PROVIDE WIREMOLD EVOLUTION WALL BOXES. BOX SHALL HAVE POWER AND DATA ON TOP WITH SPACE ON BOTTOM. PROVIDE 1" C. FOR DATA AND 3/4" C. FOR POWER. PROVIDE CAT6 FROM SERVER TO BOX AND PROVIDE TERMINATION TO CABLE.
- **VOLUME CONTROLLER FOR SPEAKERS**

RECEPTACLE SYMBOLS:

TYPE DESIGNATION:

"SW"- NEMA 5-20R GROUND TYPE DUPLEX RECEPTACLE CIRCUIT THROUGH LOCAL OCCUPANCY SENSOR CONTACTOR LOCATED ABOVE CEILING. REFER TO LIGHTING PLAN FOR LOCATION OF CONTACTOR.

"TVSS"-NEMA 5-20R SURGE SUPPRESSION TYPE DUPLEX RECEPTACLE.

"MW"- MICROWAVE RECEPTACLE.

"TV"- TV RECEPTACLE. MOUNT ADJACENT TO TV OUTLET. REFER TO COMMUNICATIONS FLOOR PLANS FOR TV OUTLET

"EWC"- ELECTRIC WATER COOLER RECEPTACLE: CONCEALED BEHIND WATER COOLER ACCESS PLATE OR DIRECTLY BELOW AND CENTER ON EWC. CONTRACTOR SHALL VERIFY TYPE OF EWC TO BE INSTALLED.

"H"- MOUNT OUTLET HORIZONTALLY.

"G"- INDICATES A 5-20 RECEPTACLE (NON-GFCI) PROTECTED BY GFCI PROTECT CIRCUIT BREAKER. PROVIDE PERMANENT

"A"- INDICATES A 5-20 RECEPTACLE (NON-AFCI) PROTECTED BY AFCI PROTECT CIRCUIT BREAKER. PROVIDE PERMANENT


- NEMA 5-20R GROUND TYPE DUPLEX RECEPTACLE. SUBSCRIPT INDICATES TYPE. MOUNT AT 18" A.F.F. UNLESS NOTED OTHERWISE.
- NEMA 5-20R G.F.I. DUPLEX RECEPTACLE. MOUNT 18" A.F.F. UNLESS
- NEMA 5-20R DOUBLE DUPLEX RECEPTACLE. SUBSCRIPT INDICATES TYPE. MOUNT 18" A.F.F. UNLESS NOTED OTHERWISE.
- NEMA 5-20R G.F.I. DOUBLE DUPLEX RECEPTACLE. MOUNT 18" A.F.F. UNLESS NOTED OTHERWISE.
- NEMA 5-20R GROUND TYPE SIMPLEX RECEPTACLE. SUBSCRIPT INDICATES TYPE. MOUNT AT 18" A.F.F. U.N.O.
- SPECIAL PURPOSE RECEPTACLE AS INDICATED ON DRAWINGS SUBSCRIPT INDICATES TYPE. MOUNT AT 18" A.F.F. U.N.O.
- CORD REEL RECEPTACLE. REFER TO DETAIL ON FLOOR PLAN.

LIGHTING SYMBOLS:

- " | " INDICATES FOR DEVICE TO BE WALL-MOUNTED
- ALL CIRCUITS SHALL BE (2) #12's WITH (1) #12 GND MINIMUM U.N.O.

DOWNLIGHT. B-LLC

- 23,a,b,c SYMBOL NOMENCLATURE:
 - "B"- INDICATES FIXTURE TYPE.
 - "23"- NUMBER DESIGNATES FIXTURE CIRCUIT. "LLC"- FIXTURE CONTROLLED BY LIGHTING CONTROL SYSTEM REFER TO LIGHTING CONTROL DIAGRAM FOR DEVICES AND
 - "a,b,c"- FIXTURE CONTROLLED BY LOCAL SWITCH REFER TO LIGHTING CONTROL SYMBOL FOR CONTROL METHOD
 - TYPICAL OF ALL LIGHT FIXTURES. SEE LIGHT FIXTURE SCHEDULE FOR MORE INFORMATION.
- () WALL MOUNTED DOWNLIGHT.
 - LIGHT FIXTURE. SIZE AS INDICATED.

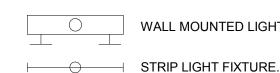

WALL MOUNTED LIGHT FIXTURE.

EMERGENCY STRIP LIGHT FIXTURE.

EMERGENCY DOWNLIGHT

- CEILING MOUNTED EMERGENCY LIGHT FIXTURE.
- EXIT LIGHT FIXTURE. PROVIDE WITH ARROWS AS INDICATED. DECORATIVE POST TOP SITE LIGHTING FIXTURE.
- POLE MOUNTED SITE LIGHTING FIXTURE.
- CEILING FAN REFER TO LIGHT FIXTURE SCHEDULE FOR TYPE.


THE PROFESSIONAL ENGINEER'S SEAL AFFIXED TO THIS SHEET APPLIES ONLY TO THE MATERIAL AND ITEMS SHOWN ON THIS SHEET. ALL DRAWINGS, INSTRUMENTS OR OTHER DOCUMENTS NOT EXHIBITING THIS SEAL SHALL NOT BE CONSIDERED PREPARED BY THIS ENGINEER, AND THIS ENGINEER EXPRESSLY DISCLAIMS ANY AND ALL RESPONSIBILITY FOR SUCH PLAN, DRAWINGS OR DOCUMENTS NOT EXHIBITING THIS SEAL.

OTHER:

KNOCK BOX, PROVIDED BY OTHERS. PROVIDE MONITOR MODULE AS



DETAIL REFERENCE. "4" INDICATES DETAIL # "E301" INDICATES SHEET. REFER TO DETAIL FOR ADDITIONAL REQUIREMENTS.

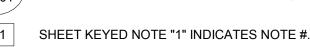

LIGHTING CONTROL SYMBOLS:

WALL SWITCH. MOUNT AT 48" A.F.F. U.N.O. UPPER CASE SUBSCRIPT INDICATES TYPE LOWER CASE SUBSCRIPT INDICATES SWITCH LEG. SUBSCRIPTS 3, 4 INDICATE THREE WAY AND FOUR WAY RESPECTIVELY.

TYPE DESIGNATION

"DM"- DIMMER CONTROL

- "LV"- INDICATES 0-10V AND TO PROVIDE POWER PACK FOR SWITCH AND OCCUPANCY SENSOR.
- "NL"- NIGHT LIGHT FIXTURE CIRCUIT TO PANELBOARD "MAIN" WITH NO LOCAL CONTROL.

"110i" NUMBER INDICATE ROOM NUMBER. LETTER INDICATES

"OS"- DUAL (PIR AND ULTRASONIC) OCCUPANCY SENSOR

SWITCH NUMBER IN THE ROOM.

- PHOTO CELL DEVICE
- CONTACTOR
- LIGHTING CONTROL POWER STATION. MOUNT ON 4" x 4" BOX ABOVE
- LCP LIGHTING CONTROL PANEL. INCLUDES SYSTEM CONTROLLER. CONTAINS RELAYS.
- LLC LOCAL LIGHTING CONTROLLER. REFER TO DETAIL 1/E8.0.0
- NETWORK INTERFACE
- OCCUPANCY SENSOR, CEILING MOUNTED. WIDE ANGLE LENS. MOUNT AT 96" A.F.F. SUBSCRIPT DENOTES SENSOR TYPE.

"IR"- PASSIVE INFRARED TECHNOLOGY.

REFER TO POWER PLANS FOR RECEPTACLE LOCATIONS.

OCCUPANCY SENSOR RELAY PACK 20A CONTACTOR MOUNTED ON J-

"DT"- DUAL (PIR + ULTRASONIC) TECHNOLOGY.

BOX ABOVE ACCESSIBLE CEILING FOR SWITCHING LOCAL RECEPTACLE. STRUCTURAL ALPER AUDI, INC.



read, explore, grow



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TODD L. KUNO MO. LICENSE NO. 2015017018 BRIC MO CERTIFICATE OF

Date

AUTHORITY 2002028690

04/14/17 ISSUED FOR BID

Description

DRAWN BY: **TLK**

PROJECT NUMBER: **16-1161.03**

LEGEND, SYMBOLS, NOTES, & **ABBREVIATIONS - ELECTRICAL**

KEYED NOTES

UNDERGROUND DUCTS FOR COMMUNICATIONS SERVICES. TWO (2) 2" PVC. SEE SHEET E-401

ELECTRICAL CONTRACTOR SHALL PROVIDE 1" CONDUIT FROM BUILDING ELECTRICAL ROOM TO THE LOCATION INDICATED. PROVIDE PULL STRING, CAP AND LABEL CONDUIT ON EACH END. CONTRACTOR SHALL PROVIDE EXACT LOCATION OF END OF CONDUIT ON AS BUILDS.

PROVIDE 20' RTS POLE, AND POLE BASE. SEE DETAIL ON THIS SHEET FOR GROUNDING,

FOR CONTINUATION INTO BUILDING. COORDINATE WITH SERVICE PROVIDERS AND ROUTE TO

PROVIDE (2) #10, (1) #10 GND, IN 1" CONDUIT POWER TO SITE LIGHTING FIXTURES.

PROVIDE UTILITY TRANSFORMER CONCRETE PAD PER UTILITY REQUIREMENTS.

PROVIDE 4" CONDUIT TO UTILITY SERVICE. SEE CIVIL PLAN FOR ROUTE.

POLE OF MANHOLE AS REQUIRED.

WIRING, AND BASE DETAILS.



GION

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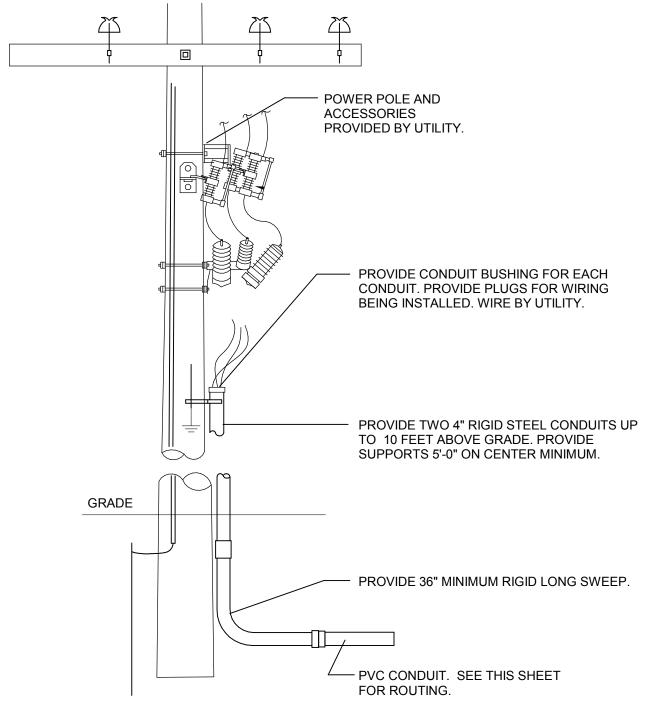
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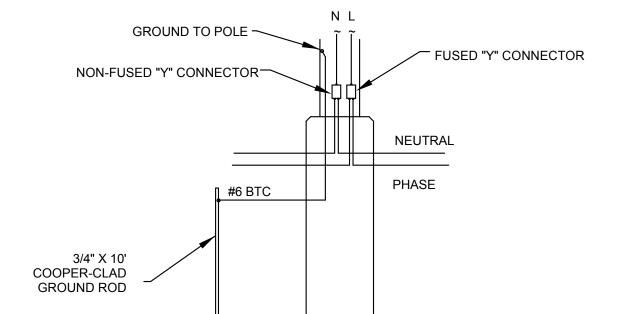
PROJECT NUMBER: 16-1161.03

SITE PLAN - ELECTRICAL

GENERAL NOTES

- 1 ELECTRICAL CONTRACTOR SHALL CORRIDNATE SITE LIGHTING FIXTURES PRIOR TO INSTALLING BASE WITH CIVIL CONTRACTOR.
- 2 FLAG POLE FLOOD LIGHTS (S3 FIXTURE) SHALL BE EVENLY SPACED AROUND THE FLAG POLE APPROXIMALY 4' AWAY FROM THE FLAG POLE.





- GROUND POLE AND NEUTRAL TO GROUND ROD USING CONDUCTOR INDICATED.
- 3 SITE LIGHTING POLE WIRING DETAIL E-100 N.T.S.

NOTES: FUSED "Y" CONNECTOR TO BE FUSED AT 10 AMPS AND RATED FOR 600 VOLTS.

ALL WIRING SHALL BE #10 U.N.O. MECHANICALLY HELD LIGHTING CONTACTOR 4 SITE LIGHTING CONTACTOR E-100 N.T.S.



S2, 24 4

- NON-SHRINK GROUT WITH WIRE MESH

ANCHOR BOLTS PER

RECOMMENDATIONS (4

MANUFACTURERS

SIX NO. 5 BARS

NO. 4 SPIRAL WITH

3 LOOPS MINIMUM TOP AND BOTTOM. LOOPS SPACED 2"

EQUALLY

SPACED

TO NEXT POLE

1" MIN

ALL CONCRETE ABOVE GRADE SHALL BE HAND RUBBED

CONCRETE POLE BASE BY E.C. CONCRETE TO HAVE 3500

PSI MIN COMPRESSIVE STRENGTH AT 28 DAYS AND USE

ASTM A615 GRADE 60 REINFORCING STEEL.

2 SITE LIGTHTING POLE BASE DETAIL

1 SITE PLAN - ELECTRICAL

7'-0"

SEE PLAN

1" CHAMFER

NOTES:


E-100 N.T.S.


FROM LAST

POLE 1" MIN

TO A SMOOTH FINISH.

E-100 1" = 20'-0"

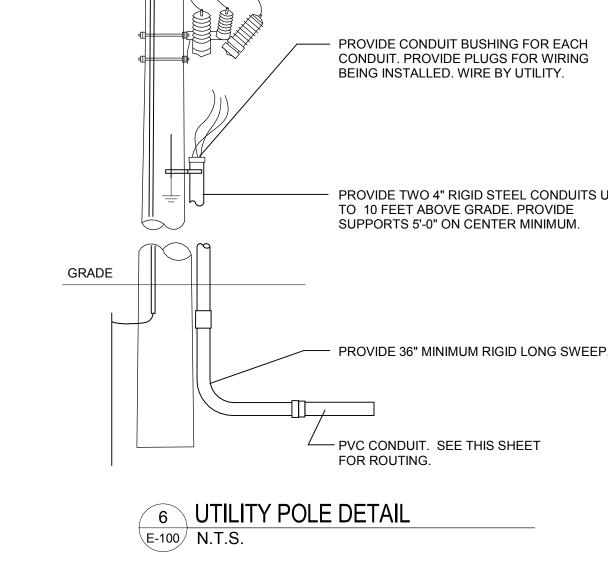

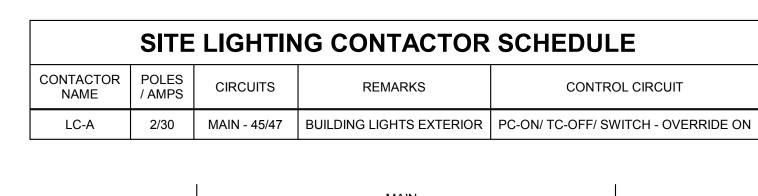

5 TRENCHING DETAIL

FINISHED GRADE ----

90% COMPACTED BACKFILL -


PROVIDE RED WARNING


TAPE 18" BELOW GRADE

E-100 N.T.S.

SAND FILL

PLAN FOR SIZE.

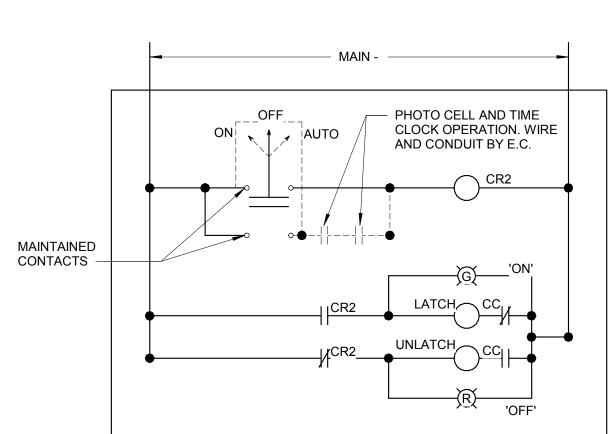

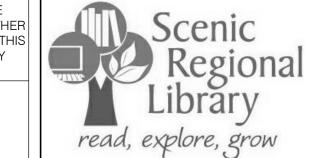

REGION SCENIC LIBRAR WRIGHT

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No.	Date	Description
	04/14/17	ISSUED FOR BID

DRAW	N BY: TLK	
PROJE	ECT NUMBER	R: 16
SHEET	Γ TITLE:	

ROOM SCHEDULE

CIRCULATION VESTIBULE CORRIDOR MENS WOMENS

MEETING ROOM

TEEN AREA WORK ROOM OFFICE

COATS STORAGE CHILDREN AREA CIRCULATION ADULT AREA

STUDY

STUDY

CORRIDOR STORAGE

JANITORS CLOSET BREAK ROOM MECH / ELEC BOOK DROP

Name

Number

6-1161.03

FLOOR PLAN & LIGHT FIXTURE SCHEDULE - FIRST FLOOR -**ELECTRICAL LIGHTING**

GENERAL NOTES

- ALL LIGHTING SHALL BE CONTROLLED BY A TIME CLOCK UNLESS NOTED TO BE CONTROLLED BY AN OCCUPANCY SENSOR. REFER TO LEGEND SHEET FOR TIME CLOCK DETAILS. A TIME CLOCK OVERRIDE SWITCH SHALL BE PROVIDED IN THE WORK ROOM 108.
- 2 ALL LIGHTING IN STORAGE, OFFICES, STUDIES, MECHANICAL/ELECTRICAL, MEETING ROOM AND BATHROOMS ARE CONTROLLED BY OCCUPANCY OR MOTION SENSORS.
- EGRESS LIGHTING WILL HAVE DEDICATED POWER. WHEN NO POWER IS DETECTED. EGRESS LIGHTING
- 4 ELECTRICAL CONTRACTOR SHALL REFER TO ARCHITECTS CEILING PLAN FOR FINAL LOCATION OF CEILING FIXTURES.

KEYED NOTES

WILL TURN ON.


SITE/BUILDING LIGHTING PHOTO

CELL

410

418

- 1 ALL SITE AND BUILDING LIGHTING WILL BE CONTROLLED BY A PHOTO CELL LOCATED ON THE EXTERIOR EAST AND WEST WALLS OF THE BUILDING. PROVIDE WIRE AND CONDUIT TO THE PHOTO CELL IN SHOWN LOCATION.
- 2 PROVIDE STRIP LED LIGHT FIXTURES IN DISPLAY CASE. SEE DETAIL ON THIS SHEET FOR DISPLAY CASE LIGHTING. PROVIDE LED DRIVER ABOVE THE CEILING OR AS HIGH AS POSSIBLE. DISPLAY CASE LIGHTS SHALL BE CONTROLLED BY A DIMMING CONTROLLER AND LOW VOLTAGE DIMMING SWITCH LOCATED ABOVE THE DESK. LABEL SWITCH AS CASE LIGHTS.
- EXHAUST FAN IN THE RESTROOM SHALL BE CONTROLLED BY THE LIGHTING CONTROL IN THE SPACE. PROVIDE UNDER CABINET LIGHTING. PROVIDE LINE VOLTAGE SWITCH TO CONTROL THE LIGHT FIXTURE. UNDER CABINET LIGHT FIXTURE DRIVER SHALL BE LOCATED IN THE BACK CORNER UNDER THE CABINET.

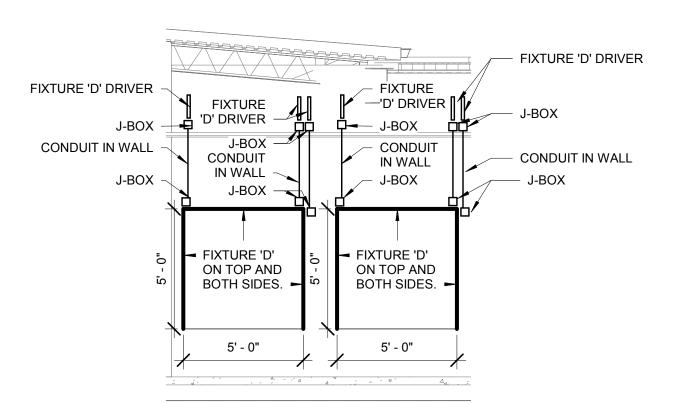

² CASE DETAIL EL-201 1/4" = 1'-0"

				LIGI	HT FIXTURE SCHEE	DULE
MARK	MANUFACTURER 1	Model	Voltage	LAMPS	MOUNTING	DESCRIPTION
Α	FREELUX	TUN7	120V	7W PER 20", 75 LM/W, 80 CRI, 3500K, UNDER CABINET	SURFACE MOUNT	UNDER CABINET FIXTURE. PROVIDE DRIVER AND CABLE AS REQUIRED.
В	OCL	LO1	120V	48", 145W, 13050 LUMENS, LED, 3500K LIGHT TEMP	PENDENT / CEILING MOUNTED	PENDANT WITH 3 ANDGLED AIRCRAFT CABLES AND WHITE POWER CORD TO CANOPY, MATTE WHITE POLYETHYLENE FINISH, WITH 0-10V DIMMING DRIVER.
B1	OCL	LO1	120V	72", 145W, 13050 LUMENS, LED, 3500K LIGHT TEMP	PENDENT / CEILING MOUNTED	PENDANT WITH 3 ANDGLED AIRCRAFT CABLES AND WHITE POWER CORD TO CANOPY, MATTE WHITE POLYETHYLENE FINISH, WITH 0-10V DIMMING DRIVER.
С	IKEA	FILLSTA	120V	7", 11W, 600 LUMENS, LED, 3500K LIGHT TEMP	PENDENT / CEILING MOUNTED	14" DIAMETER
D	LED LINEAR	XOOLUM	120V	10 W/M, 131 LM/W, 80 CRI, 3500K WALL WASH	SURFACE MOUNT	SILVER - ADJUSTABLE MOUNT CABLE OUT THE BACK, PROVIDE DIMMABLE DRIVER. DRIVER SHALL BE LOCATED ABOVE THE CEILING.
E1	METALUX	22CZ	120V	2x2, 34.4W, 3400 LUMENS, LED, 3500K LIGHT TEMP	RECESSED LAY-IN CEILING	UNIVERSAL 120V WITH 0-10V DIMMING DRIVER.
Н	METALUX	SNLED	120V	4', 25.07W, 3061 LUMENS, LED, 3500K LIGHT TEMP	CEILING SURFACE MOUNT	COMMERCIAL STRIPLIGHT, LED 4.0, CLEAR LENS, UNIVERSAL 120V WITH 0-10V DIMMING DRIVER.
J	HALO	PD6	120V	6", 17.1W, 1500 LUMENS, 80 CRI, LED, 3500K LIGHT TEMP	RECESSED CEILING MOUNT	DOWNLIGHT, SEMI-SPECULAR CLEAR, UNIVERSAL 120V WITH 0-10V DIMMING DRIVER.
JE	HALO	PD6	120V	6", 17.1W, 1500 LUMENS, 80 CRI, LED, 3500K LIGHT TEMP	RECESSED CEILING MOUNT	DOWNLIGHT, SEMI-SPECULAR CLEAR, UNIVERSAL 120V WITH 0-10V DIMMING DRIVER. WITH REMOTE EMERGENCY BACK UP BATTERY.
K	TECH LIGHTING	ELEMENT	120V	4" ROUND, FLANGE, BEVEL, 1500 LUMENS 80CRI, 3500K, 40 DEG	RECESSED CEILING MOUNT	DOWNLIGHT, SEMI-SPECULAR CLEAR, UNIVERSAL 120V WITH 0-10V DIMMING DRIVER.
M	SURE-LITES	SEL50 LED	120V	BUG EYE, LED	CEILING SURFACE MOUNT	DEDICATED BUG LIGHTING, WHITE FINISH, UNIVERSAL 120V, WITH BACKUP BATTERY
S1	COOPER LIGHTING	GALLEON	120V	9500 LUM, 4000K, 85W, T2	20' POLE RTS	PROVIDE 20' RTS POLE, SEE DETAIL ON E-100. BLACK FINISH.
S2	COOPER LIGHTING	GALLEON	120V	9500 LUM, 4000K, 85W, T3	20' POLE RTS	PROVIDE 20' RTS POLE, SEE DETAIL ON E-100. BLACK FINISH.
S3	COOPER LIGHTING	NFFLD-S	120V	2700 LUM, 5000K, 3H X 3V	GRADE MOUNT	GROUND MOUNT, PROVIDE 12" DIAMETER CONCRETE SUPPORTS.
W	COOPER LIGHTING	IST	120V	5000 LUM, 4000K, 45W, BL3	WALL MOUNTED	TRAPEZOID, BLACK FINISH, PROVIDE WEATHER SEAL AROUND BACK BOX.
WE	COOPER LIGHTING	IST	120V	5000 LUM, 4000K, 45W, BL3	WALL MOUNTED	TRAPEZOID, BLACK FINISH, PROVIDE WEATHER SEAL AROUND BACK BOX. PROVIDE WITH COLD WEATHER BATTERY PACK.
X	COOPER	LPX SERIES	120V	3.8W, LED, RED	WALL MOUNTED	LED EDGE LIT EXIT SIGN. PROVIDE SINGLE FACE, AND CHEVRONS INDICATED ON DRAWINGS.
X1	COOPER	LPX SERIES	120V	3.8W, LED, RED	WALL MOUNTED	LED EDGE LIT EXIT SIGN. PROVIDE SINGLE FACE, AND CHEVRONS INDICATED ON DRAWINGS.
X2C	COOPER	ES SERIES	120V	3.8W, LED, RED	CEILING MOUNTED	LED EDGE LIT EXIT SIGN. PROVIDE SINGLE FACE, AND CHEVRONS INDICATED ON DRAWINGS.

C, C 18, m C, C

E1, 0 15, h

E1, 0 16, g

E1, O 15, h

412

E1, 0 15, h

E1, O E1, O 21, e 21, e

E1, 0 15, h

E1, 0 15, h

417

23 E1,

16, g

√22 <u>_</u>

13, n

14, g

E1, 18, s/

X2C, 400

E1, O 13, h

E1, O 14, g

E1, 0 13, h

E1, 0 13, h

14, g

ON ROOF

(G.8)

13, o

E1, 0 13, o

E1, 0 19, b

19, b

19, b

E1, O 19, b

19, c

1 FLOOR PLAN - FIRST FLOOR - ELECTRICAL LIGHTING

404

19, a

19, a

EL-201 1/8" = 1'-0"


E1, 0 14, o

E1, 6 13, h

E1, 0 14, g

14, g

E1, 0 13, h

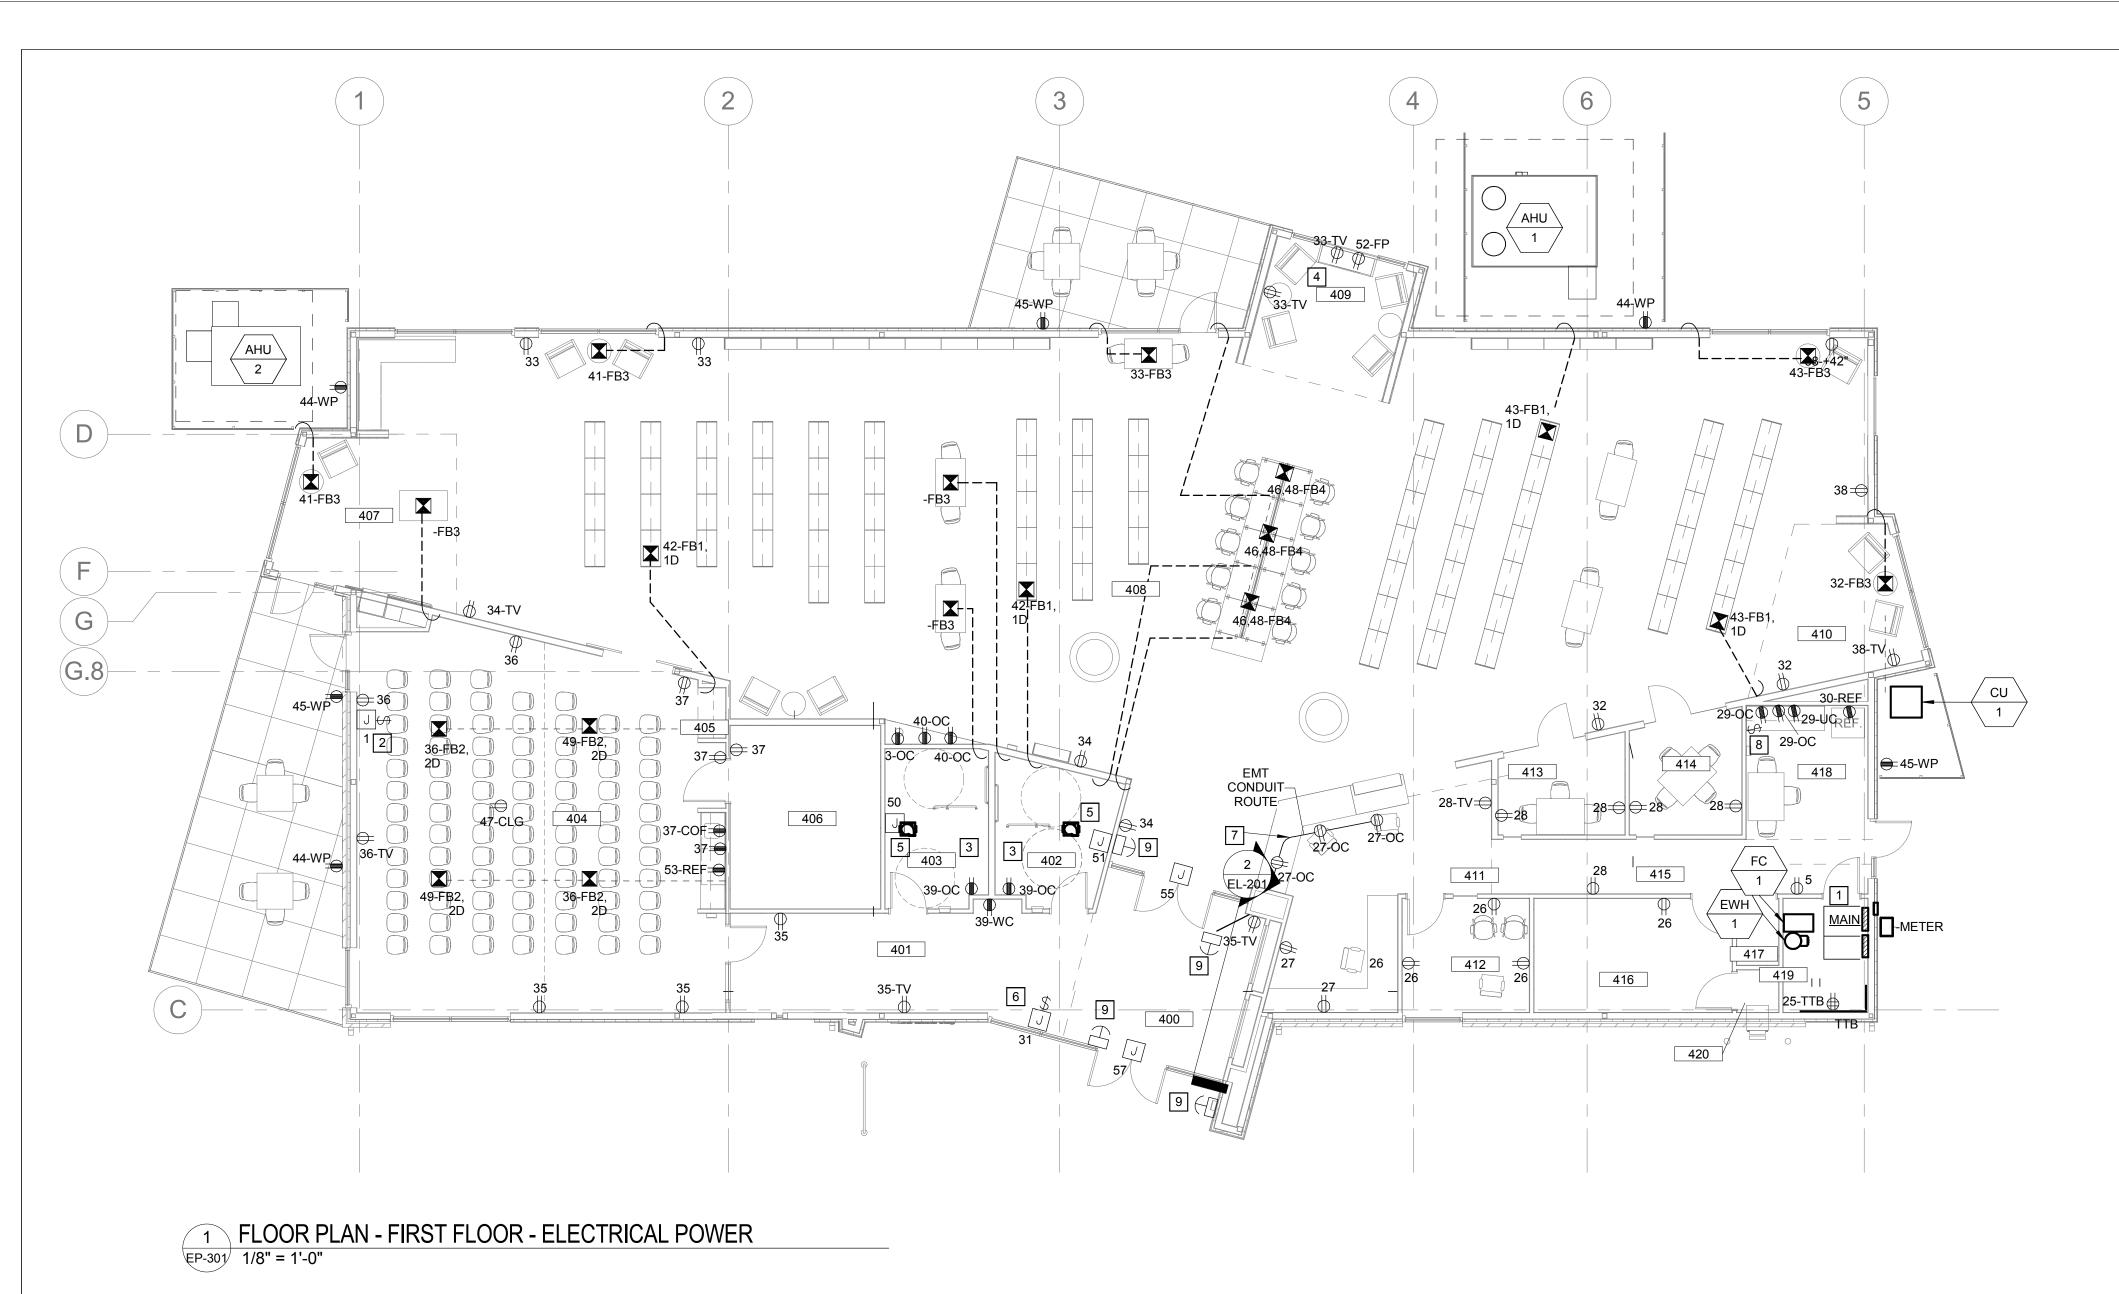

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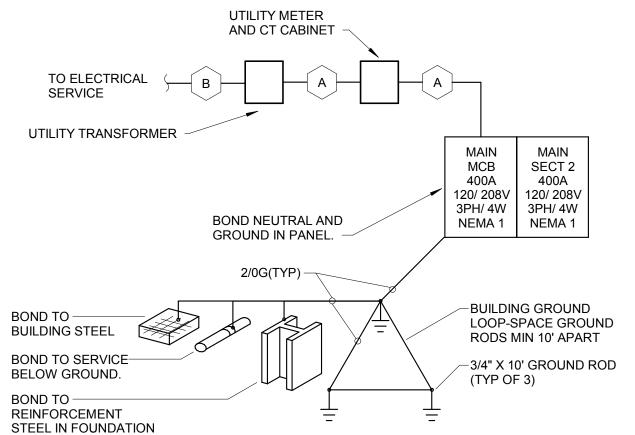
GENERAL NOTES

FOR ALL FLOOR BOXES, PROVIDE POWER, DATA, AND CONDUIT TO EACH ACCORDINGLY. REFER TO SHEET E-001 FOR DEFINITIONS OF DIFFERENT FLOOR BOXES. CONDUIT TO BE RAN BACK TO NEAREST WALL, AS SHOWN ON DRAWINGS, UP THROUGH WALL AND BACK TO MAIN PANEL IN ELECTRICAL ROOM 115.

KEYED NOTES

- 1 PROVIDE RECEPTACLE ON TOP OF RACK.
- 2 PROVIDE CONNECTION TO PROJECTOR SCREEN MOTOR. PROVIDE 3/4" CONDUIT FROM THE MOTOR CONTROLLER TO THE PROJECTOR SCREEN SWITCH. PROVIDE 2 GANG BACK BOX WITH SINGLE GANG MUD RING FOR THE PROJECTOR SCREEN SWITCH. COORDINATE LOCATION WITH PROJECTOR SCREEN.
- PROVIDE 1-1/4" PVC CONDUIT FROM FLOOR BOX TO WALL AS SHOWN. CONDUIT SHALL RISE UP WALL AND STUB OUT INTO CEILING SPACE. ROUTE COMMUNICATIONS CABLING FROM BOX TO CEILING SPACE AND CONTINUE TO I.T. ROOM #115 SUPPORTED BY J-HOOKS.
- PROVIDE 1-1/4" PVC CONDUIT FROM FLOOR BOX TO WALL AS SHOWN. CONDUIT SHALL RISE UP WALL AND STUB OUT INTO CEILING SPACE. ROUTE COMMUNICATIONS CABLING FROM BOX TO CEILING SPACE AND CONTINUE TO I.T. ROOM #115 SUPPORTED BY J-HOOKS.
- 5 PROVIDE BACK BOX FOR HAND DRYER. PROVIDE FINAL CONNECTION TO HAND DRYER. COORDINATE LOCATION WITH G.C.
- 6 PROVIDE CONNECTION TO ADA DOOR OPENER. PROVIDE A 20AMP TOGGLE DISCONNECT SWITCH, ABOVE THE CEILING, FOR ADA OPERATOR.
- 7 PROVIDE EMT CONDUIT TO OVER COUNTER RECEPTACLES IN WORK ROOM 411 AS SHOWN ON DRAWINGS. CONDUIT SHALL BE RAN UNDER COUNTER AND UP THROUGH DESK. PROVIDE (2)
- #12, (1) #12 GND, IN ¾" CONDUIT.

 8 PROVIDE SWITCH FOR GARBAGE DISPOSAL.
- 9 CONTRACTOR SHALL PROVIDE J-BOX ABOVE CEILING WITH A TOGGLE SWITCH. THE TOGGLE SWITCH SHALL BE USED AS A DISCONNECT SWITCH FOR THE ADA DOOR OPEN. PROVIDE 3/4" CONDUIT WITH PULL STRING FROM THE ADA DOOR CONTROLLER TO ADA PUSH BUTTON. PROVIDE BACK BOX AT PUSH BUTTON FOR ADA INSTALLER.



² ELECTRICAL ONE-LINE

EP-301 N.T.S.

FEEDER SCHEDULE									
PLAN MARK	NUMBER OF SETS	NUMBER OF HOT	HOT SIZE	NUMBER OF NEUTRAL	NEUTRAL SIZE	NUMBER OF GROUND	GROUND SIZE	CONDUIT SIZE	NOTES
Α	1	3	600KCMIL	1	600KCMIL	-	-	4"	
В	1	-	-	-	-	ı	-	4"	



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PRELIMINARY NOT FOR CONSTRUCTION

TODD L. KUNO MO. LICENSE NO. 2015017018 BRIC MO CERTIFICATE OF

AUTHORITY 2002028690

Date Description

04/14/17 ISSUED FOR BID

DRAWN BY: **TLK**

PROJECT NUMBER: 16-1161.03


SHEET TITLE:
FLOOR PLAN, ONE-LINE, &
SCHEDULE - FIRST FLOOR
ELECTRICAL POWER

EP-301

ROOM SCHEDULE Number Name CIRCULATION VESTIBULE CORRIDOR MENS WOMENS MEETING ROOM COATS STORAGE CHILDREN AREA CIRCULATION ADULT AREA TEEN AREA WORK ROOM OFFICE STUDY STUDY CORRIDOR

STORAGE

JANITORS CLOSET
BREAK ROOM
MECH / ELEC
BOOK DROP

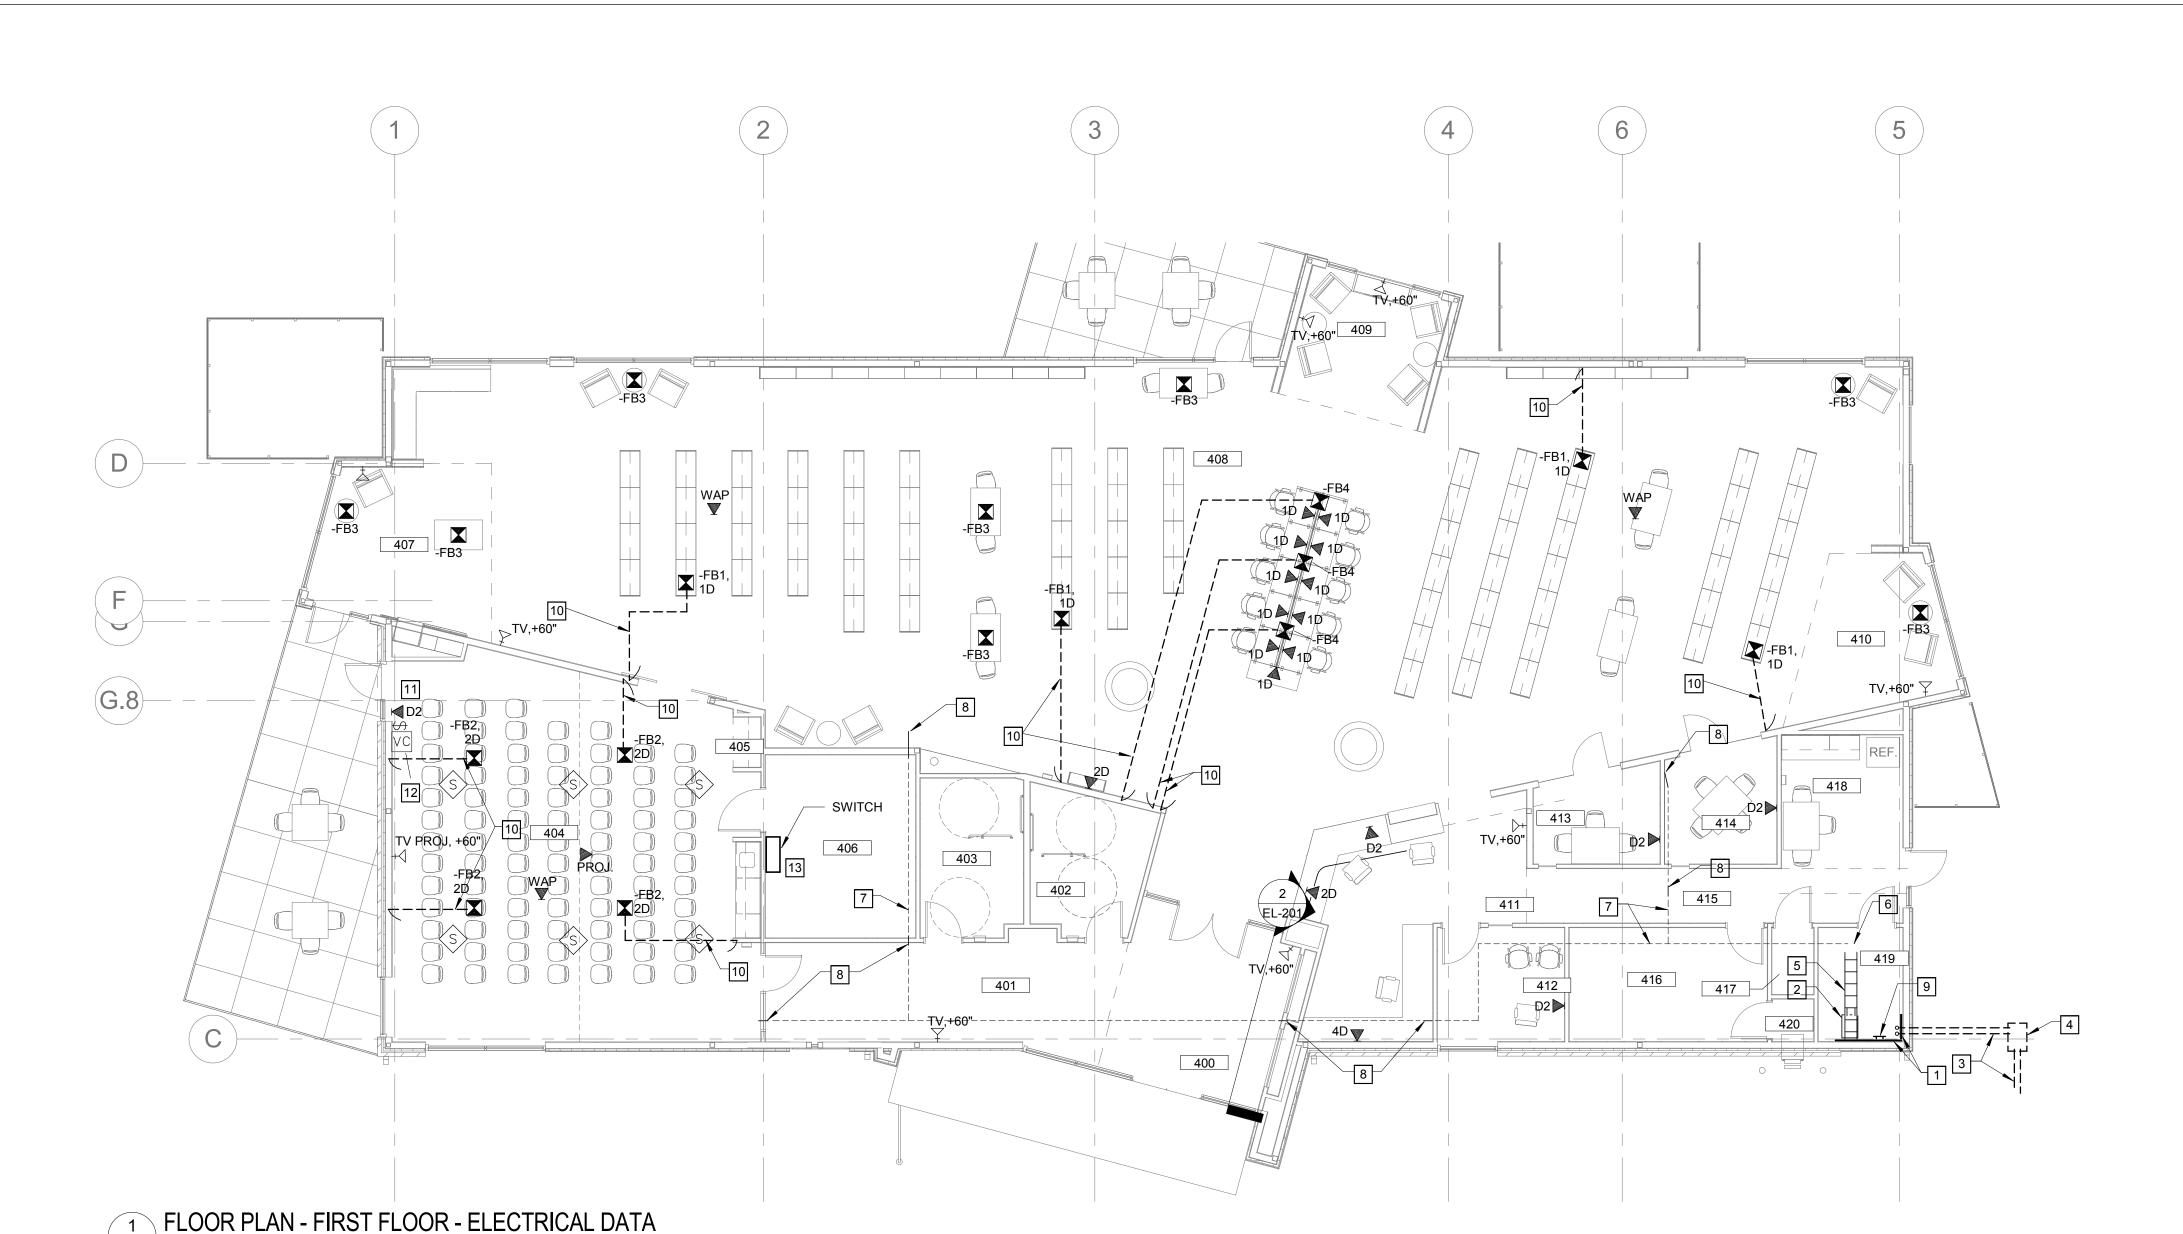

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No. Date

04/14/17	ISSUED FOR BID

Description

CIRCULATION	
VESTIBULE	
CORRIDOR	
MENS	
WOMENS	
MEETING ROOM	
COATS	
STORAGE	
CHILDREN AREA	DRAWN BY: TLK
CIRCULATION	
ADULT AREA	PROJECT NUMBER:
TEEN AREA	
WORK ROOM	SHEET TITLE:
OFFICE	FLOOR PLAN - FI
STUDY	ELECTRICAL DAT

ROOM SCHEDULE

STUDY CORRIDOR STORAGE

JANITORS CLOSET BREAK ROOM MECH / ELEC BOOK DROP

Name


Number

ECT NUMBER: **16-1161.03**

OR PLAN - FIRST FLOOR -CTRICAL DATA


KEYED NOTES

- 1 PROVIDE 3/4" PLYWOOD BACKBOARD FOR MOUNTING COMMUNICATIONS AND DATA EQUIPMENT. PLYWOOD SHALL BE FIRE RETARDANT UL LISTED PRODUCT. COVER WALL FROM 12" AFF TO 108" AFF.
- PROVIDE 7' TALL 45U 2-POST EQUIPMENT RACK FOR NETWORK AND COMMUNICATIONS EQUIPMENT. RACK SHALL HAVE THREE (3) 1U HORIZONTAL CABLE MANAGERS. MOUNT RACK WITH FRONT OF RACK FACING SOUTH.
- PROVIDE TWO (2) 2" UTILITY DUCTS FOR COMMUNICATIONS AND DATA SERVICES. DUCTS SHALL STUB UP 12" ABOVE FLOOR WHERE SHOWN. ROUTE FROM ROOM #115 TO UTILITY POLE AS DIRECTED BY SERVICE PROVIDERS, VERIFY.
- PROVIDE CAST FIBER CEMENT TYPE HAND HOLE WITH 2-BOLT GASKETED COVER SIMILAR TO HUBBELL #B10162230A AND COVER \$C10162202A. COORDINATE WITH GRADING CONTRACTOR AND ENSURE THAT BOX IS FLUSH WITH FINISHED SURFACE AND AREA ADJACENT TO BOX DRAINS AWAY
- PROVIDE LADDER STYLE CABLE RUNWAY ABOVE RACK SIMILAR TO CHATSWORTH PRODUCTS #10250-712. MOUNT RUNWAY ANCHORED TO TOP OF RACK AND ATTACH TO WALL WITH MANUFACTURERS APPROVED BRACKETS AND HARDWARE.
- 6 PROVIDE LADDER STYLE CABLE RUNWAY ABOVE RACK SIMILAR TO CHATSWORTH PRODUCTS #10250-712. MOUNT RUNWAY ANCHORED TO TOP OF RACK AND ATTACH TO WALL WITH MANUFACTURERS APPROVED BRACKETS AND HARDWARE.
- PROVIDE J-HOOK PATHWAY AT APPROX. 8" ABOVE LAY-IN CEILING FOR ROUTING NETWORK CABLING. J-HOOKS SHALL BE 4" WITH RETENTION CLIPS, PROVIDE QUANTITY AS REQUIRED. COORDINATE WITH ALL TRADES AND ADJUST EXACT ROUTING TO PROVIDE ADEQUATE CLEARANCE. ALL CABLING SHALL BE TRAINED, BUNDLED AND LASHED WITH RELEASABLE VELCRO STRAPS, NYLON CABLE TIES ARE NOT ACCEPTABLE. THE DESIGN INTENT IS THAT THIS PATH REPRESENTS A MAJOR ROUTING FOR THE MAJORITY OF CABLING, INDIVIDUAL DROPS AND BUNDLES OF LESS THAT SIX CABLES SHALL
- PROVIDE 4" CONDUIT SLEEVE ABOVE AREA WITH DRYWALL CEILING OR THROUGH WALLS EXTENDING TO DECK. CONDUITS SHALL HAVE BUSHINGS ON ENDS. COORDINATE WITH ALL TRADES AND ADJUST LOCATIONS TO PROVIDE ADEQUATE CLEARANCE. REFERENCE KEY NOTE #7 AND ALIGN
- PROVIDE TELECOMMUNICATIONS GROUND BUS FOR BONDING ALL METAL OBJECTS AND EQUIPMENT CHASSIS IN ROOM. BUS SHALL BE 12"x2"x1/4" THICK COPPER WIT PRE-DRILLED HOLES TO MEET ANSI/TIA 607-B STANDARDS. PROVIDE #2 CU BACKBONE BONDING CONDUCTOR CONNECTED TO ELECTRICAL SERVICE GROUNDING ELECTRODE. ALL BONDING CONDUCTORS SHALL TERMINATE TO BUS WITH TWO-HOLE COMPRESSION CRIMP LUGS SIZED FOR THE INDIVIDUAL CONDUCTORS. BOND RACK FRAME, CONDUIT SLEEVES, TRAY, EQUIPMENT AND ANY EXPOSED BUILDING STEEL TO BUS WITH #6 AWG COPPER WIRE WITH GREEN INSULATION.
- 10 PROVIDE 1-1/4" PVC CONDUIT FROM FLOOR BOX TO WALL AS SHOWN. CONDUIT SHALL RISE UP WALL AND STUB OUT INTO CEILING SPACE. ROUTE COMMUNICATIONS CABLING FROM BOX TO CEILING SPACE AND CONTINUE TO I.T. ROOM #115 SUPPORTED BY J-HOOKS.
- 11 PROVIDE HDMI OUTLET AND DATA IN FACE PLATE AT THE TV LOCATION AND DATA BOX. PROVIDE 1' CONDUIT FROM THE TV OUTLET BOX TO THE DATA (OC) BOX. PROVIDE HDMI CABLE BETWEEN THE TV OUTLET AND DATA OUTLET. PROVIDE TERMINATIONS FOR HDMI CABLE AT BOTH LOCATIONS.
- 12 PROVIDE AV SPEAKER VOLUME CONTROLLER AND AV CONTROLLER. SEE DETAILS ON SHEET E-600. COORDINATE LOCATIONS WITH POWER AND LIGHTING CONTROL DEVICE.
- 13 PROVIDE AV SYSTEM SWITCH ON WALL. SEE DETAIL SHEET E-600.

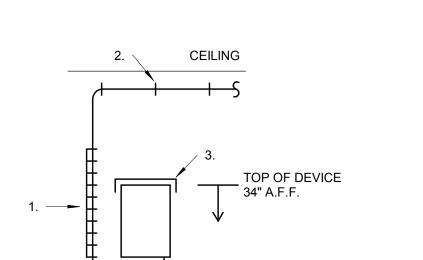

1) PROVIDE CABLE MANAGEMENT SIMILAR TO LEGRAND CABLE FILL G-MINI FROM CABLE SIDE OF SWITCHER TO CEILING. 2) PROVIDE 1-1/2" O-RINGS TO SUPPORT CABLE ABOVE CEILING. 3) PROVIDE VERTICAL MOUNT FOR SWITCHER.


2 AV SWITCH ELEVATIONS E-801 N.T.S.

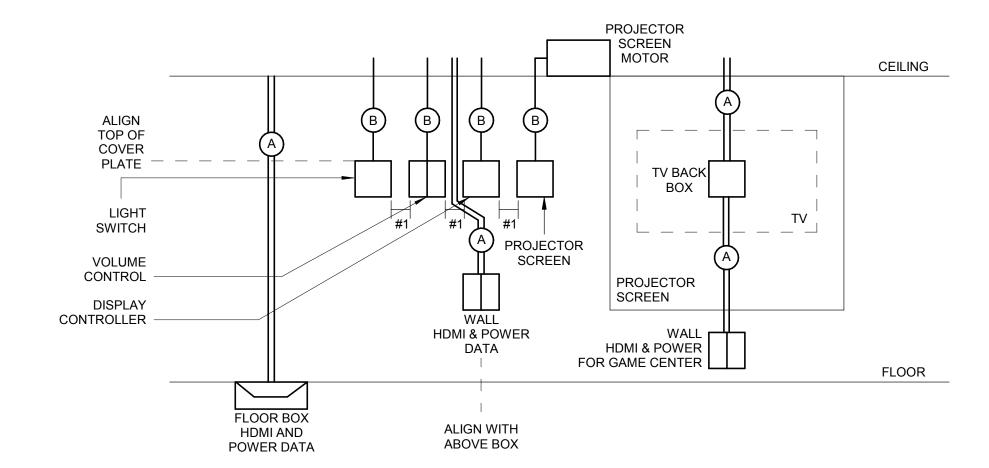


#1) SPACE BACK BOX SO THAT THERE IS 1" BETWEEN EACH COVER PLATE. PROVIDE THE REQUIRED BLOCKING TO MOUNT BOXES.

	CONDUIT SI	<u> </u>
TYPE	POWER	TYPE
A	(1) 3/4"	(1)1- 1/4"
В	-	(1)3/4"
©	(1) 3/4"	-

1 AV DEVICE LAYOUT

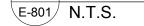


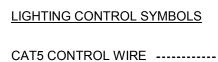

120V CONDUCTORS ———— 0-10V WIRE ____ LOAD CONTROLLER

LIGHT FIXTURE LOWER CASE IS SWITCH LEG

LOW VOLTAGE SWITCH AND SWITCH NUMBER ### CEILING OCCUPANCY SENSOR

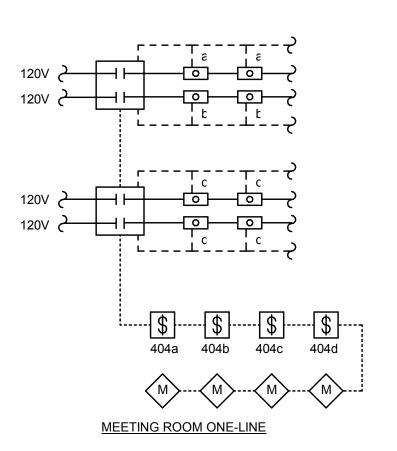


ME	MEETING ROOM CONTROL						
	NTROL EVICE	BUTTONS	CIRCUIT CONTROL	CONTROL TYPE			
\$	404a	a b	a,b,c,d FUTURE	ALL ON/OFF - 100%			
\$	404b	a b	a,b FUTURE	ALL ON/OFF - 100%			
\$	404c	a b c d	c,d c d DIMMING	c,d - ON/OFF - 100% c - ON/OFF - 100% d - ON/OFF - 100% DIM SELECTED			
\$	404d	a b c d e f	a,b,c,d a b c d DIMMING	a,b,c,d - ON/OFF - 100% a - ON/OFF - 100% b - ON/OFF - 100% c - ON/OFF - 100% d - ON/OFF - 100% DIM SELECTED			
	^	OCCUPANC'	Y SENSOR SH	IALL BE SET UP AS A			

VACANCY SENSOR, TO TURN OFF THE LIGHTS IN

THE ROOM AFTER 30 MINUTES OF NO

OCCUPANCIES SENSOR.

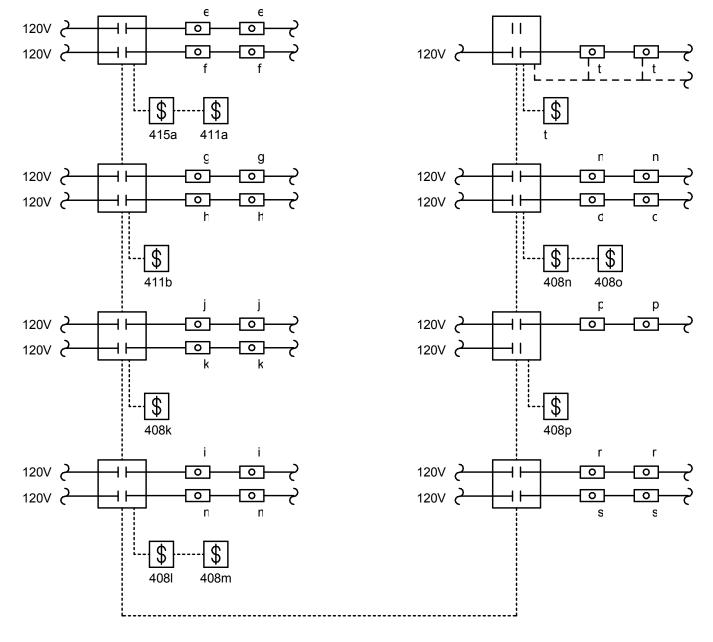


VESTIBULE, WORK ROOM, CIRCULATION ONE-LINE

MEETING ROOM CONTROL

ONTROL DEVICE	BUTTONS	CIRCUIT CONTROL	CONTROL TYPE			
\$ 415a	а	е	ALL - ON/OFF - 100%			
\$ 411a	a b	e f	e - ON/OFF - 100% f - ON/OFF - 100%			
\$ 411b	a b c d e j	g,h,j,k,l,m,n,o,p,q,r,s g h s r j	ALL - ON/OFF - 100% g - ON/OFF - 100% h - ON/OFF - 100% s - ON/OFF - 100% r - ON/OFF - 100% j - ON/OFF - 100%			
\$ 408k	а	k	k - ON/OFF - 100%			
\$ 4081	а	1	I - ON/OFF - 100%			
\$ 408m	а	m	m - ON/OFF - 100%			
\$ 408n	а	n	n - ON/OFF - 100%			
\$ 408o	а	0	o - ON/OFF - 100%			
\$ 408p	а	р	p - ON/OFF - 100%			
\$ t	a b	t DIMMER	t - ON/OFF - 100%\ DIM t SWITH LEG			
ALL LIGHTS SHALL BE CONTROLLED WITH A TIME CLOCK. COORDINATE HOURS WITH OWNER.						

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- VOLUME CONTROLLER- LOWELL 2SLVC

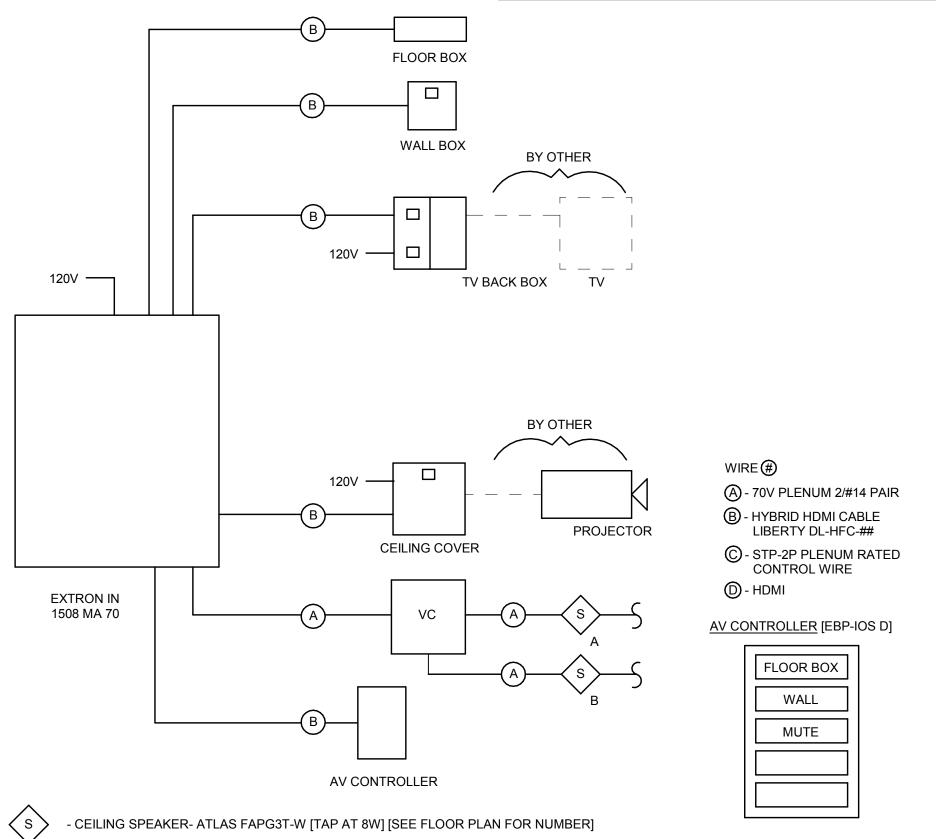4 A / V WIRE DIAGRAM E-801 N.T.S.

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ENGINEER OF RECORD:

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Description 04/14/17 ISSUED FOR BID

DRAWN BY: **TLK** PROJECT NUMBER: 16-1161.03

DETAILS - ELECTRICAL

3 LIGHTING CONTROLS DIAGRAM

E-801 N.T.S.


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										ME	ECHANIC	AL EQU	IPMEN	ELECTR	ICAL	DATA	SCHE	EDULE					
PLAN MARK				STARTER						DISCONNECT						CONTROL DEVICE							
	DISCRIPTION / LOCATION	HORSEPOWER	APPARENT LOAD	VOLTAGE	PHASE	NEMA ENCL TYPE	FURNISHED BY	INSTALLED BY	TYPE	NEMA TYPE	AUXILIARY CONTACTS	LOCATION	FURNISHED	BY INSTALLED B	/ TYPE	SWITCH SIZE	FUSE SIZE	LOCATION	N FURNISHED BY	Y WIRE BY	PANEL	FEEDER SIZE / RACEWAY	REMARKS
1		1	1	1									1			1		1		-	1		
U 1	AIR HANDLER		28080 VA	208 V	3	NEMA 3R	EM	EM		-		IN UNIT IN UNIT	EC	EC	-	100 AMP	-	ON WALL	MC	MC	MAIN	(3)#1,(1)#8, 1 1/4"C.	
HU 2	AIR HANDLER			208 V	3	NEMA 3R	EM	EM		-		IN UNIT	EC	EC	-	60 AMP	-	ON WALL	MC	MC	MAIN	(3)#8,(1)#10, 1"C	
1	CONDENSING UNIT		3931 VA	208 V	1	NEMA 3R	EM	EM	- -	-	[1	IN UNIT	EC	EC	-	30 AMP	-	ON WALL	MC	MC	MAIN	(2)#8,(1)#10, 1"C.	
VH 1	WATER HEATER		5500 VA	208 V	3	NEMA 1	EM	EM		-		IN UNIT	EC	EC	-	30 AMP	-	ON WALL	MC	MC	MAIN	(3)#10,(1)#10, 3/4"C.	
1	FAN COIL		1140 VA	120 V	1	NEMA 1	EM	EM		-	. [1	IN UNIT	EC	EC	-	30 AMP	_	ON WALL	MC	MC	MAIN	(2)#12,(1)#12, 3/4"C.	

LEGEND

TS - TOGGLE SWITCH

EC - ELECTRICAL CONTRACTOR
EM - EQUIPMENT MANUFACTURER
FVNR - FULL VOLTAGE NON REVERSING
MC - MECHANICAL CONTRACTOR
NF - NON FUSED
NI - NON INTERRUPTING
NO/NC - NORMALLY OPEN/NORMALLY CLOSED

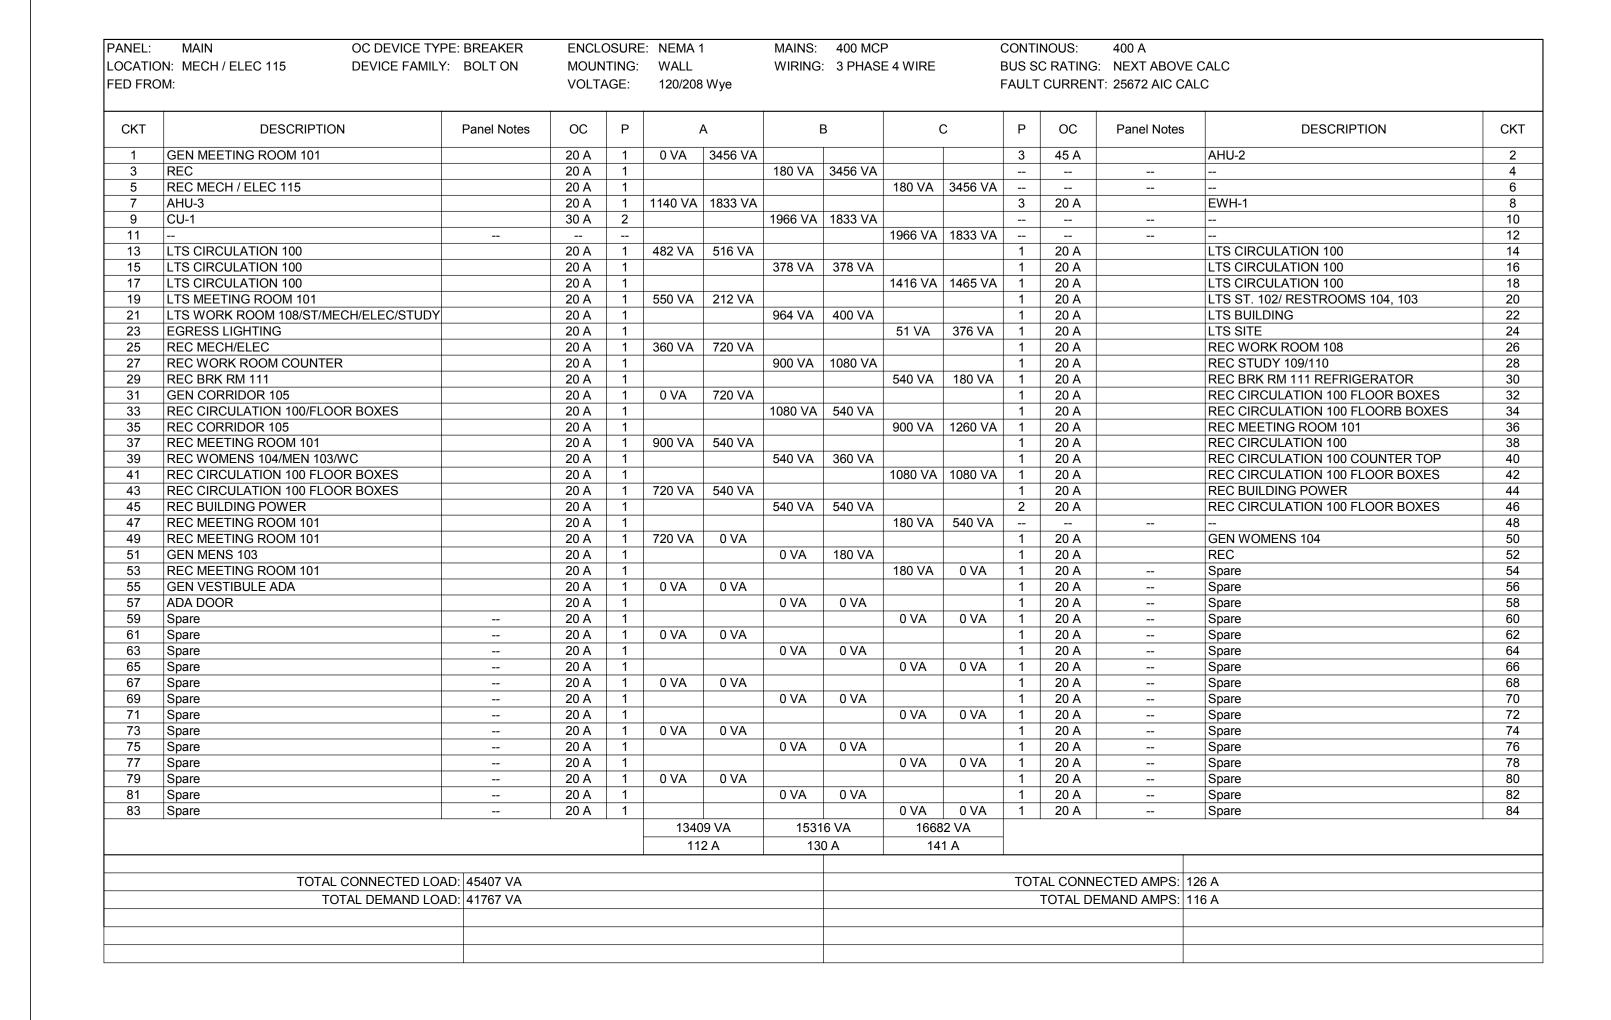

Scenic Regional Library

SCENIC REGIONAL
LIBRARY
WRIGHT CITY BRANCH
60 WILDCAT DRIVE
WRIGHT CITY, MO 63390



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MECHANICAL, ELECTRICAL, PLUMBING

ENGINEER OF RECORD:

PRELIMINARY NOT FOR CONSTRUCTION

Description

TODD L. KUNO MO. LICENSE NO. 2015017018 BRIC MO CERTIFICATE OF AUTHORITY 2002028690

No. Date

04/14/17	ISSUED FOR BID

PROJECT NUMBER: 16-1161.03

SHEET TITLE:
SCHEDULES - ELECTRICAL

E-901